

#### The current proposal is:

Preservation Department – Item 3, LPC-23-08409

## 74 Wellington Court – Fiske Terrace-Midwood Park

Historic District
Borough of Brooklyn

To testify virtually, please join Zoom

Webinar ID: 870 9410 2125

Passcode: 613401

By Phone: 1 646-558-8656 US (New

York) 877-853-5257 (Toll free) US

888 475 4499 (Toll free)

**Note**: If you want to testify virtually on an item, join the Zoom webinar at the agenda's "Be Here by" time (about an hour in advance). When the Chair indicates it's time to testify, "raise your hand" via the Zoom app if you want to speak (\*9 on the phone). Those who signed up in advance will be called first.

## 74 WELLINGTON CT, BROOKLYN, NY 11230

#### PROPERTY INFORMATION:

ZONE: R2 B.I.N.: 3253659 MAP#: 22C C.B.#: 314

FISKE TERRACE-MIDWOOD PARK HISTORIC DISTRICT: LP-2208

DESIGNATION DATE: MARCH 18 2008

CONSTRUCTION DATE: C. 1905

A. WHITE PIERCE ARCHITECT/BUILDER:

STYLE: COLONIAL REVIVAL WITH ALTERATIONS WOOD FRAME, BRICK, WOOD SHINGLES, BRICK MATERIAL:

**BUILDING CODE:** 1968 CODE

OCCUPANCY GROUP: R-1 (SINGLE-FAMILY DETACHED)


CONSTRUCTION CLASS:

LOT FRONTAGE: 117.5 LF 115 LF LOT DEPTH: LOT AREA: 13,513 SQ.FT.

NO. OF STORIES: 2.75-STORY



**BUILDING HISTORIC PHOTO** 

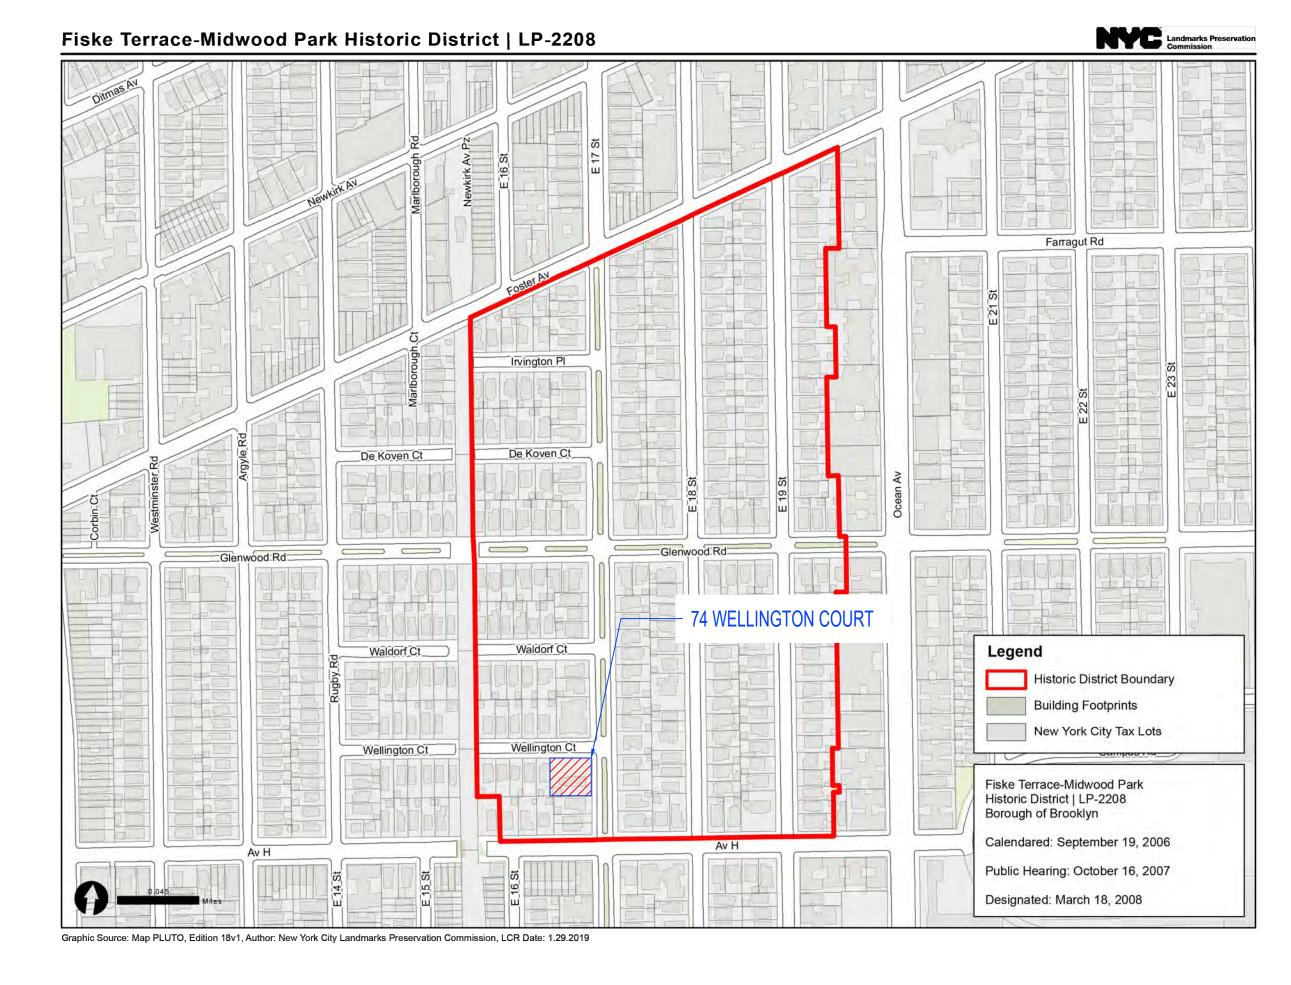

#### HISTORIC DISTRICT PROPERTY LOCATION MAP









'I Leonard Street, New York, NY 10013 Telephone: 212.226.6816 Email: info@aedsinc.com 74 WELLINGTON COURT

M.R. & A.S

NOTE: AE Design Solution Inc and its principal / employees were not retained for any supervision of the

actual construction of this project.

**EXISTING BUILDING FRONT VIEW** 


**EXISTING BUILDING SIDE VIEW** 

## EXISTING BUILDING AERIAL PLAN FRAME GARAGE ADJACENT BUILDING 824 EAST 17TH STREET FRAME GARAGE FRAME **EXISTING** FRAME HOUSE NO: 74 BLOCK:6691 LOT 38 1-FAMILY RES. BUILDING 2 STORIES W/ ATTIC. WELLINGTON COURT **(5)** LEGEND # PHOTO TAG


### STREET VIEW OF EXISTING BUILDING & ADJACENT BUILDINGS



**#1** 824 E 17 ST ADJACENT BUILDING

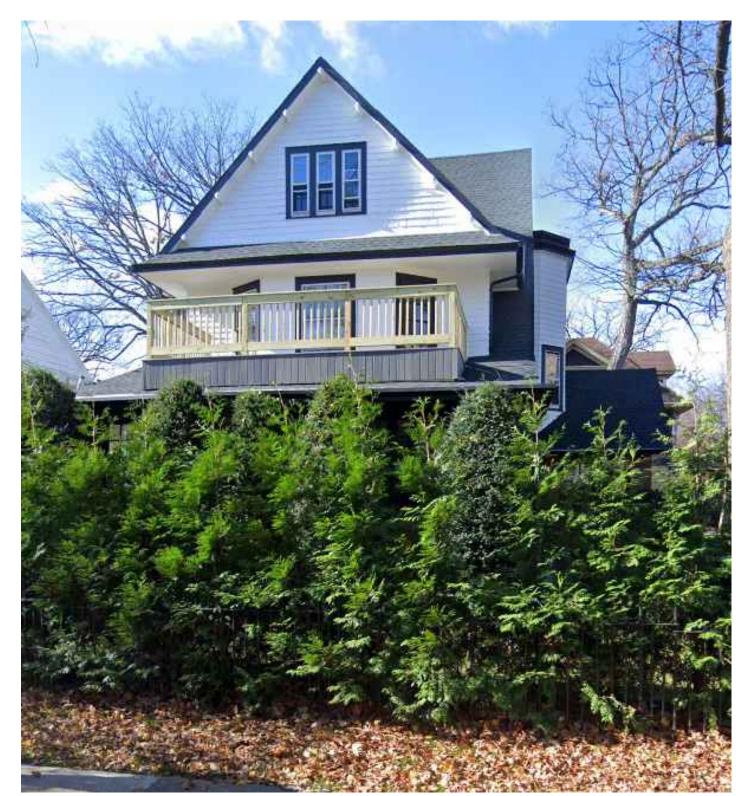

**#2** 74 WELLINGTON CT EXISTING BUILDING SIDE VIEW @ EAST 17 ST

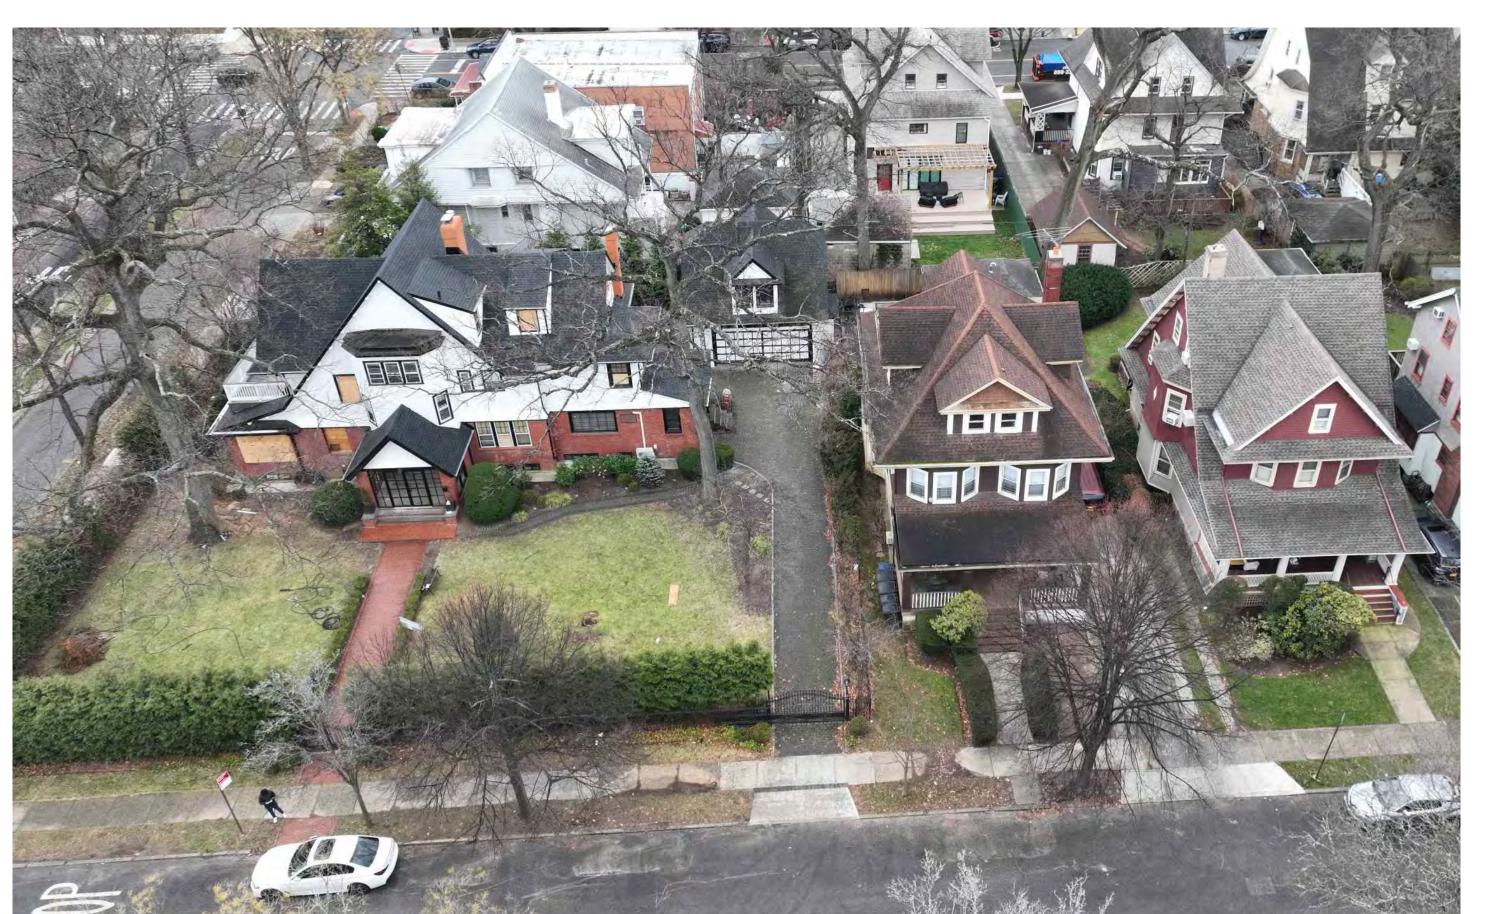

**#3** 74 WELLINGTON CT **EXISTING BUILDING FRONT** 

#4 66 WELLINGTON CT ADJACENT BUILDING



74 WELLINGTON COURT BROOKLYN, NY 11230 *Drawn By:* Y.Z.

Checked By: M.R. & A.S


04/15/2024

71 Leonard Street, New York, NY 10013 Telephone: 212.226.6816 Email: info@aedsinc.com

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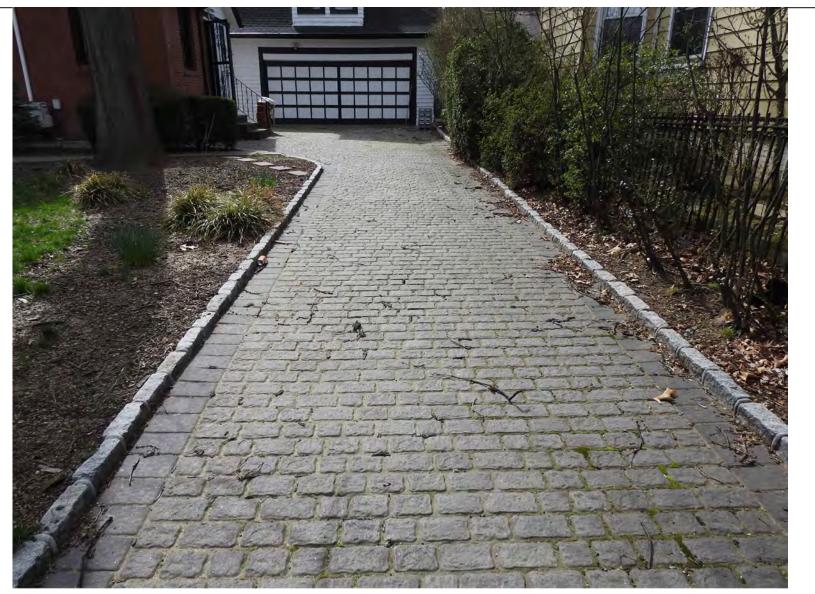
As Noted

## LEGALIZE THE VIOLATIONS OF (23-0501,23-0502, 23-0503, 23-0504)



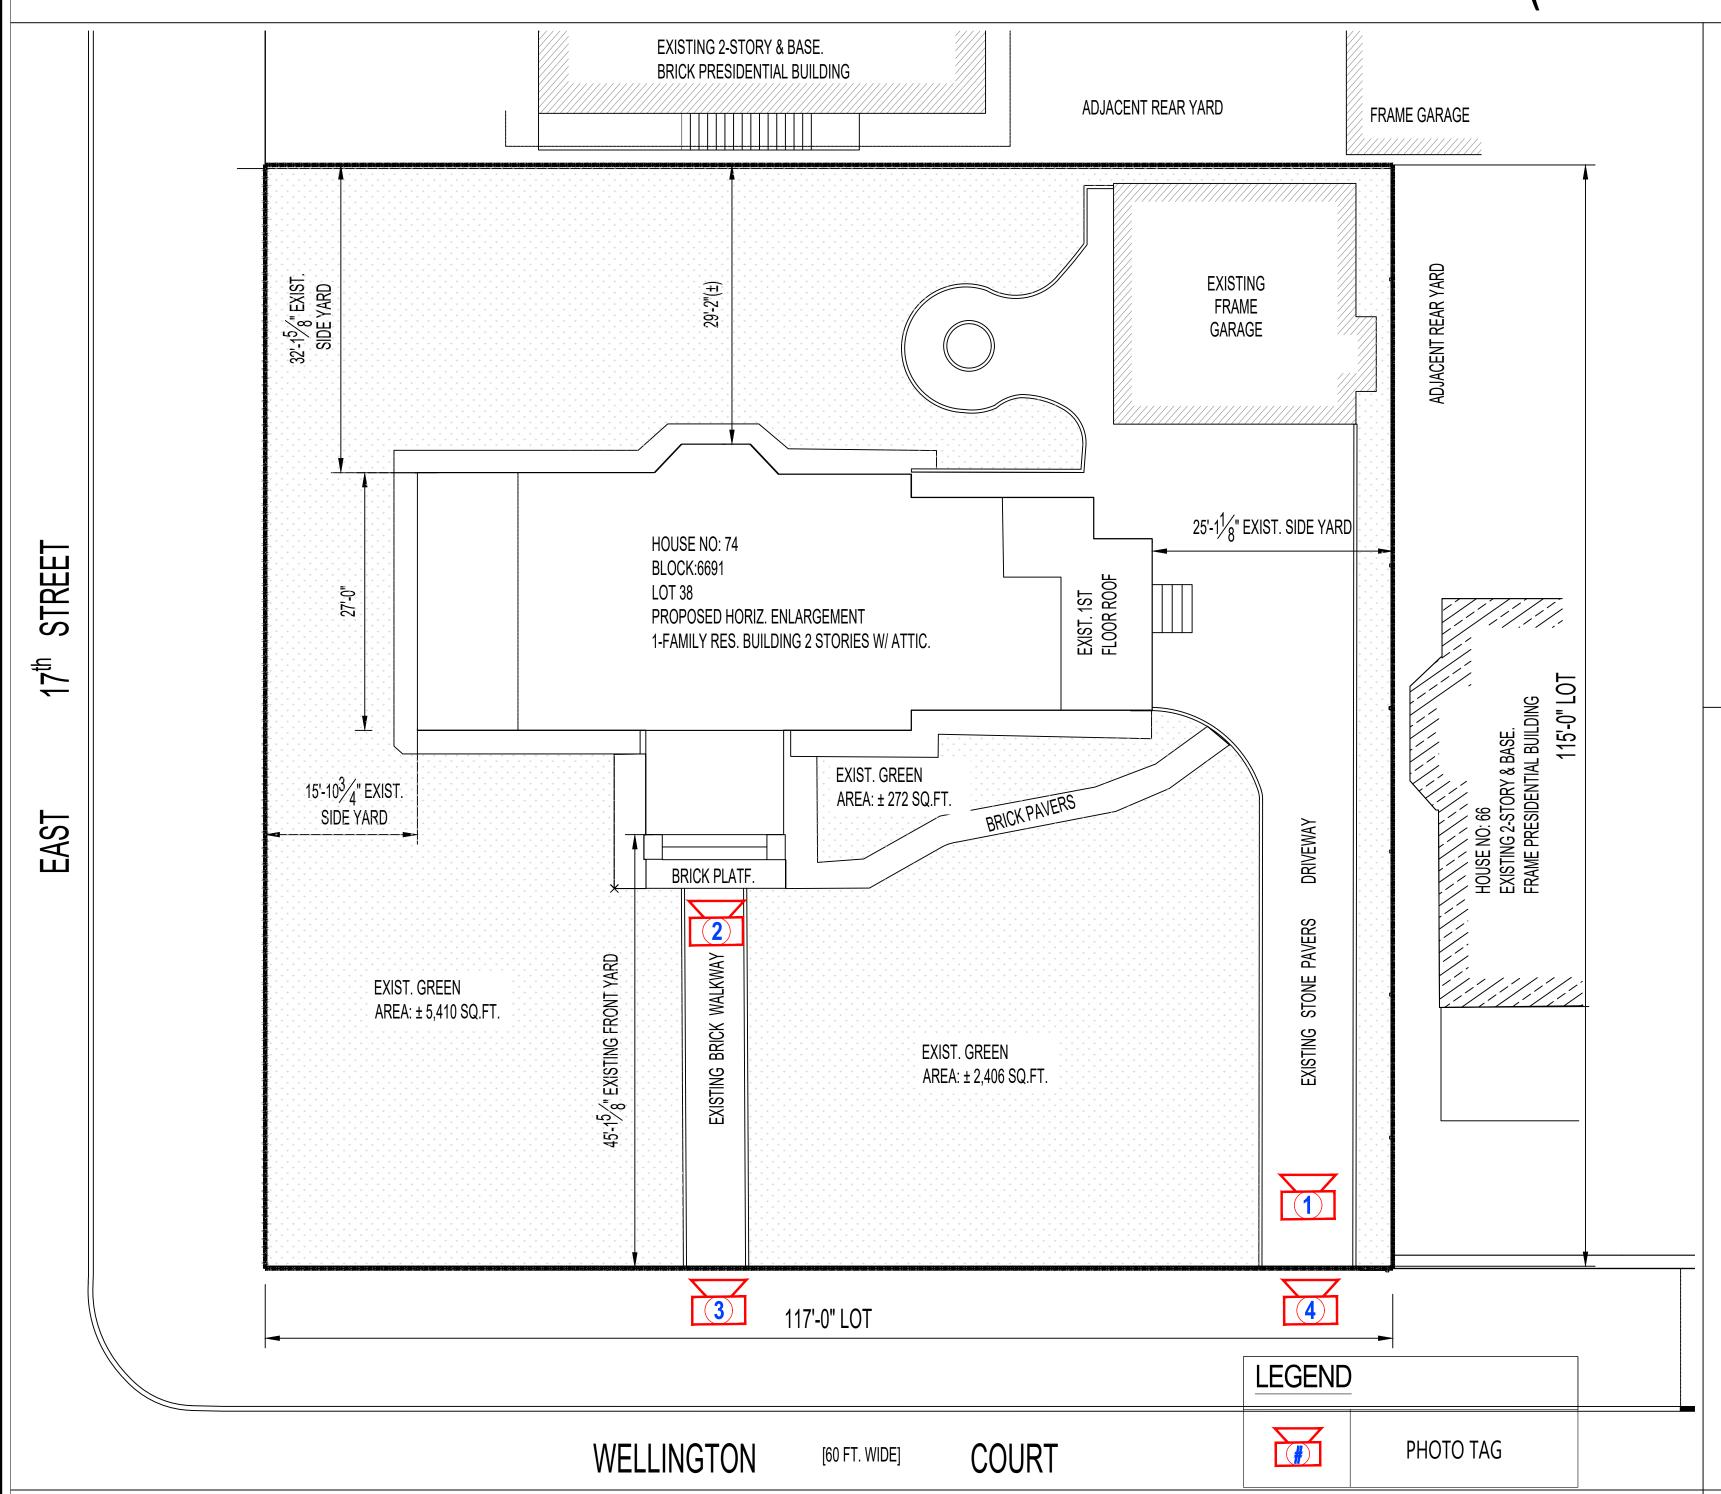





DRIVEWAY PAVEMENT CHANGED IN 2020 (PHOTO FROM GOOGLE VIEW IN 2020)



ORIGINAL FRONT ENTRANCE & STEPS




FRONT ENTRANCE & STEP CHANGE IN 2020





ORIGINAL FRONT ENTRANCE GATE



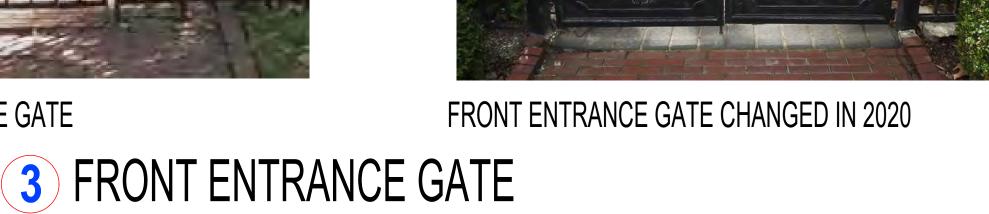




ORIGINAL DRIVEWAY ENTRANCE GATE



DRIVEWAY ENTRANCE GATE CHANGED IN 2020



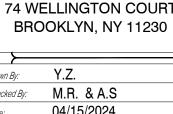





EAST FACADE DESIGNATION PHOTO





PROPOSED EAST FACADE RENDERING

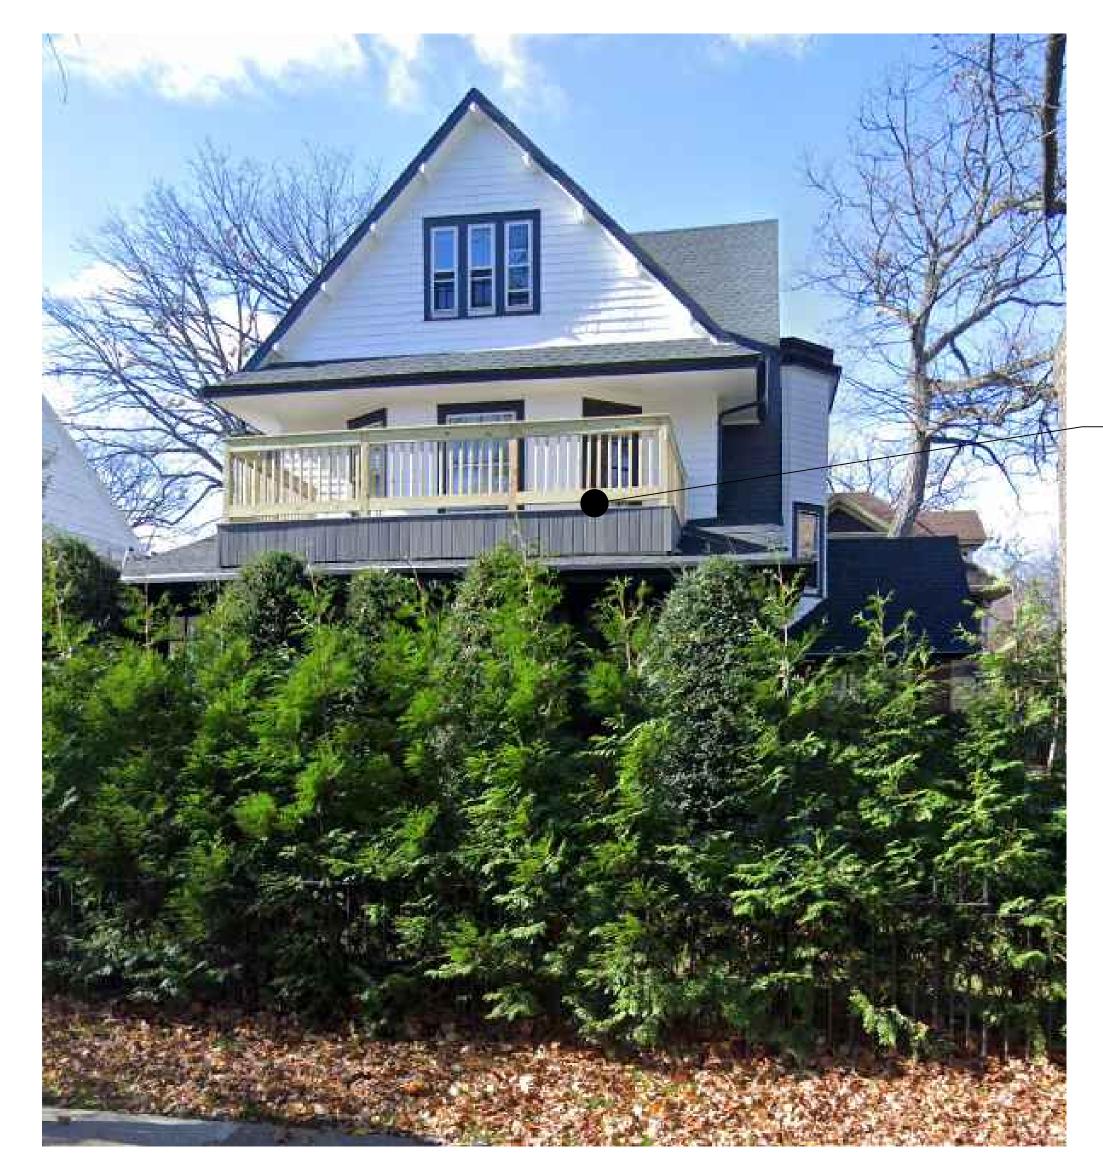

EAST FACADE EXISTING CONDITION PHOTO

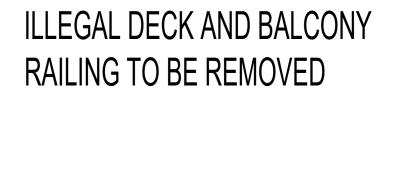

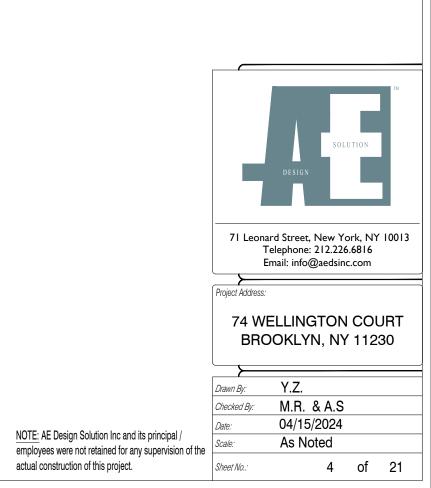


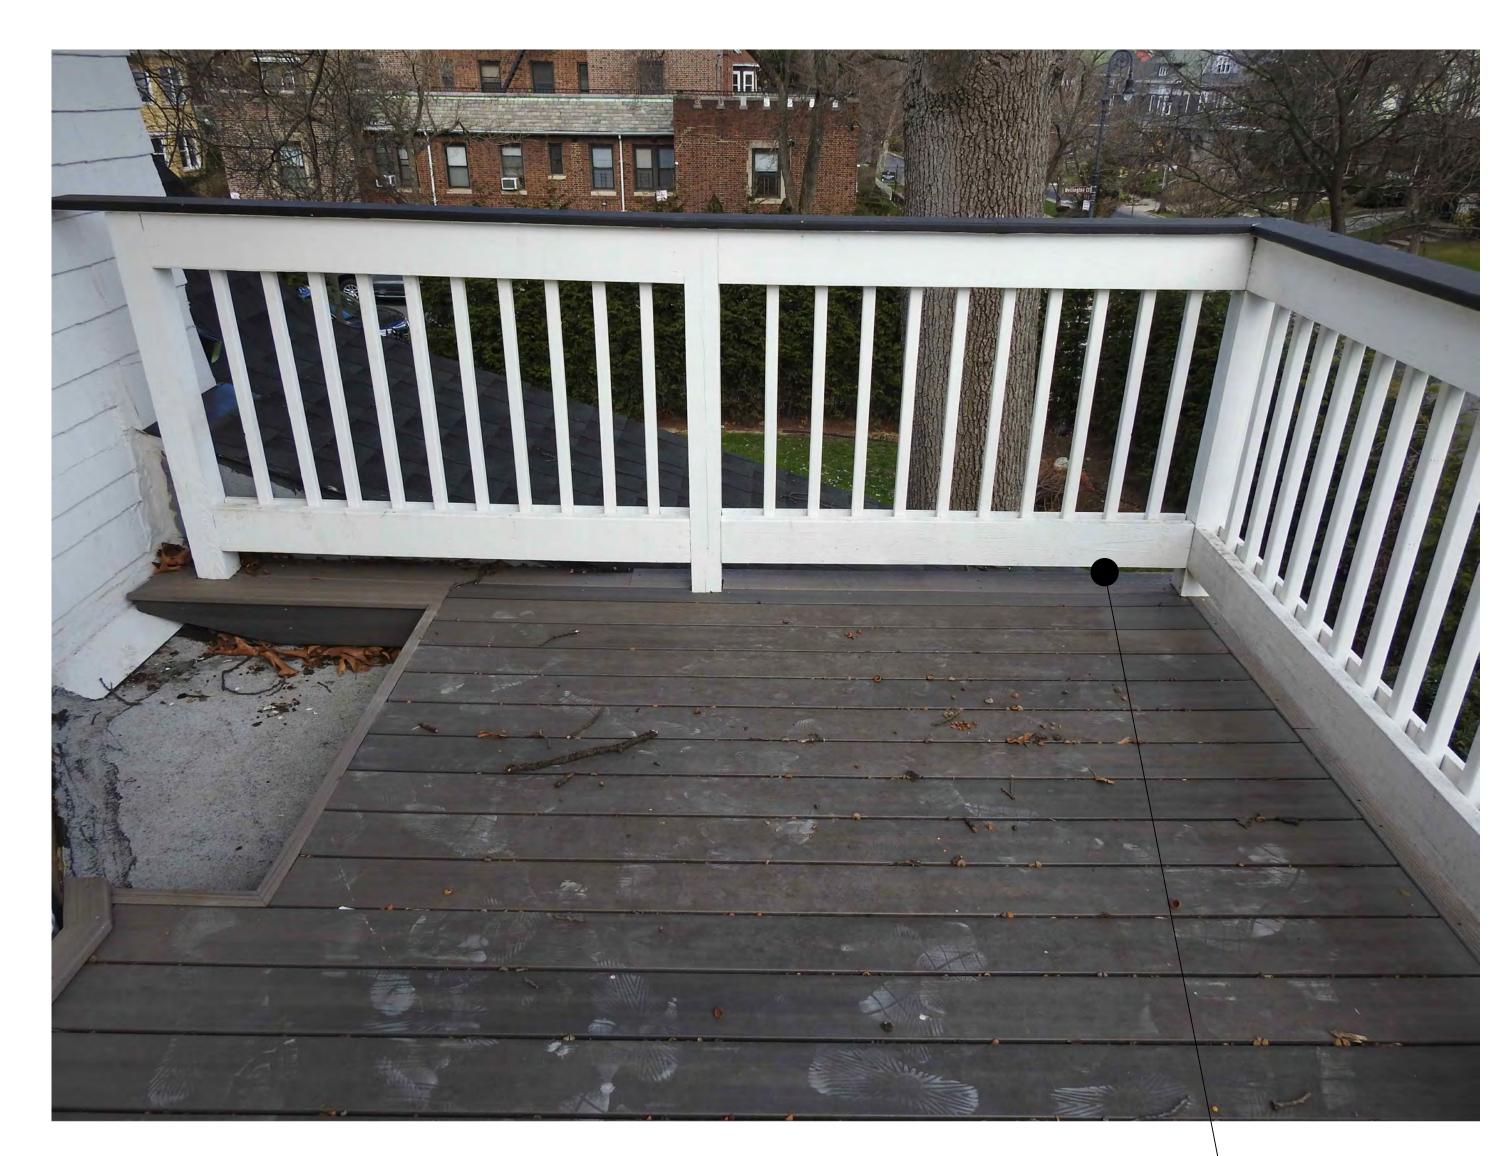

EAST FACADE - VIEW FROM EXISTING ILLEGAL WOOD DECK & BALCONY RAILINGS TO INTERIOR (PHOTO FACING EAST & FRONT/NORTH FACADE)



EAST FACADE - VIEW OF ROOF LINE OVER DECK/RAILINGS FACING THE NORTH/FRONT FACADE

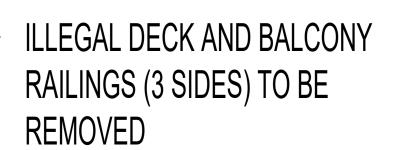



EAST FACADE - VIEW FROM EXISTING ILLEGAL WOOD DECK & BALCONY RAILINGS TO INTERIOR (PHOTO FACING EAST & REAR/SOUTH FACADE)



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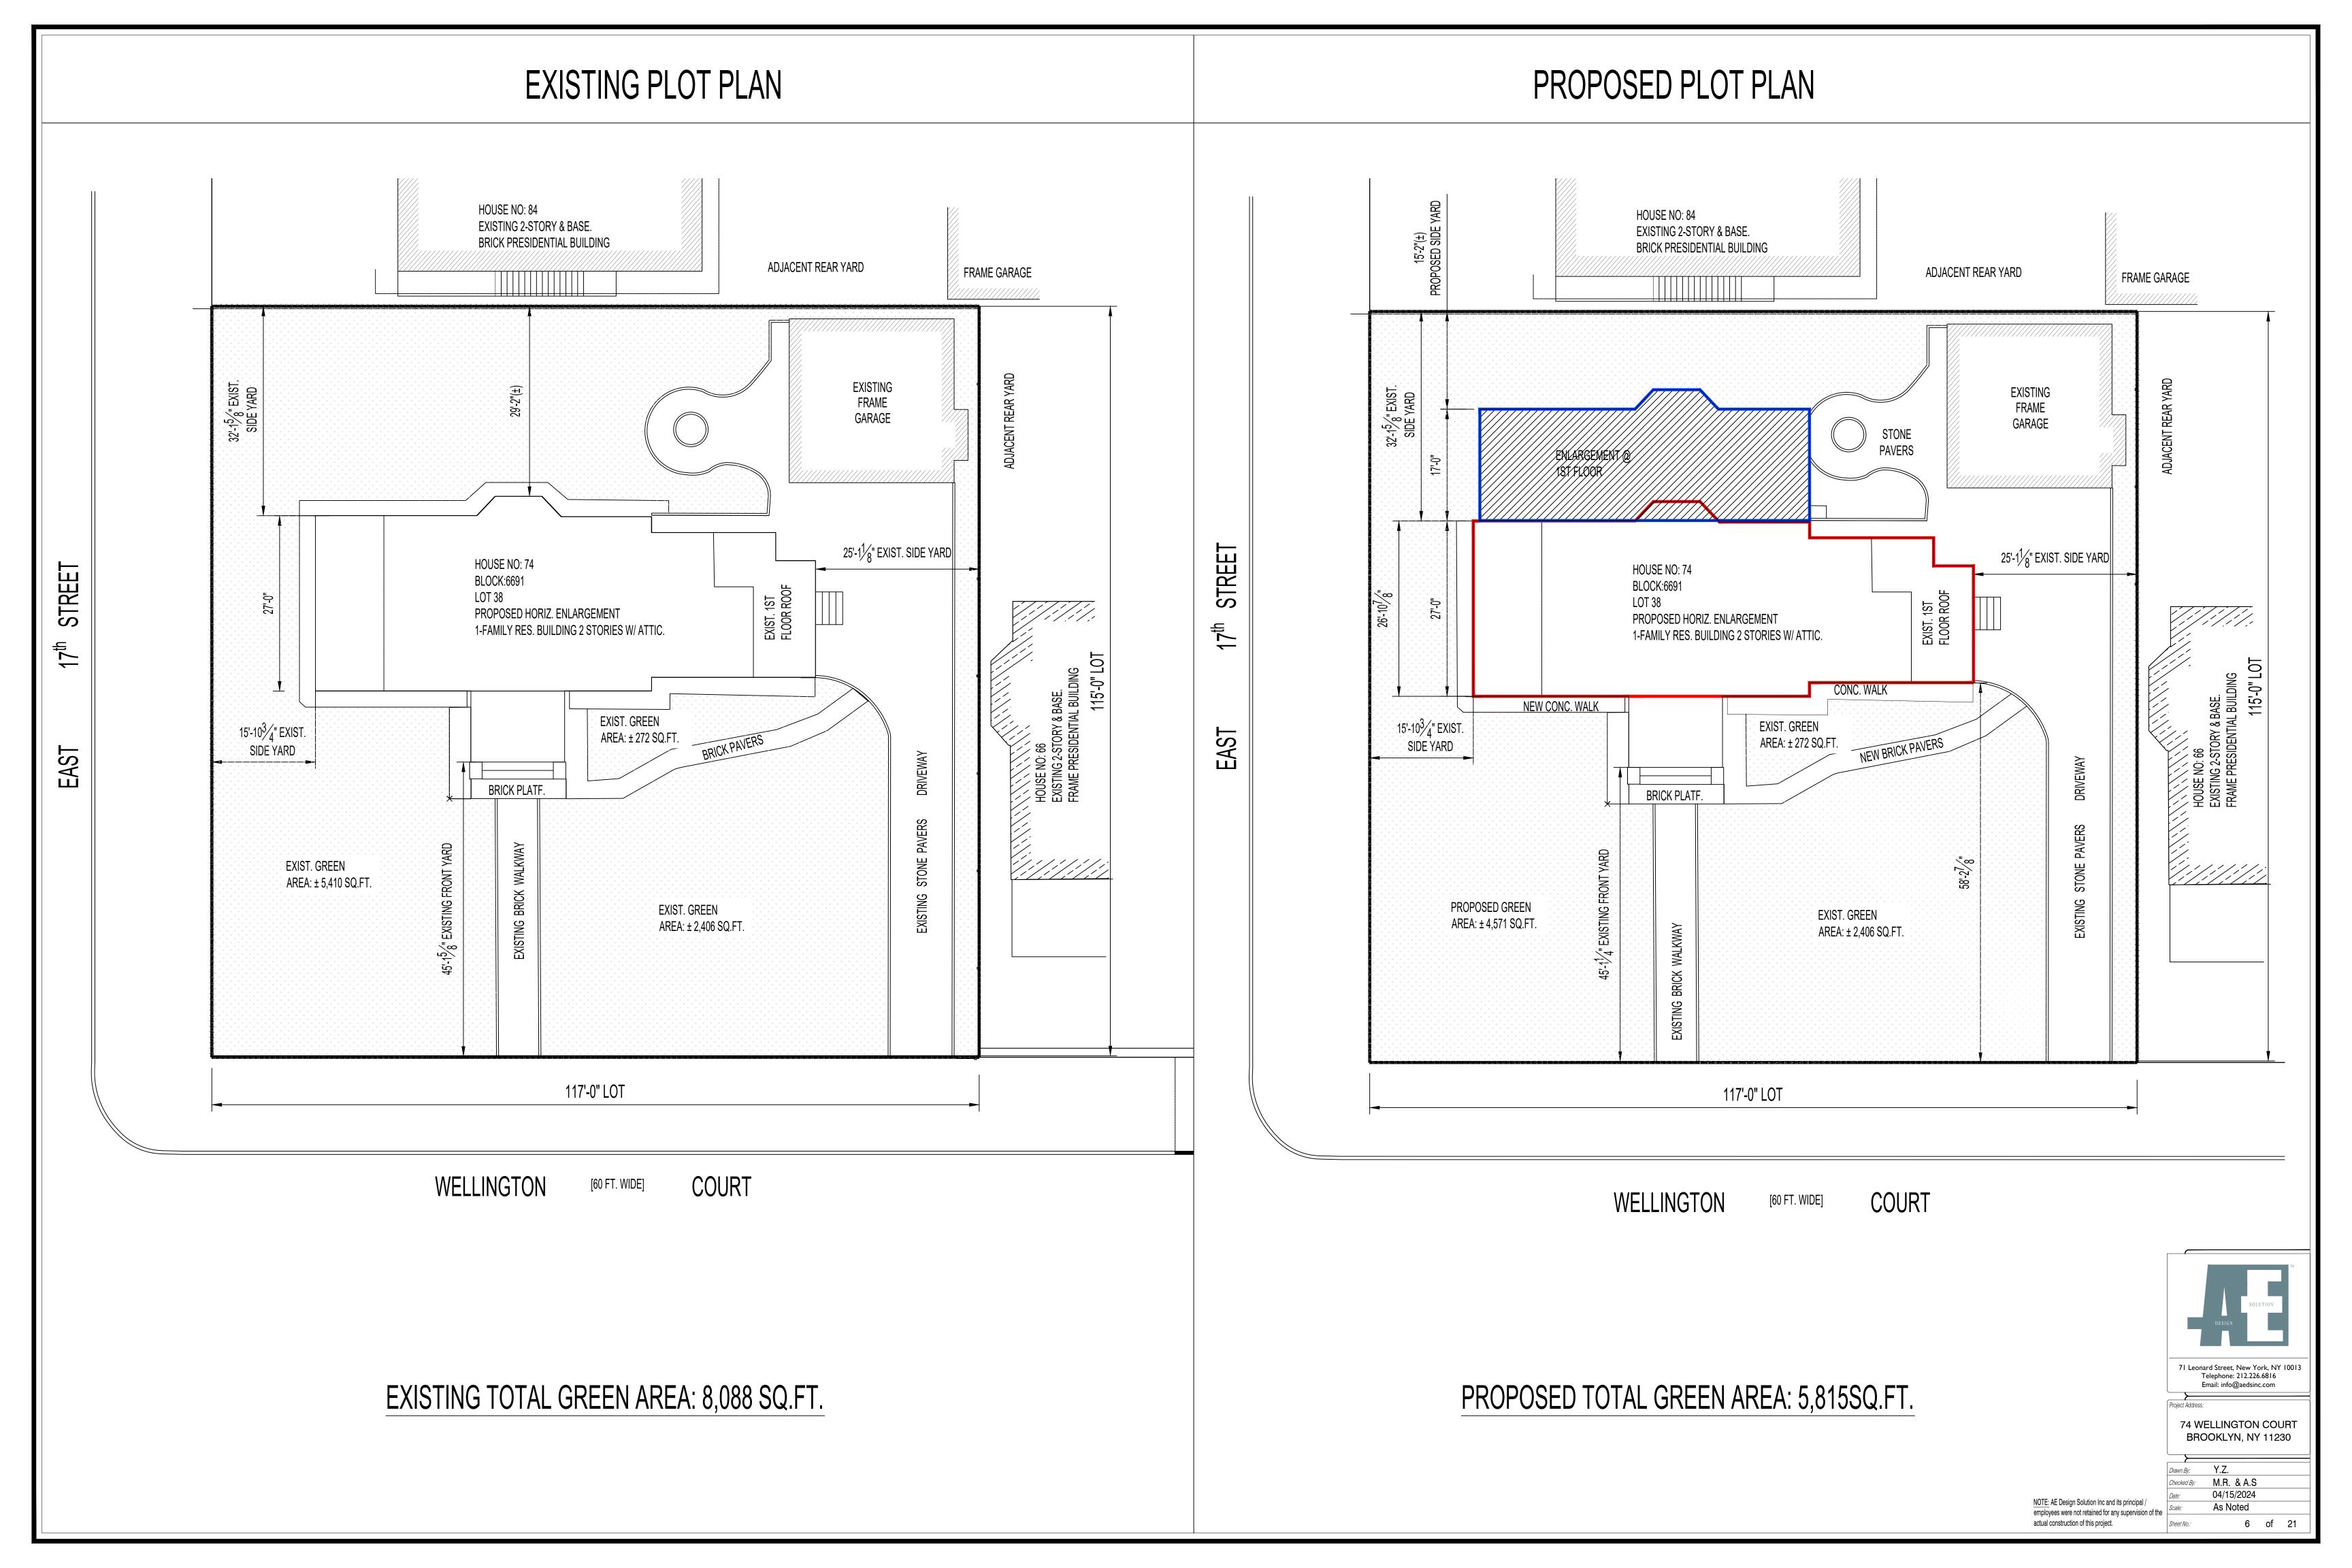
tition Inc and its principal /
Scale:

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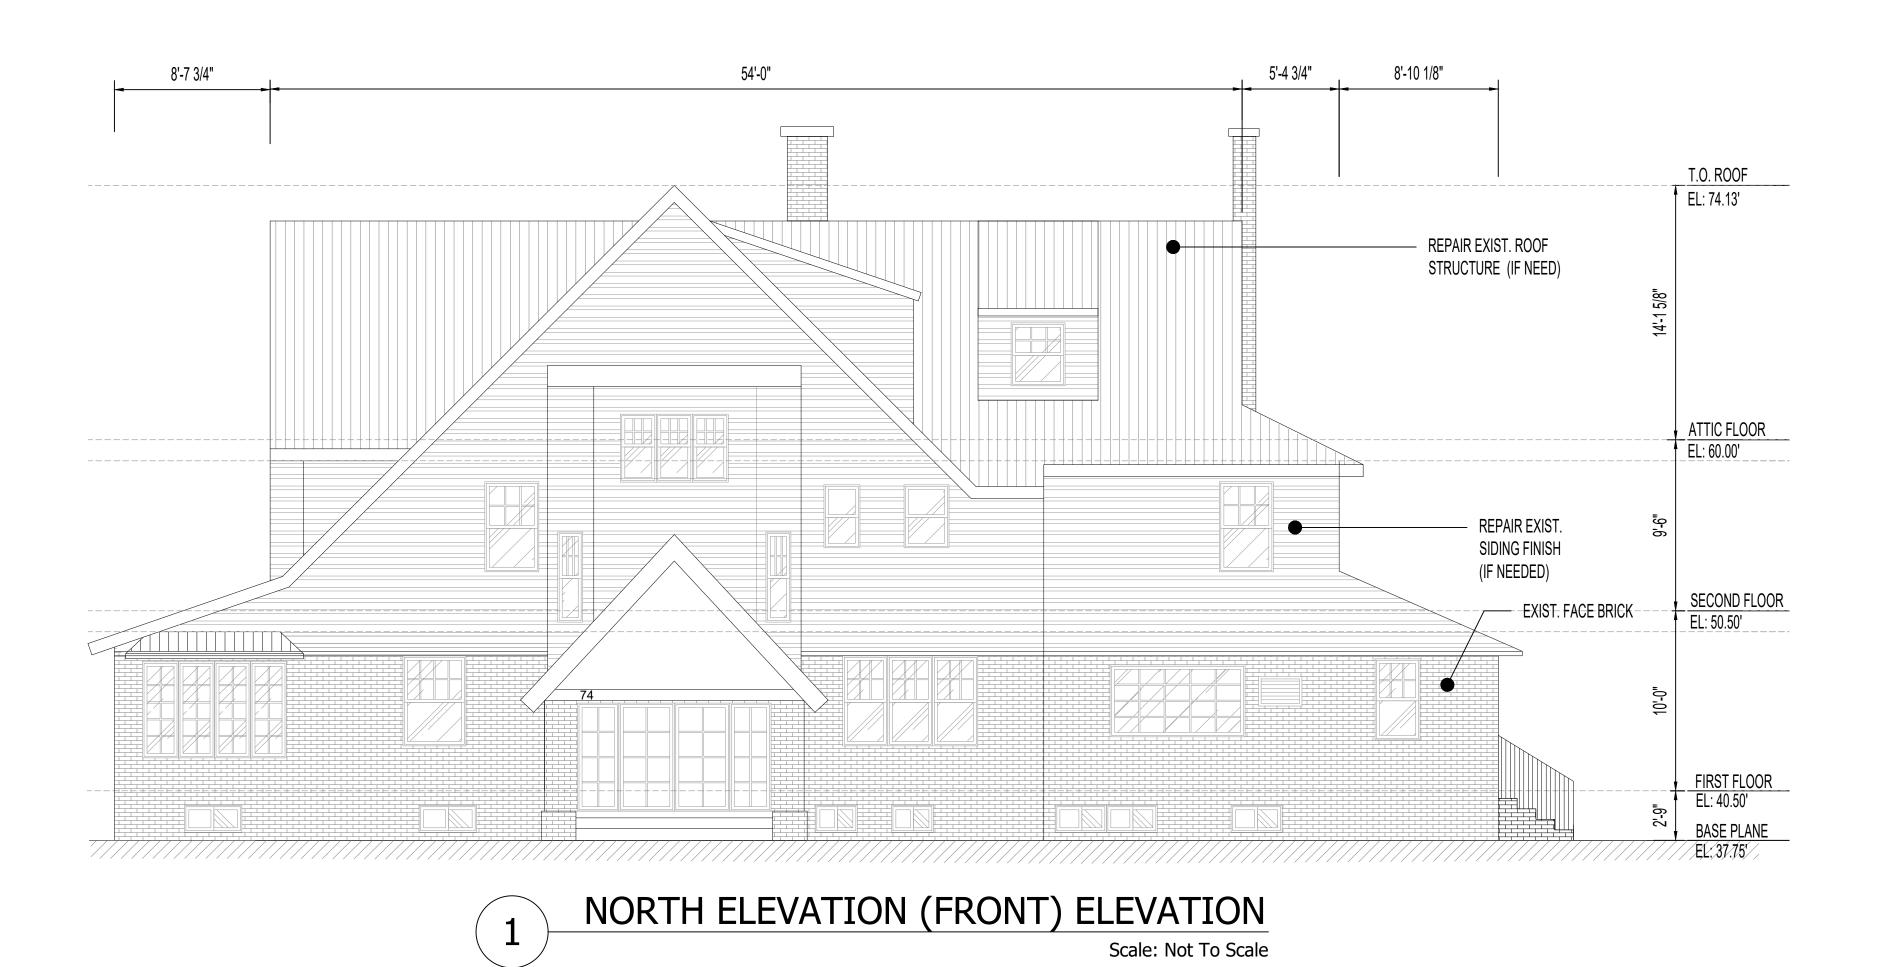
As Noted

Sheet No.:

5 of




## NORTH ELEVATION (FRONT)



NO CHANGE



EXISTING BUILDING FRONT PHOTO

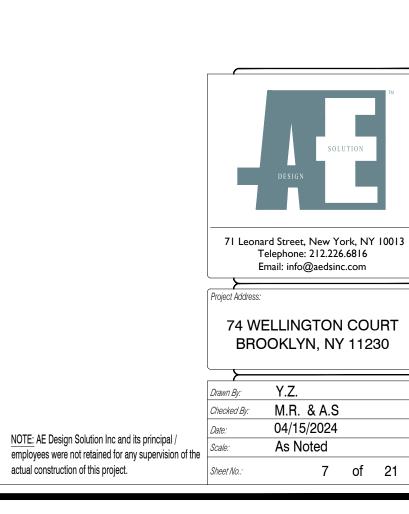

KEY PLAN:

ENLARGEMENT

**EXISTING** 




#### EXISTING EAST ELEVATION (LEFT SIDE) PROPOSED EAST ELEVATION (LEFT SIDE) KEY PLAN: KEY PLAN: ENLARGEMENT 3 **EXISTING** 3 **EXISTING** EXTENSION - EXISTING 29'-8" T.O. ROOF EL: 74.13' T.O. ROOF EL: 74.13' REPAIR EXIST. ROOF REPAIR EXIST. ROOF STRUCTURE (IF NEED) STRUCTURE (IF NEED) EXIST. SIDING -TYP. EXIST. SIDING -TYP. REMOVE ILLEGAL DECK AND BALCONY RAILING REPAIR EXIST. ROOF - REPAIR EXIST. ROOF STRUCTURE (IF NEED) 10'-1" ATTIC FLOOR EL: 60.00' ATTIC FLOOR EL: 60.00' SECOND FLOOR EL: 50.50' SECOND FLOOR EL: 50.50' EXIST. FACE BRICK, TYP. TEXTURE & COLOR TO EXIST. FACE BRICK, TYP. TEXTURE & COLOR TO MATCH EXISTING MATCH EXISTING FIRST FLOOR EL: 40.50' NEW FACE BRICK TEXTURE AND COLOR TO MATCH EXIST. EAST ELEVATION (SIDE) ELEVATION EAST ELEVATION (SIDE) ELEVATION Scale: 1/8"=1'-0" 71 Leonard Street, New York, NY 10013 Telephone: 212.226.6816 Email: info@aedsinc.com 74 WELLINGTON COURT Checked By: M.R. & A.S 04/15/2024 RENDERING BUILDING EAST SIDE EAST FACADE DESIGNATION PHOTO NOTE: AE Design Solution Inc and its principal / employees were not retained for any supervision of the


As Noted

actual construction of this project.

#### EXISTING WEST ELEVATION (RIGHT SIDE) PROPOSED WEST ELEVATION (RIGHT SIDE) KEY PLAN: KEY PLAN: ENLARGEMENT **EXISTING EXISTING** 29'-8" 29'-8" T.O. ROOF EL: 74.13' T.O. ROOF EL: 74.13' REPAIR EXIST. ROOF REPAIR EXIST. ROOF STRUCTURE (IF NEED) STRUCTURE (IF NEED) REPAIR EXIST. (IF NEEDED) 10'-1" 10'-1" ATTIC FLOOR EL: 60.00' ATTIC FLOOR EL: 60.00' REPAIR EXIST. SIDING FINISH (IF NEEDED) SECOND FLOOR EL: 50.50' SECOND FLOOR EL: 50.50' NEW FACE BRICK TEXTURE AND COLOR TO MATCH EXIST. REPAIR EXIST. SIDING FINISH REPAIR EXIST. SIDING FINISH — EXTENSION - EXISTING EXIST. FACE BRICK EXIST. FACE BRICK WEST ELEVATION (SIDE) ELEVATION WEST ELEVATION (SIDE) ELEVATION Scale: Not To Scale Scale: Not To Scale 74 WELLINGTON COURT BROOKLYN, NY 11230 NOTE: AE Design Solution Inc and its principal / employees were not retained for any supervision of the RENDERING BUILDING WEST EXISTING BUILDING WEST SIDE PHOTO actual construction of this project.


#### PROPOSED PLOT PLAN HOUSE NO: 84 EXISTING 2-STORY & BASE. BRICK PRESIDENTIAL BUILDING ADJACENT REAR YARD FRAME GARAGE CONC. WALKWAY ISLAND EXISTING FRAME GARAGE ENLARGEMENT @1ST FLOOR $25'-1\frac{1}{8}$ " EXIST. SIDE YARD **EAST** HOUSE NO: 74 BLOCK:6691 EXIST. 1ST FLOOR ROOF PROPOSED HORIZ. ENLARGEMENT 1-FAMILY RES. BUILDING 2 STORIES W/ ATTIC. BUILDING HEIGHT: ± 36'-5" 17<sup>th</sup> 17<sup>th</sup> CONC. WALK EL: 37.75 CONC. WALK TRAIN RAIL ROAD STREET $15'-10^3/4$ " EXIST. FRONT YARD BRICK PLATF. 43'-11<sup>1</sup>/<sub>4</sub>" ISLAND ELEVATIONS SHOWN HERON REFER TO NAVD 1988 ADJUSTMENT EXISTING ROW OF EVERGREEN W EXISTING ROW OF EVERGREEN FENCE 35.0 ×35.4 CONCRETE SIDEWALK E 25 TC34.62 CURB BC34.42 117'-0" LOT TC34.34\* BC34.17 BLUESTONE 210'(±) GAS MAIN WELLINGTON COURT BLUESTONE CURB

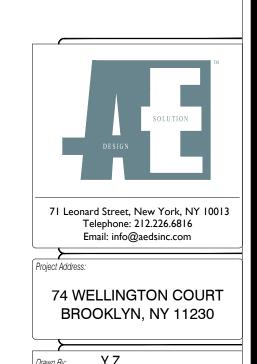


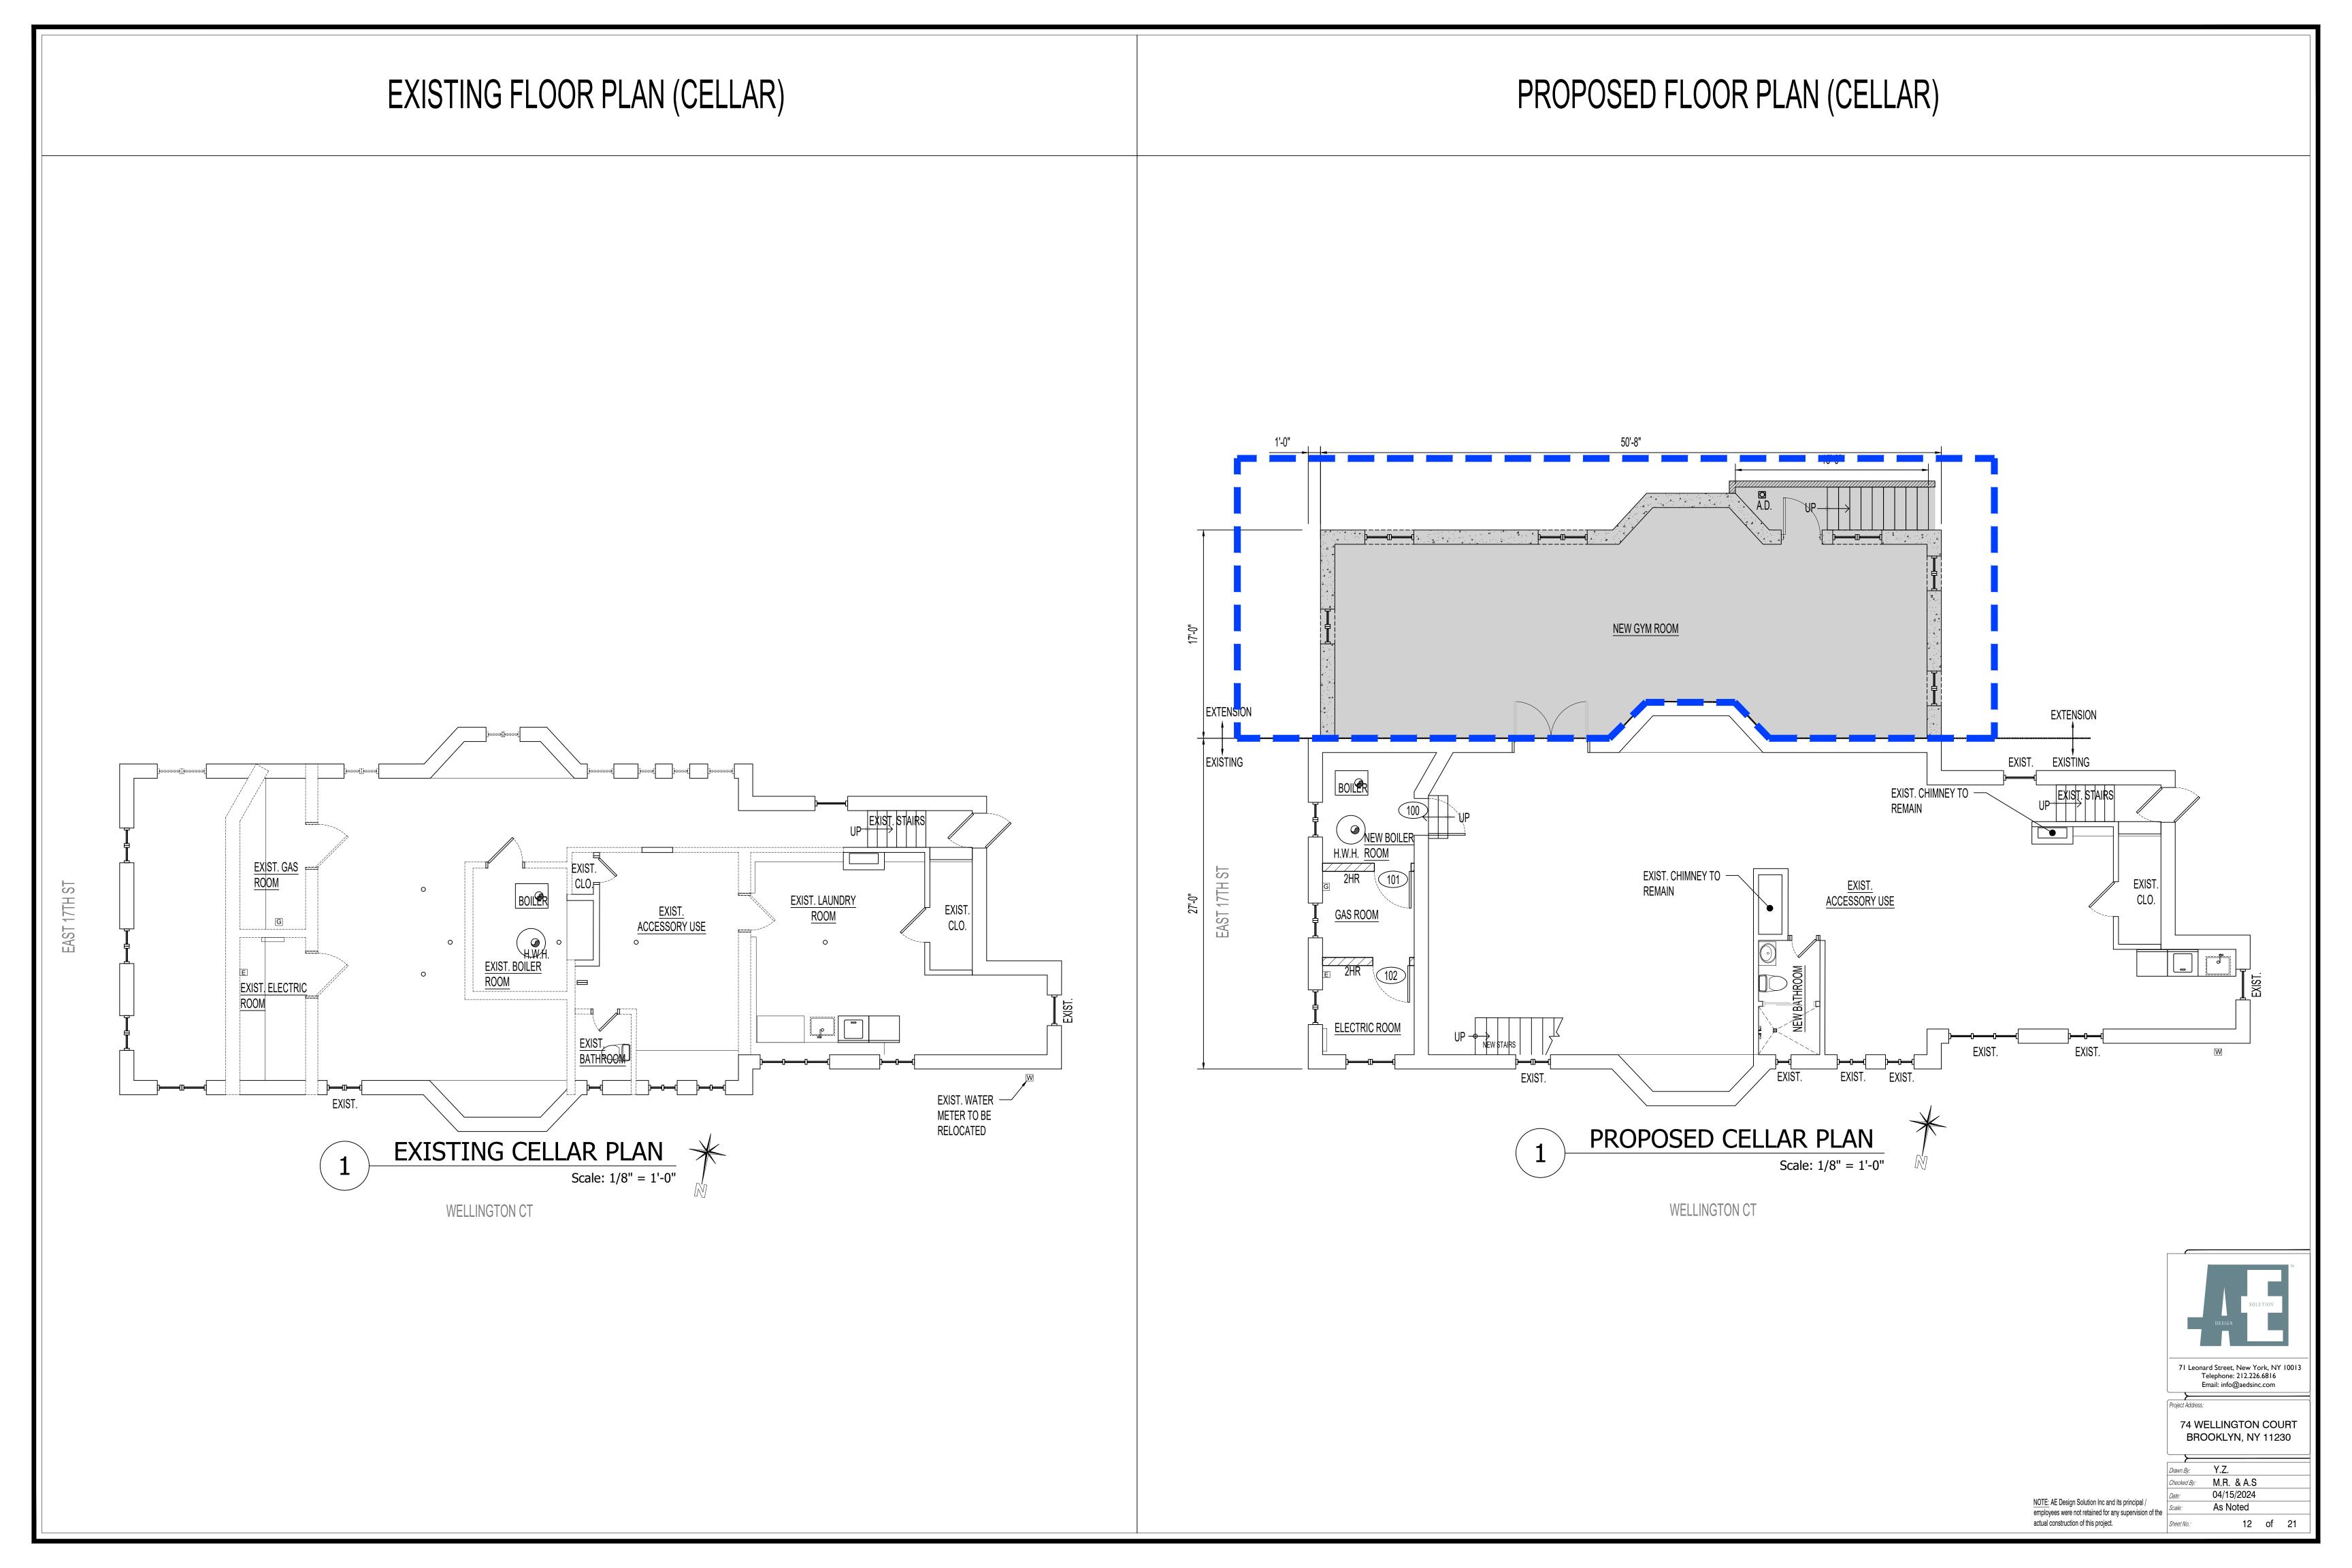


# EXISTING FLOOR PLAN (FIRST FLOOR) EXIST. LIVING ROOM EXIST. OFFICE EXIST. DINING AREA EXIST. STAIR TO BE REMOVED EXIST. FIRST FLOOR DEMOLITION PLAN WELLINGTON CT

## PROPOSED FLOOR PLAN (FIRST FLOOR)

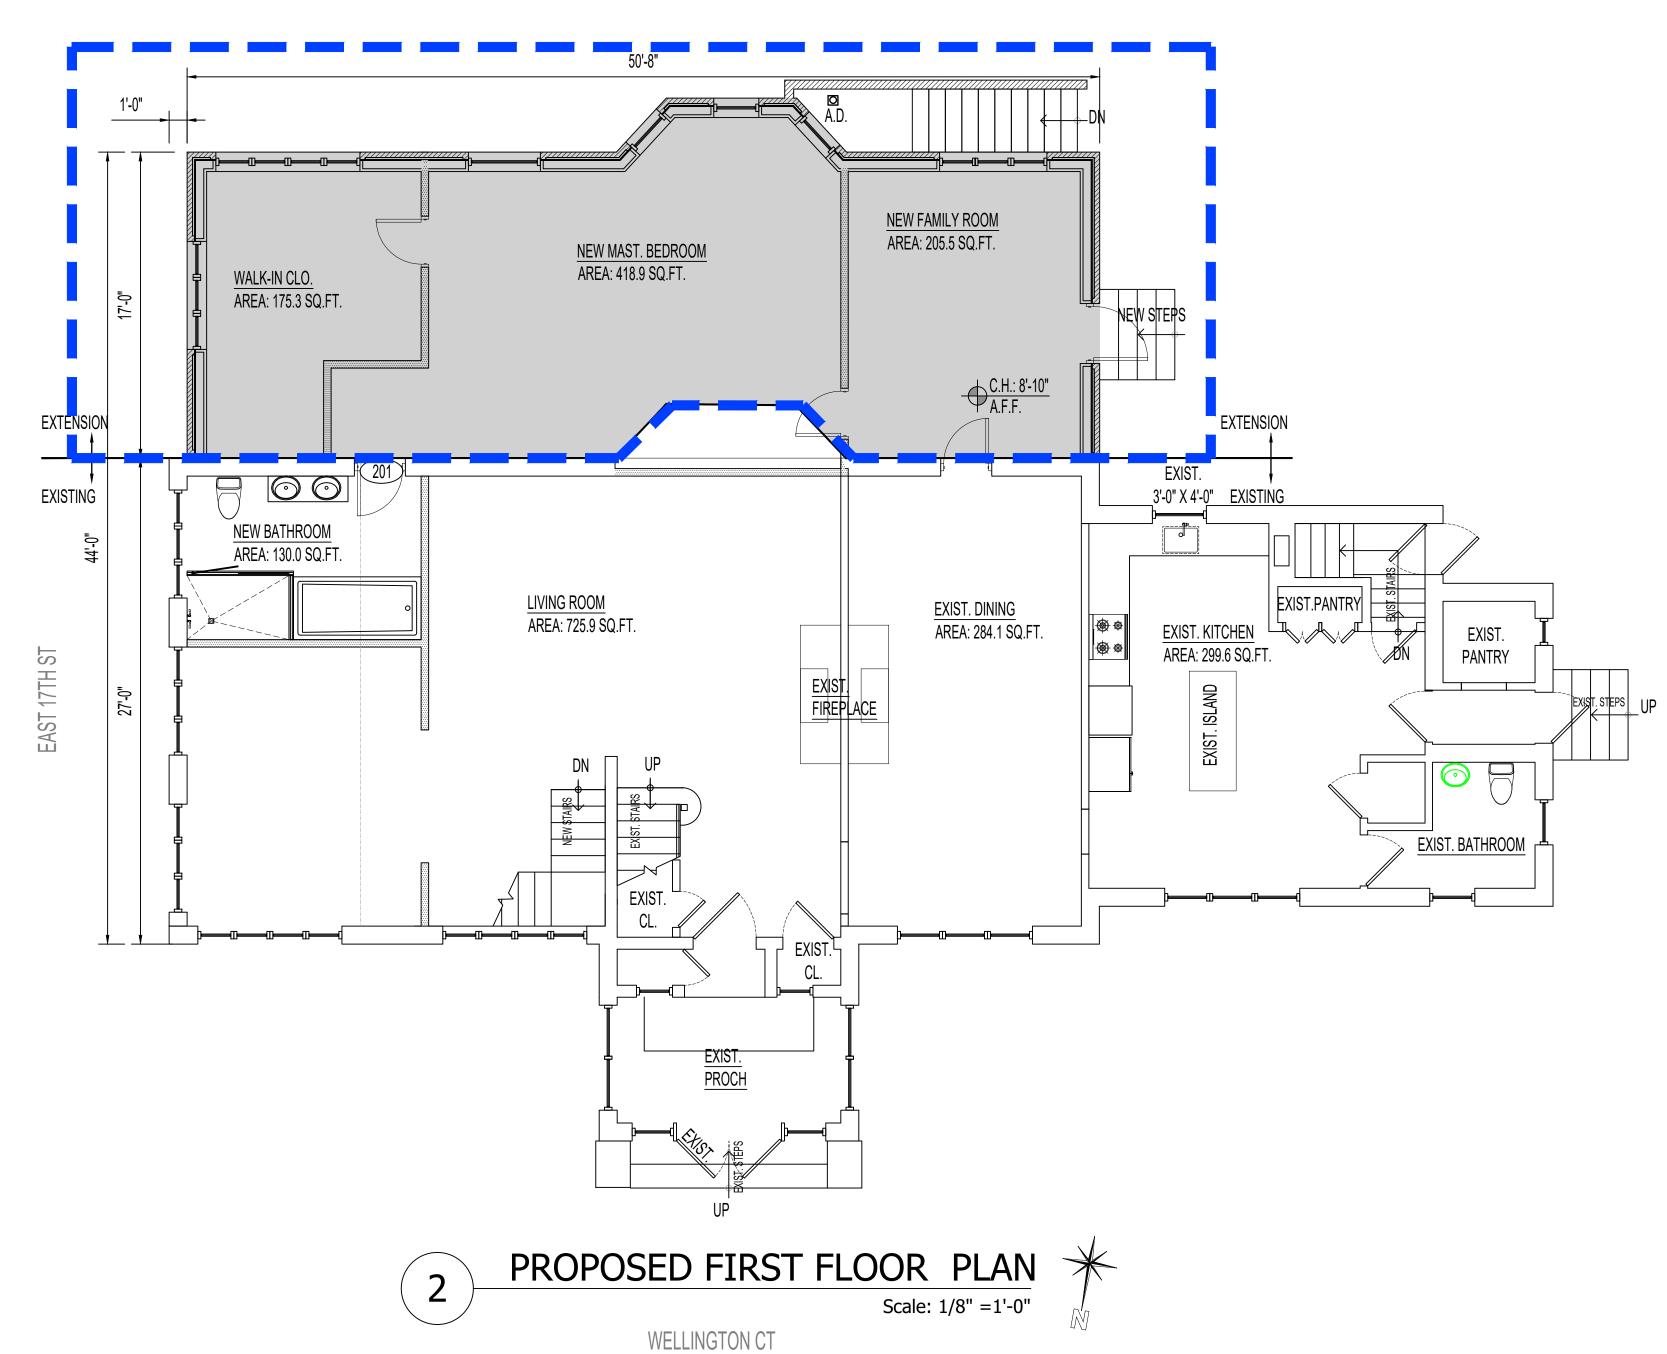


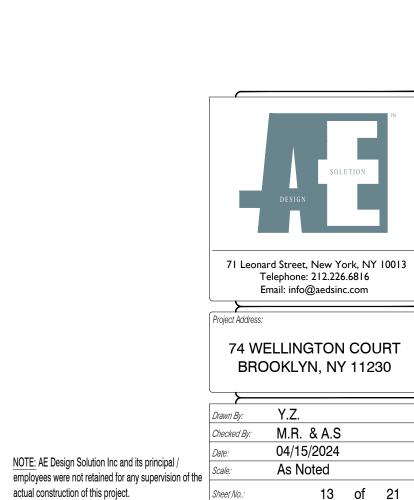

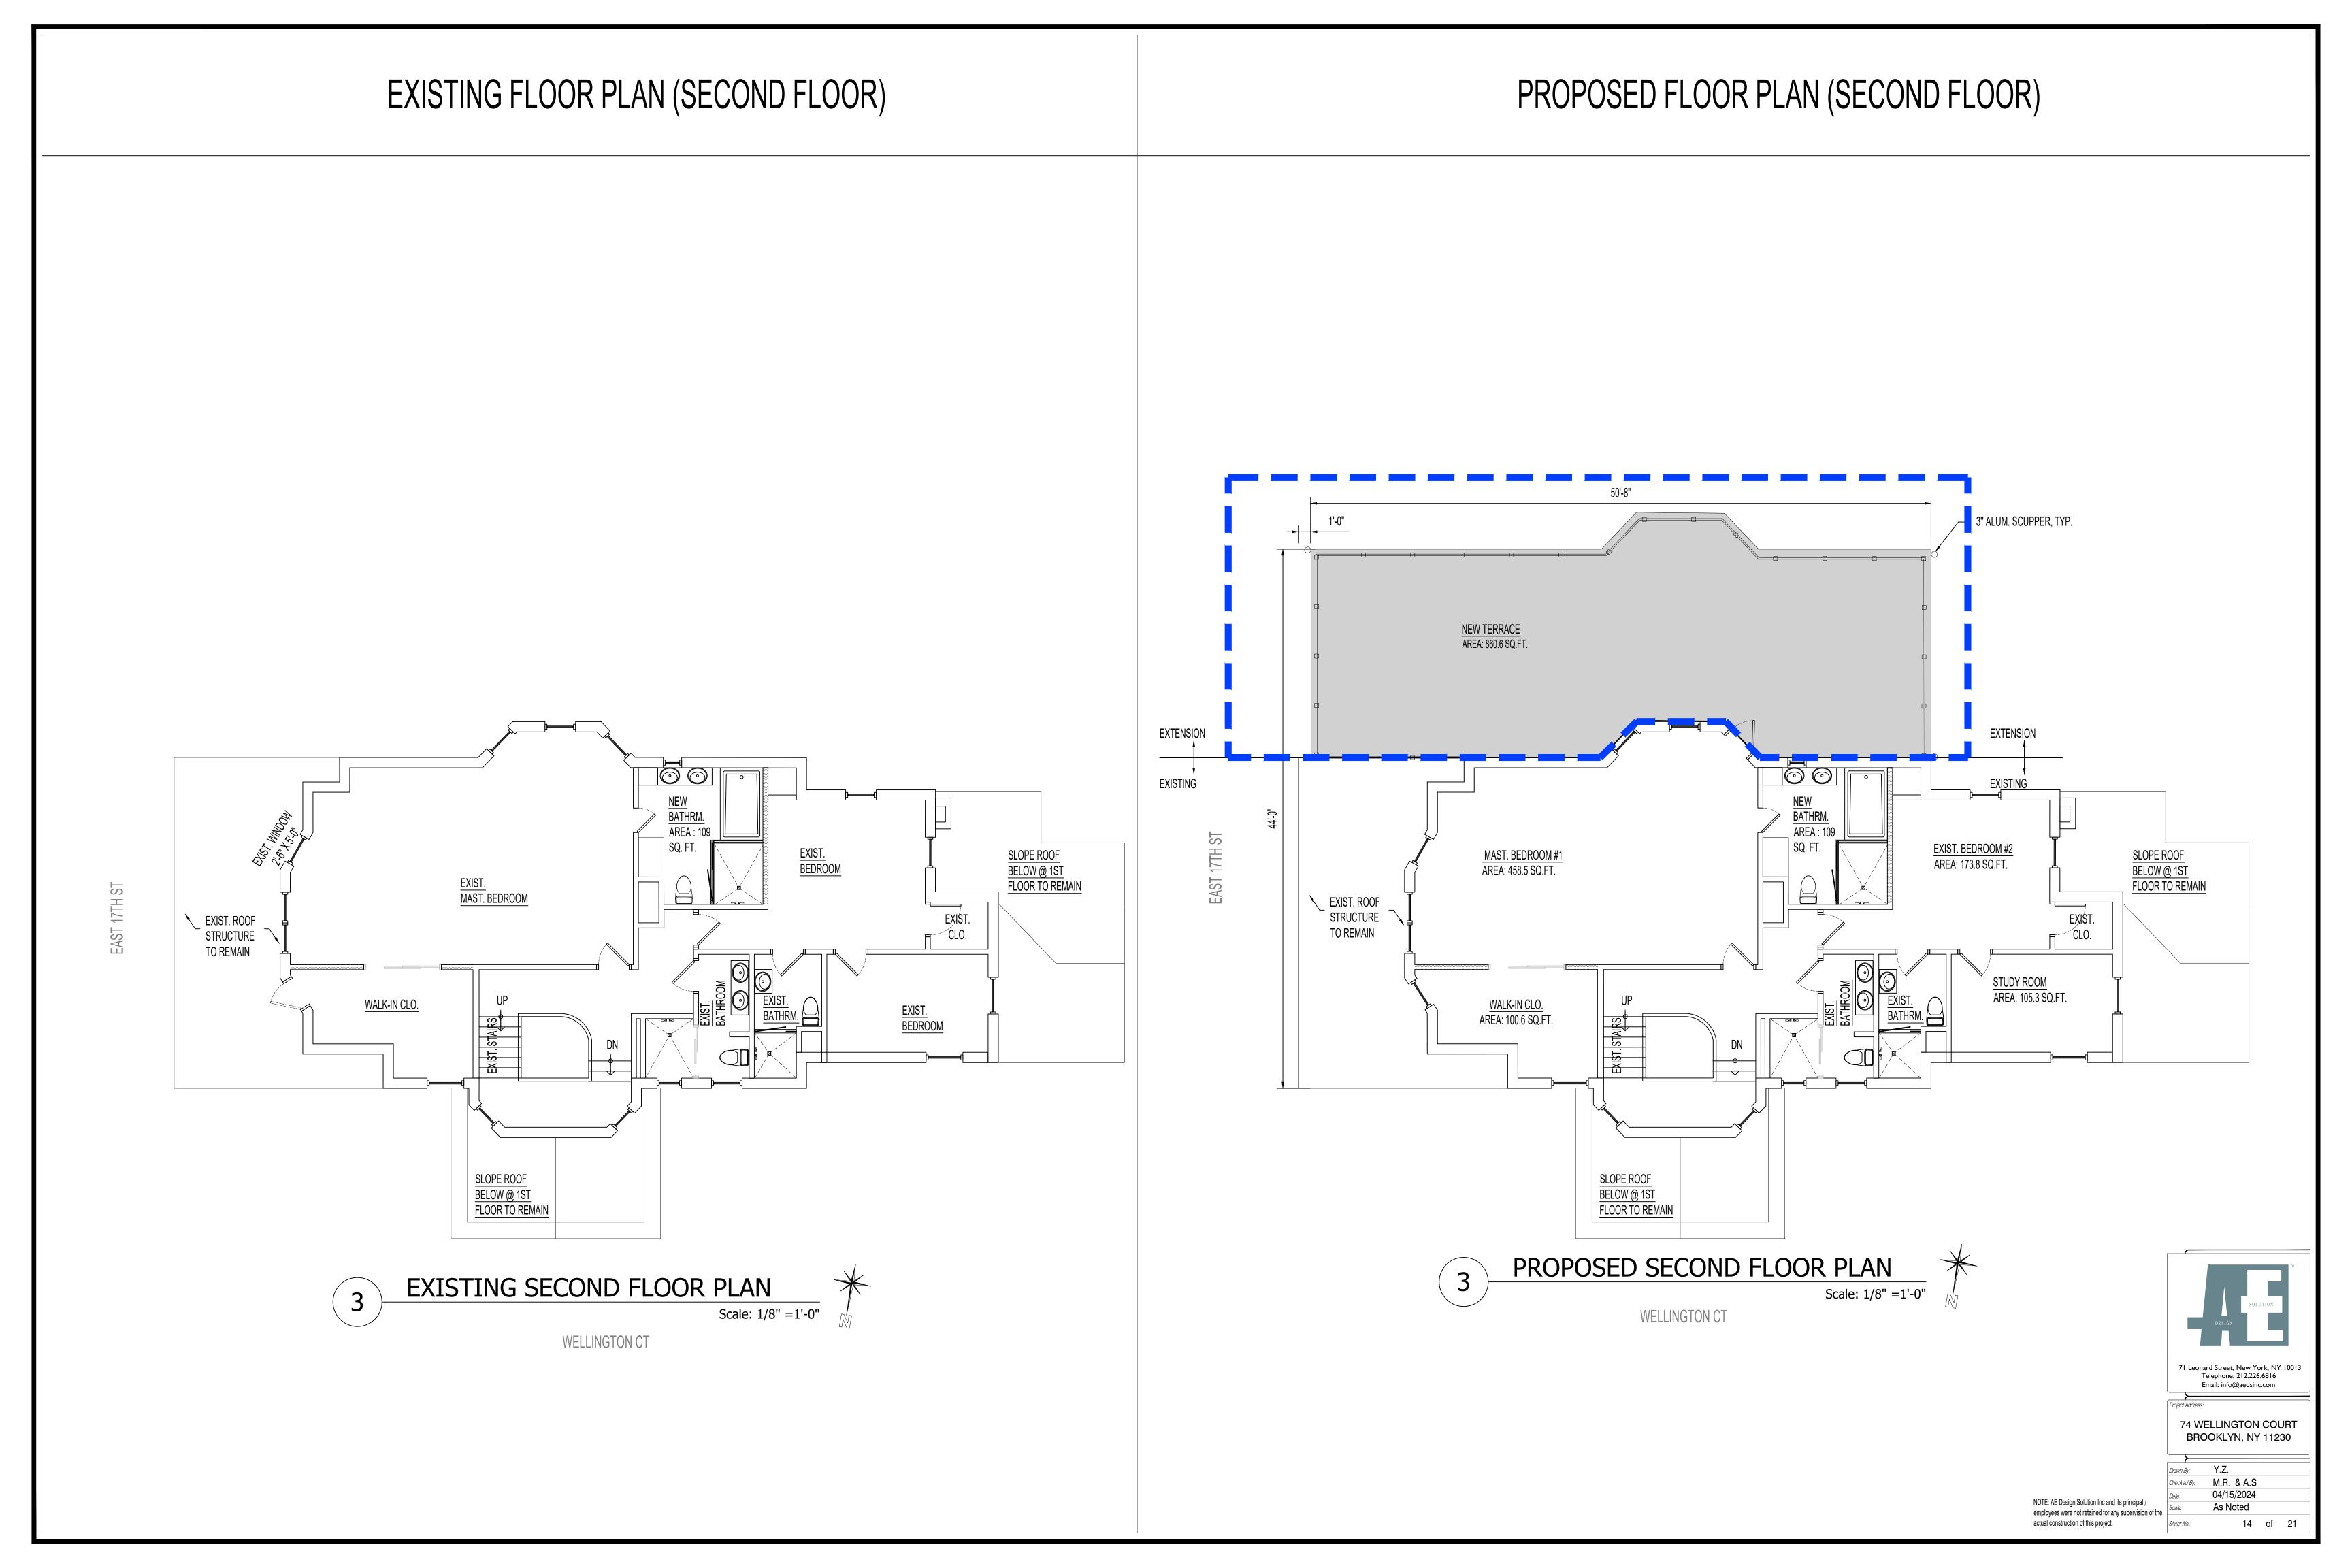

## FLOOR PLAN (ATTIC FLOOR)

## NO CHANGE

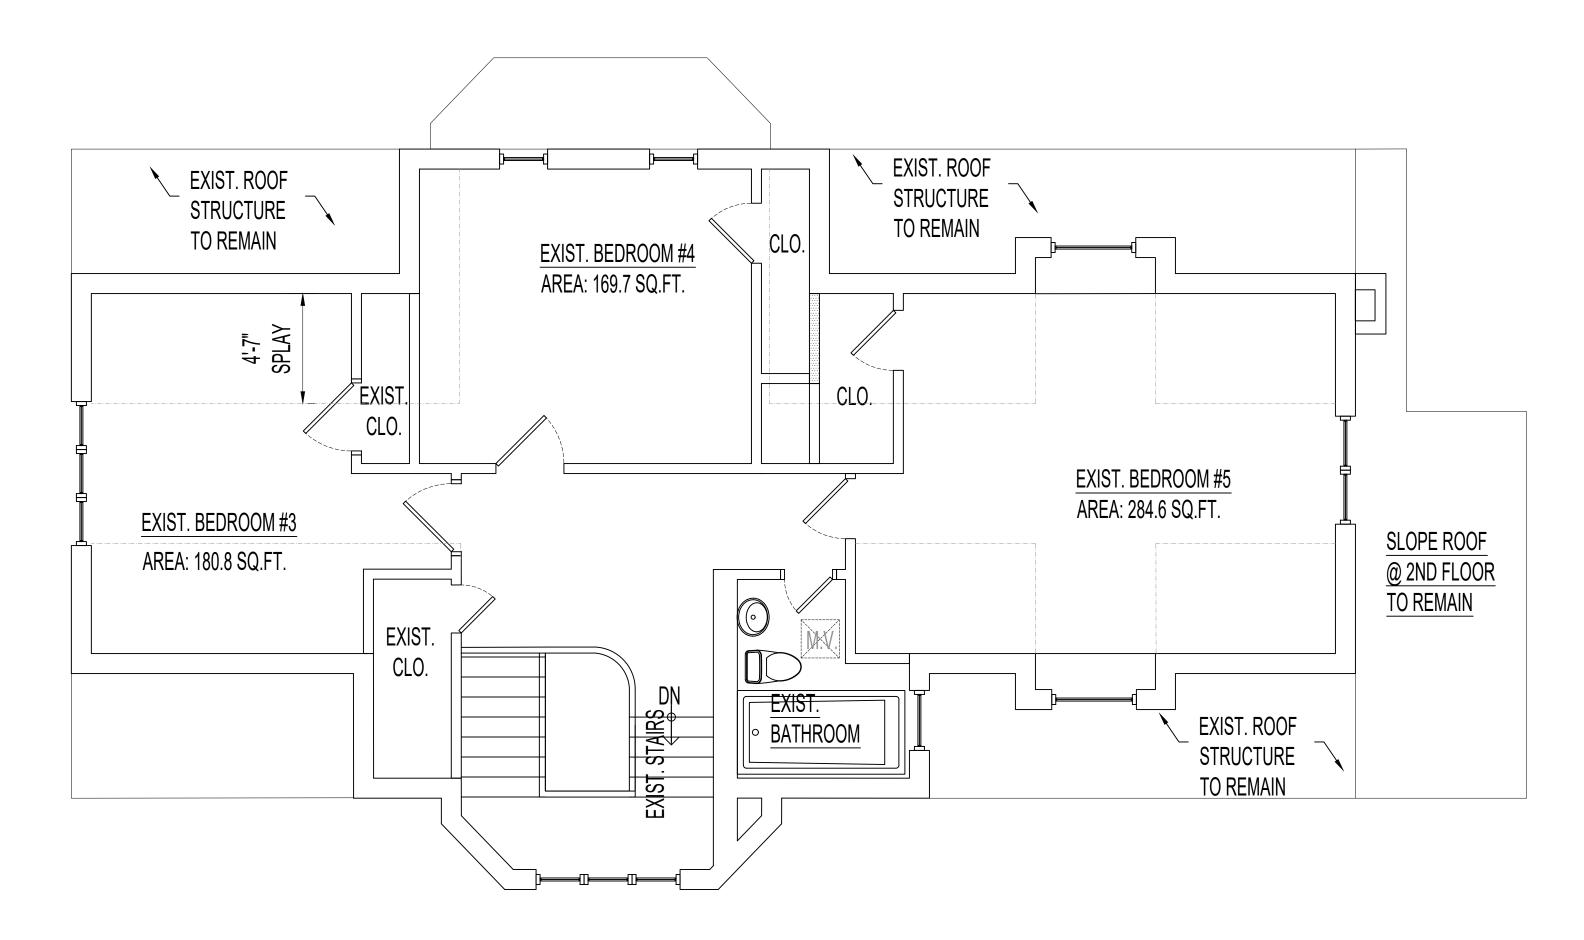





74 WELLINGTON COURT BROOKLYN, NY 11230

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Drawn By: Y.Z.

Checked By: M.R. & A.S


Date: 04/15/2024


Scale: As Noted

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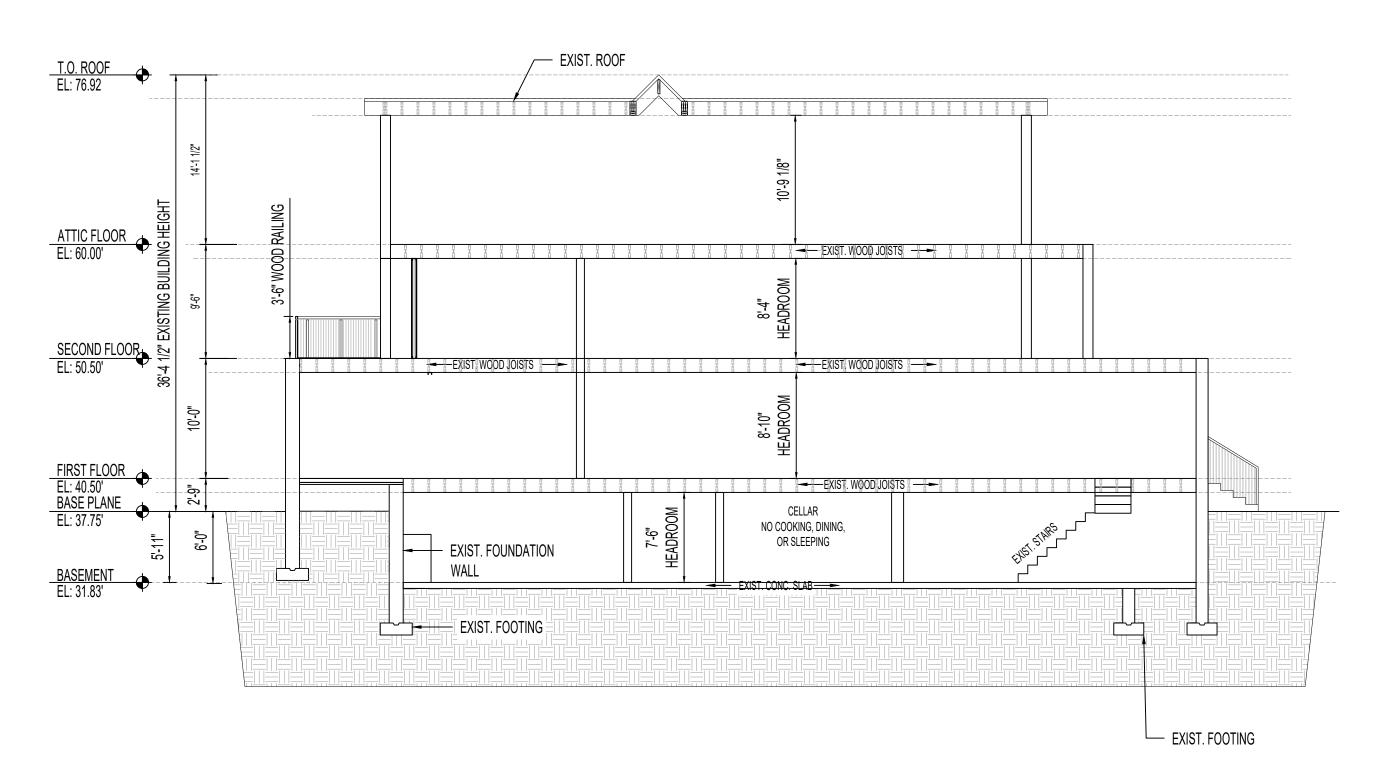
#### PROPOSED FLOOR PLAN (ROOF) EXISTING FLOOR PLAN (ROOF) 2ND FLOOR TERRACE 18'-10 7/8" 44'-6 7/8" ROOF AT 2ND FLOOR TO REMAIN EXTENSION \_\_\_ EXIST. CHIMNEY TO - EXIST. CHIMNEY TO BUILDING LINE BELOW BUILDING LINE BELOW BUILDING LINE BELOW BUILDING LINE BELOW SLOPE SLOPE SLOPE SLOPE EXIST. ROOF STRUCTURE EXIST. ROOF STRUCTURE RIDGE TO REMAIN RIDGE RIDGE RIDGE SLOPE ROOF SLOPE ROOF @ EXIST ROOF STRUCTURE TO REMAIN BELOW @ 1ST FLOOR TO REMAIN SLOPE STRUCTURE SLOPE BUILDING LINE BELOW BUILDING LINE BELOW EXIST. ROOF TO REMAIN TO REMAIN BUILDING LINE BELOW BUILDING LINE BELOW BUILDING LINE BELOW BUILDING LINE BELOW FLOOR TO REMAIN SLOPE ROOF @ 1ST SLOPE ROOF BELOW @ 1ST EXISTING ROOF PLAN Scale: Not To Scale PROPOSED ROOF PLAN WELLINGTON CT 71 Leonard Street, New York, NY 10013 Telephone: 212.226.6816 Email: info@aedsinc.com 74 WELLINGTON COURT BROOKLYN, NY 11230 Checked By: M.R. & A.S 04/15/2024 NOTE: AE Design Solution Inc and its principal / employees were not retained for any supervision of the As Noted actual construction of this project. 16 of 21

## **EXISTING BUILDING SECTIONS**




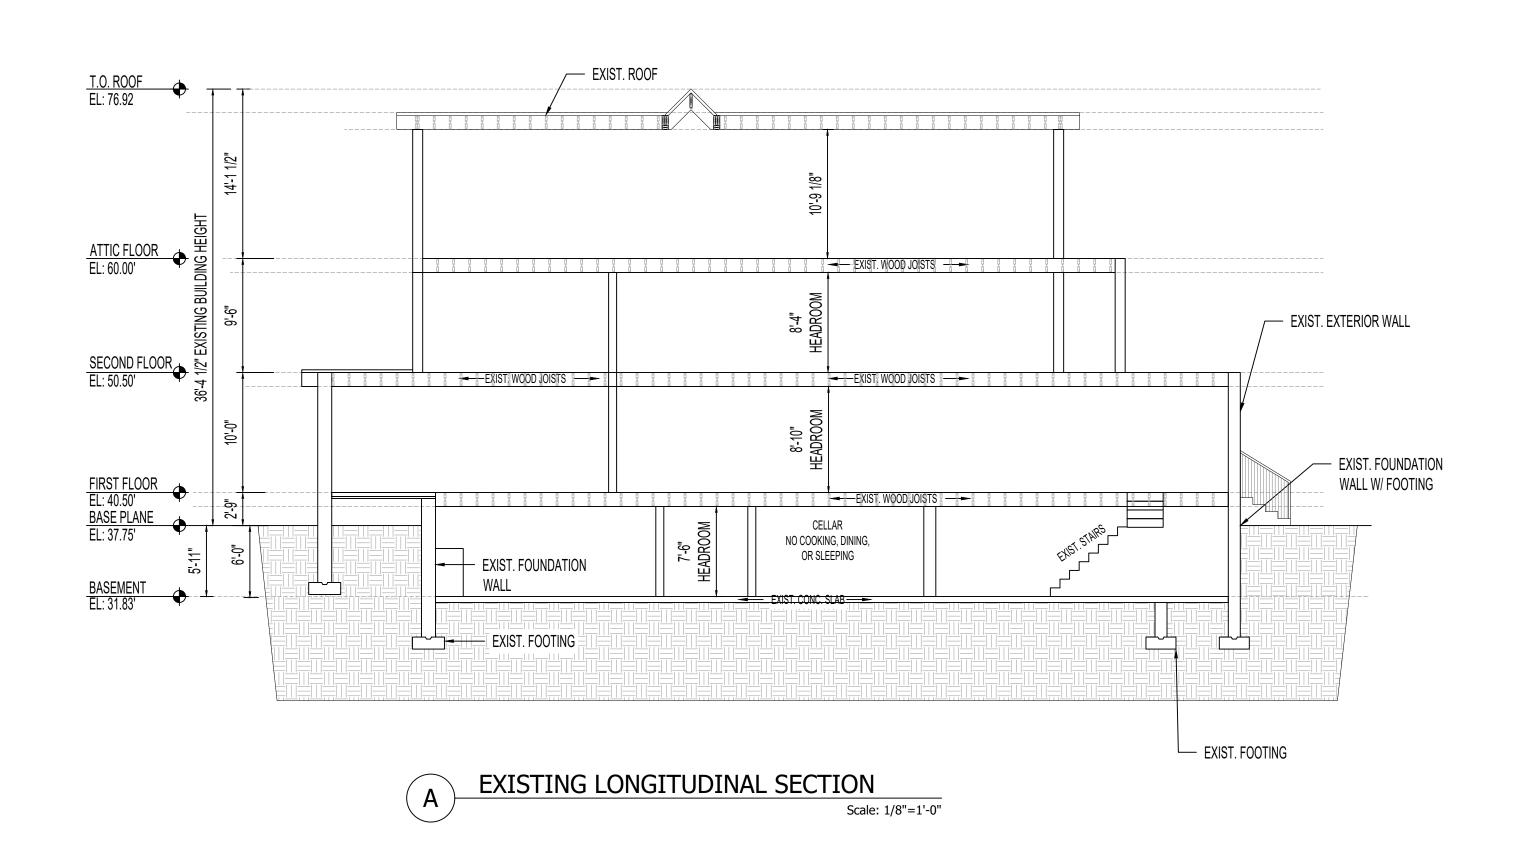

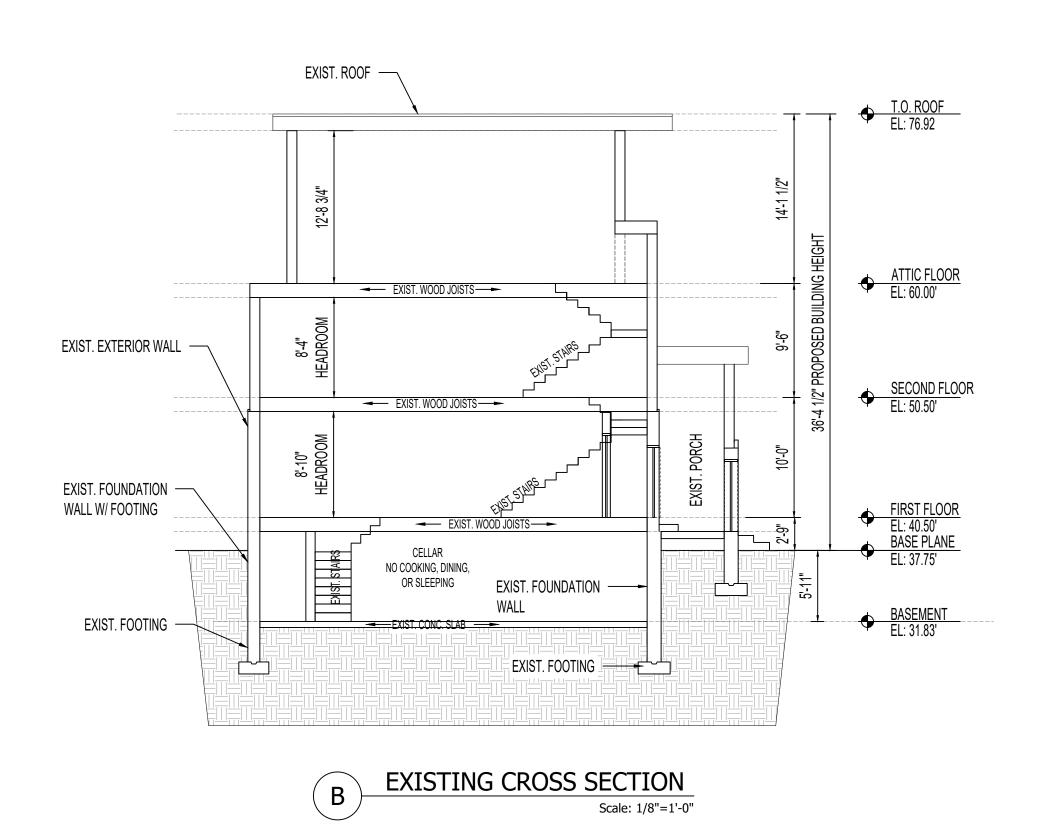
## PROPOSED BUILDING SECTIONS



PROPOSED LONGITUDINAL SECTION Scale: 1/8"=1'-0"

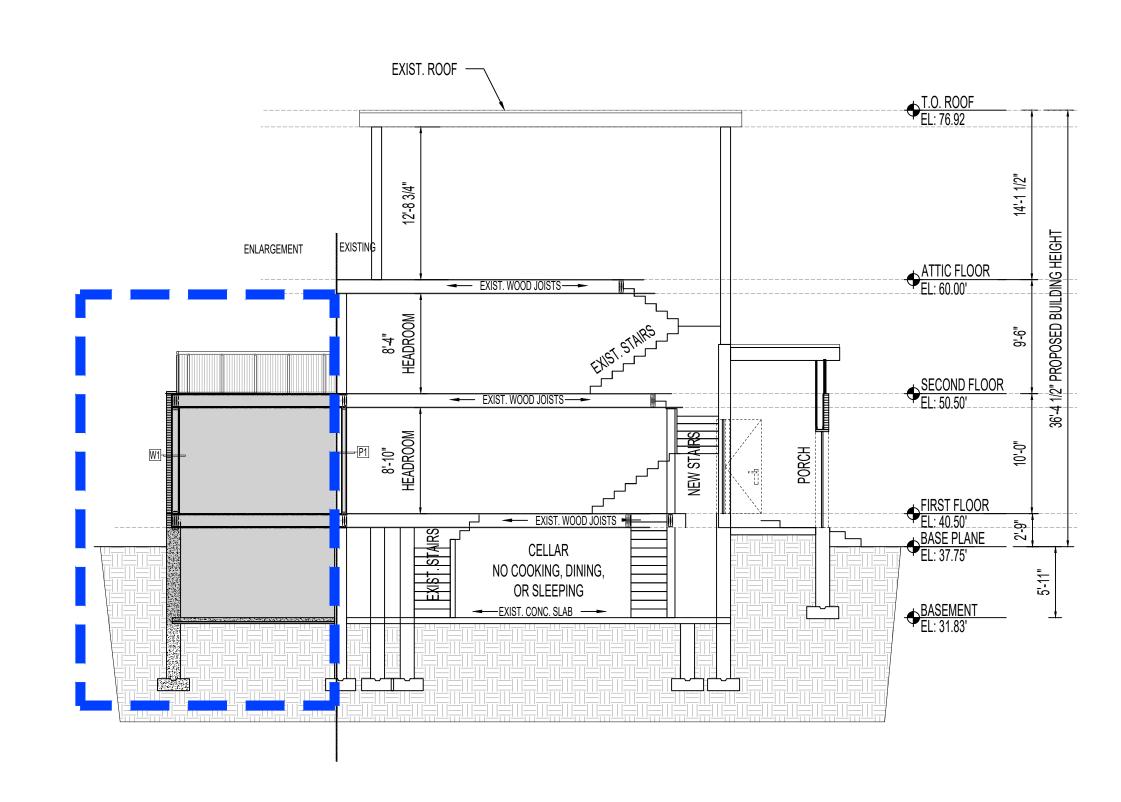

PROPOSED CROSS SECTION

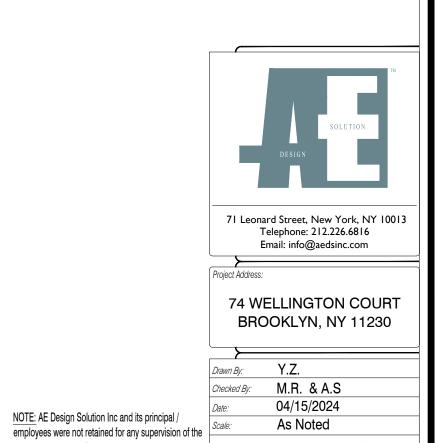

As Noted

17 of 21

actual construction of this project.

## PHOTOMONTAGES OF PROPOSED BUILDING



PROPOSED AXONOMETRIC EAST-NORTH (FRONT) VIEW




PROPOSED BUILDING ROOF VIEW




PROPOSED PERSPECTIVE SOUTH (REAR)-EAST VIEW



PROPOSED PERSPECTIVE WEST-SOUTH (REAR) VIEW

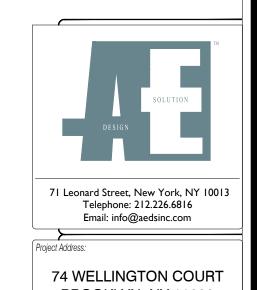

NOTE: AE Design Solution Inc and its principal / Employees were not retained for any supervision of the actual construction of this project.

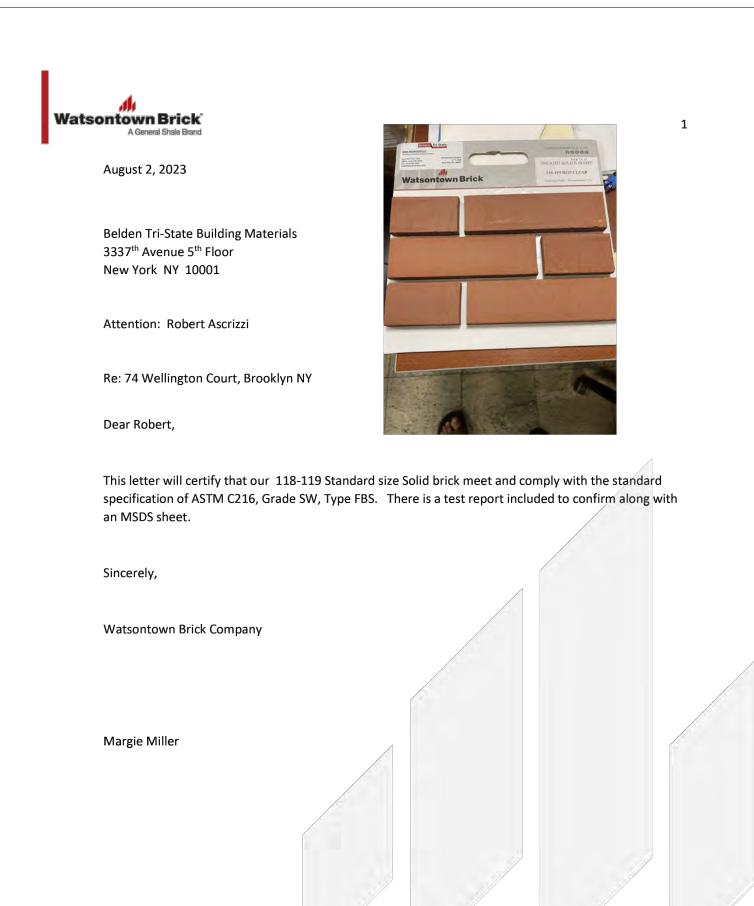

WATSONTOWN BRICK COMPANY: 86 Portmay Road, Watsontown, PA 17777 | (570) 538-2555

General Shale Brick Arriscraft Michigan Brick Red Red Brick JET STREAM Columbus Brick.

THE BISHOP MATERIALS LABORATORY

TEST REPORT THE BISHOP MATERIALS LABORATORY 100 Clamson Flacourch Elled. Anderson, SC 29625 (864) 656-1054

Fax: (864) 656-1095 www.bishopmats/fisislab.com Results of Tests on Brick conducted in accordance with ASTM C67-13 Standard Method for Sampling and

			Testing i	9/10/2014	Day Tile			
Name:	ck Company A 17777		Plant:		Watsontown Brick Company WBC-0070	*Temperature: 70 - 77F  *Humidity: 45% - 55%		
Phone:	570-538-2555			Received Date:		01/16/2014	4-19-20-4	
Fax:	570-539-5903			Sampled Date: Lot: Product Code:		01/16/2014		
Sample Description:	Smooth Solid							
								Test Date
Absorption		1	2	3	4	5	Average	
24 Hour Submersion in Cold Water (%)		8.26	8.37	5.66	5.76	5,83	6.78	01/27/201

Absorption		,	4	-		-	WASHORE				
24 Hour Submersion in Cold Water (%)		8.26	8.37	5.66	5.76	5.83	6.78	01/27/2014			
5 Hour Submersion in Bailing Water (%)		10.06	9.95	7.89	7.76	8.06	8.75				
Saturation Coefficient (Ratio of 24H to 5H)		0.82	0.84	0.72	0.74	0.72	0.77				
*Measurement Uncertainty ± 0.55 %			*The 1 and 2 hour boiled water absorption tests are not required by the customer								
Compressive Strength		1	2	3	4	5	Average				
	psi	9,488	11,038	15,263	16,090	12,482	12,872	01/27/2014			
	MPa	65.4	76,1	105.2	110.9	96.1	88.8				
*Measurement Uncertainty ± 23	1 psi										
Efflorescence		11	12	13	14	15					
		Not Effloresced	Not Effloresced	Nat Efforesced	Not Effloresced	Not Effloresced		01/31/2014			
IRA (Oven Dried Method) g/min/30 in.2		6	7	8	9	10	Average				
		17.7	23.9	17.1	16.7	18.2	18.7	01/27/2014			
*Measurement Uncertainty ± 1.	5 g/min/30	m. <sup>±</sup>									

The brick represented by the test results shown here comply with the physical property requirements of the standards listed below: ASTM C 32 - 13 Standard Specification for Sewer and Manhole Brick (Made From Clay or Shale)

ASTM C 62 - 13 Standard Specification for Building Brick (Solid Masonry Units Made From Clay or Shale) ASTM G 902 - 14 Standard Specification for Fedestrian and Light Traffic Paving Brick

0.09

Class: MX, NX

John Sanders, Ph.D., PE, Director

Gary W. Parker, Laboratory Supervisor

0.06

0.04

Lab Reference: 5488.9936

Abrasion Resistance

Page 1 of 2


01/27/2014



#### EXTERIOR WALL AND GUTTER MATERIAL

FIRST FLOOR EXTERIOR WALL BRICK BY WATSONTOWN BRICK ROOF ALUMINUM GUTTER BY AMERIMAX, FINISH COLOR TO MATCH **EXISTING GUTTER** 



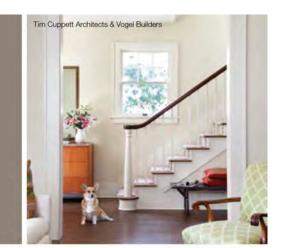


Sterling double hungs are made to blend seamlessly with the grandest décor. A patented interior wood cover conceals the jambliner, while giving the windows a rich, full-wood appearance. The lock system boosts performance to a level not often reached by double hung windows.

Sterling Double Hung Standard Features

- ▶ 1-3/4" thick sash
- Overall jamb width is 4-9/16" (basic box width is 4-9/16") Frame thickness is 3/4" at side jambs and head
- ▶ Sill thickness is 1-3/16", slope is 14° Constructed of pine, with pine interior stops and wood mull
- casings on mulled units ► Energy efficient, insulating LoE²-270 glass
- ▶ Glazed to the interior with beveled wood glazing beads ▶ 1-15/16" exterior brickmould applied
- All exterior wood parts are preservative-treated
- Exterior frame and sash are latex primed Wood interior head parting stop
- Fully weatherstripped for a tight seal Clay-colored heavy duty sash lock with a dual positioning
- lever allows sash to be unlocked, operated and tilted in
- from one location ▶ Spring-loaded block-and-tackle mechanical balances to
- carry the sash weight Concealed PVC jambliners Patented wood-wrapped jambliner closure on the interior
- (unless interior is prefinished white or primed, then jambliner will be white) and a primed, extruded aluminum jambliner closure on the exterior hides PVC jambliners Pine-veneered head and seat boards; unique narrow
- mullions on bay units

NOTE: All measurements are nominal.

Hardware

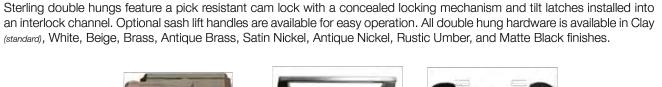







A wood wrapped jambliner closure on the interior (shown)

and a primed, extruded aluminum jambliner closure on the exterior hide the PVC jambliners.

Heavy duty sash lock with dual positioning lever allows sash to be unlocked, operated, and tilted in from one location.



Sterling Double Hung Optional Features

- Glass (pgs. 184-185): LoE-180
- ▶ LoE²-240
- ▶ LoE³-366 ▶ ThermaPlus™ LoE
- Patterned, bronze- or gray-lite Tempered or laminated
- Other options standard to the industry
- Divided Lites (pgs. 186-187):
- Performance divided lites with 5/8", 7/8" 1-1/8", 1-3/4", 2-1/4", or 4-1/2" bars
- ► True divided lites with 5/8" LoE² insulating glass and 1-1/8" bars Grilles-in-the-airspace
- ▶ Interior removable wood grilles with 7/8" or 1-1/8" bars and full surrounds


Exterior Finishes (pg. 189): K-Kron II exterior paint finish

- Other Options: (custom options are also available) Other wood species and FSC-certified wood (pg. 188)
- ▶ Interior prefinishing (pg. 188) Interior casing (pg. 190)
- Prep for stool 3-1/2" flat or profiled brickmould, backband on 3-1/2" brickmould and other custom millwork
- Projected sill nosing, extended sill horns or no nosing NOTE: All measurements are nominal.

- Ovolo and square profile glazing beads and interior divided lite bars (pg. 192) Class 5 balances available for larger units ▶ Sash locks in White, Beige, Brass, Antique Brass,
- Satin Nickel, Antique Nickel, Rustic Umber, and Matte Black finishes Sash lift handles in Clay, White, Beige, Brass, Antique Brass, Satin Nickel, Antique Nickel, Rustic
- Umber, and Matte Black finishes Custodial locks Universal design crank handle hardware kit in White Full or half screens with aluminum frames and options for BetterVue® or UltraVue® fiberglass screen
- mesh or aluminum screen mesh in either aluminum or charcoal colors; frames will match the exterior color of the unit Retractable screen kit (pg. 191)
- Retractable screen covers available as beveled (standard) Or Square
- StormGuard combination storm/screen units Extension jambs (up to 12" applied; over 12" shipped loose for field
- Sash limiters for safety
- Galvanized steel installation clips Insulated platforms, support brackets and oak-
- veneered head and seat boards for bay units ► High performance and K-Force® impact performance

#### WINDOW FRAME MATERIAL

WINDOW WOOD FRAME & CLEAR GLASSES BY STERLING FINISH COLOR MATCH EXISTING WINDOW

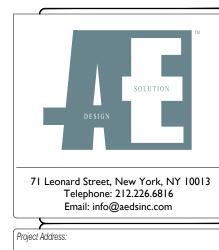


74 WELLINGTON COURT BROOKLYN, NY 11230

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Y.Z. Checked By: M.R. & A.S 04/15/2024 As Noted

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#### NEW EXTERIOR CELLAR DOOR MATERIAL



**ASSA ABLOY Panic Exit Device** 

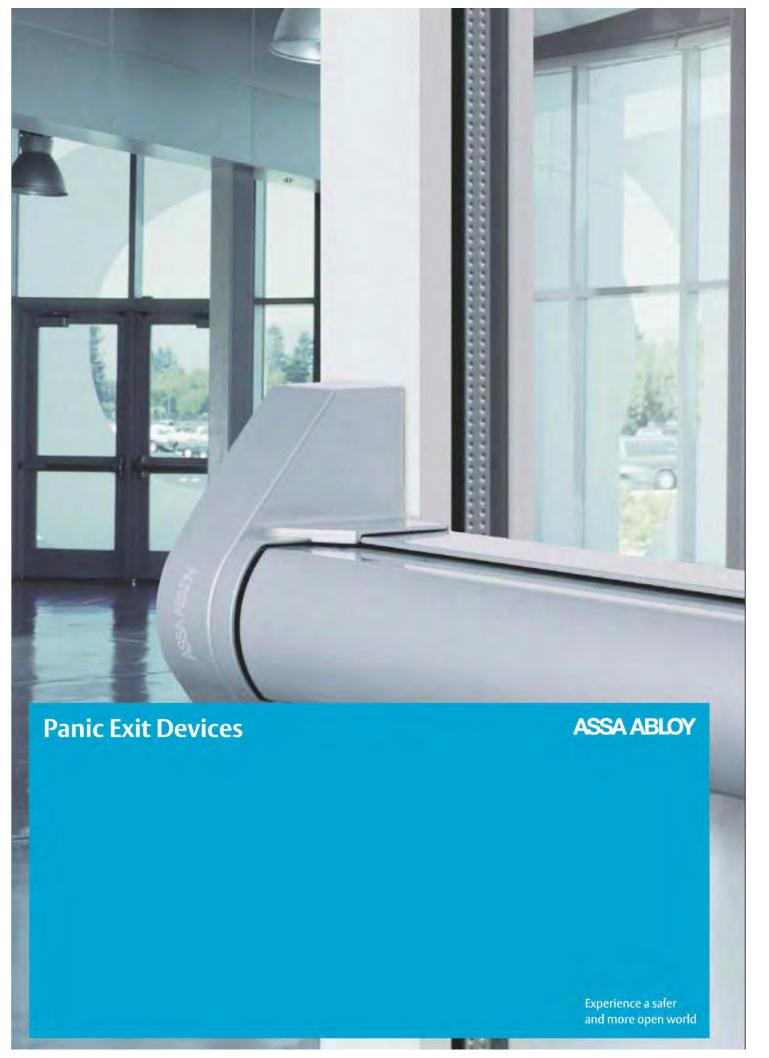Panic Exit Device

over & Fix bar

S/Steel effect

Cover & Fix bar

Push bar:

Black (RAL 9000) N NR Silver (RAL 9006) G

Black (RAL 9000) N NR

Silver (RAL 9006) G

S/Steel effect

Panic Exit Devices standard finishes

ASSA ABLOY


Panic Exit Device - Touch Bar

ASSA ABLOY

PED 300 Touch Bar - Rim Device

• Panic exit device with central locking point - RIM



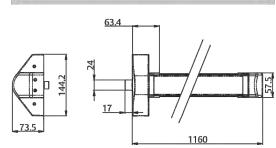

Characteristics of PED 300: Modular push bar type

• For fire and smoke applications • High durability 2,00,000 cycles

 One central locking point • For one or double leaf door up to 200 kg

 For all types of door • For doors up to 1200 mm width in standard

• For doors up to 1400 mm width in option Steel pulman latch in standard

 Dead latch in standard • Steel or zinc alloy swing latch

• Zinc alloy cover 38 mm width

• Aluminium touch bar 1046 mm long Bar to be cut

 73 mm projection HO function in option

Micro switch version in option









• Surface mounted • Ease of installation Slim, neat design, surface mounted Superior aesthetics 200,000 cycles tested High durability Fire rated Suitable for fire rated doors Wide range of option • External cylinder and lever option available • Cross and Push bar • Modular type – stock reduction • 1, 2, 3 locking point versions (vertical and lateral) – RIM • For doors up to 1200 x 2400mm in standard Easy installation and adjustment Wide range of finishes Compatible accessories Wide range of outside trims Hold Open and Micro switch versions Glass door kit • Certified according to EN 1125:2008

Durability of 2,00,000 cycles

• For Fire Rated applications (not HO version)


This new range of product is based on a new

modular concept and a common design, under a

unique platform for both push and cross bar panic


Suitable for single and double doors

**BEXIT** 

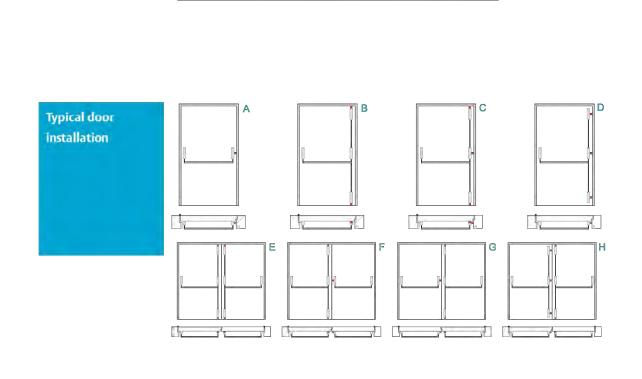


(RAL 3000) (RAL 9006)

(RAL3000) (RAL 9006)

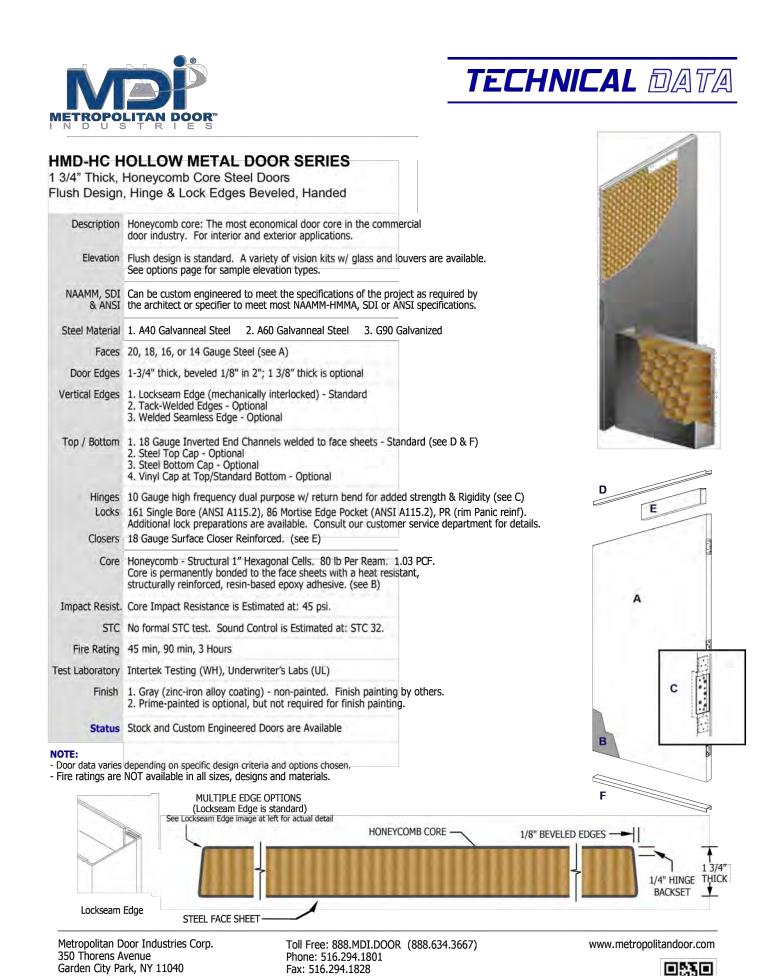

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NOTE: AE Design Solution Inc and its principal / employees were not retained for any supervision of the actual construction of this project.

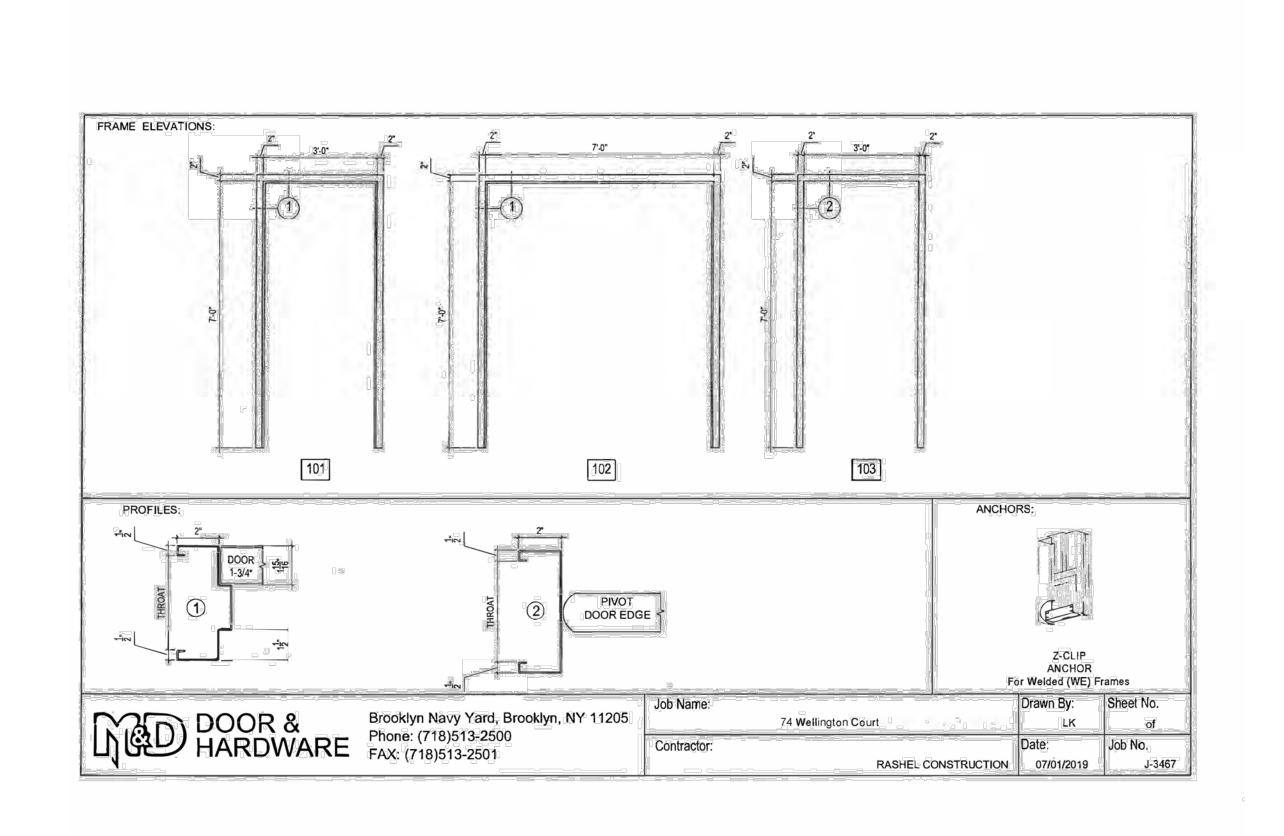
Checked By: M.R. & A.S 04/15/2024 As Noted 20 of 21 Sheet No.:



Millions of families have found shelter and peace of mind under a Timberline® roof.

And now, a good thing just got even better again.

We protect what matters most™

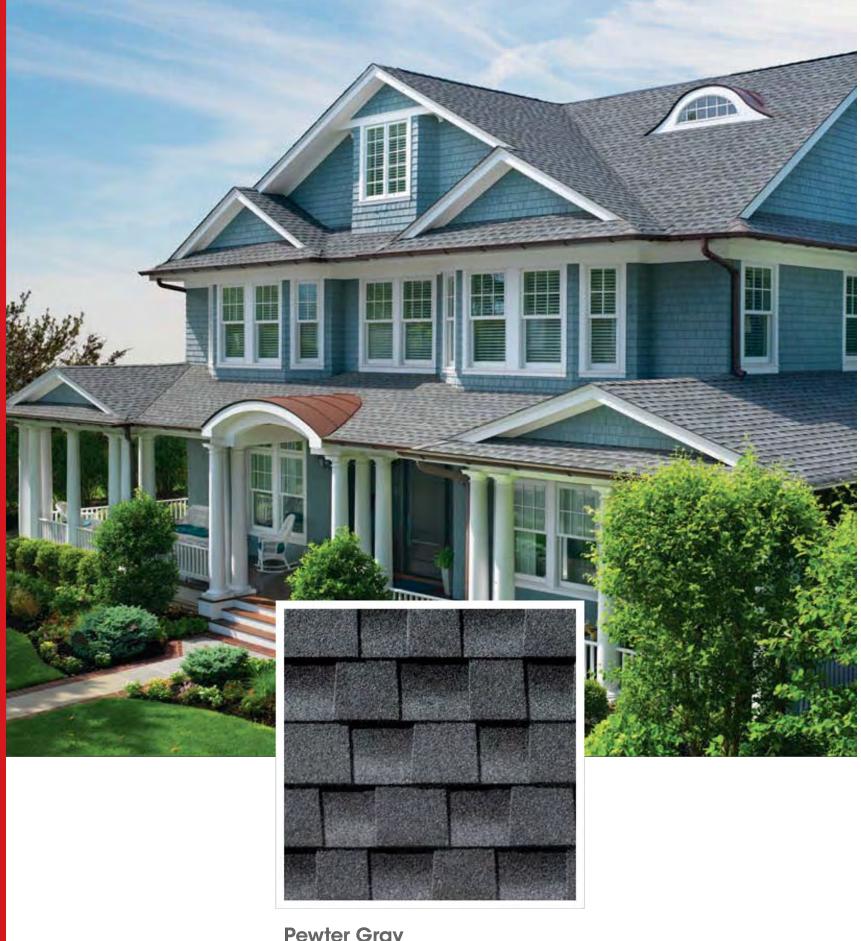


#### **Pewter Gray**

Pewter Gray can add dramatic counterpoint to contemporary exterior color palettes, as well as to stucco or brick facades.

Note: It is difficult to reproduce the color clarity and actual color blends of these products. Before selecting your color, please ask to see several full-size shingles.

NEW ROOFING MATERIAL

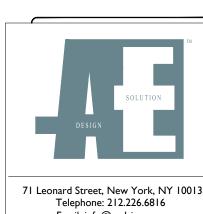

71 Leonard Street, New York, NY 10013 Telephone: 212.226.6816 Email: info@aedsinc.com

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Drawn By: Y.Z. Checked By: M.R. & A.S 04/15/2024 As Noted 21 of 21

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#### The current proposal is:

Preservation Department – Item 3, LPC-23-08409

## 74 Wellington Court – Fiske Terrace-Midwood Park

**Historic District** 

**Borough of Brooklyn** 

To testify virtually, please join Zoom

Webinar ID: 870 9410 2125

Passcode: 613401

By Phone: 1 646-558-8656 US (New

York) 877-853-5257 (Toll free) US

888 475 4499 (Toll free)

**Note**: If you want to testify virtually on an item, join the Zoom webinar at the agenda's "Be Here by" time (about an hour in advance). When the Chair indicates it's time to testify, "raise your hand" via the Zoom app if you want to speak (\*9 on the phone). Those who signed up in advance will be called first.