

Appendix C1g Preferred Alternative - Closure Structures


Appendix C1g Flood Protection Cross Sctions


TABLE OF CONTENTS


SHEET NO.	DRAWING NO.	SHEET TITLE
FG100	SANDRESM1-FG100-00.DWG	CLOSURE FOUNDATION MONTGOMERY ST ROLLER GATE GENERAL PLAN
FG101	SANDRESM1-FG101-00.DWG	CLOSURE STRUCTURES MONTGOMERY ST ROLLER GATE MONOLITH LAYOUT PLAN
FG102	SANDRESM1-FG102-00.DWG	CLOSURE STRUCTURES MONTGOMERY ST ROLLER GATE ELEVATION
FG103	SANDRESM1-FG103-00.DWG	CLOSURE STRUCTURES MONTGOMERY ST ROLLER GATE SECTIONS AND DETAILS
FG150	SANDRESM1-FG150-00.DWG	CLOSURE STRUCTURES PIER 42 SWING GATE GENERAL PLAN
FG155	SANDRESM1-FG155-00.DWG	CLOSURE STRUCTURES PIER 42 SWING GATE SECTIONS
FG201	SANDRESM1-FG201-00.DWG	CLOSURE STRUCTURES FDR DRIVE SWING GATES PLAN SHEET 1 OF 2
FG202	SANDRESM1-FG202-00.DWG	CLOSURE STRUCTURES FDR DRIVE SWING GATES PLAN SHEET 2 OF 2
FG206	SANDRESM1-FG206-00.DWG	CLOSURE FOUNDATION FDR DRIVE SWING GATES SECTIONS AND DETAILS
FG270	SANDRESM1-FG270-00.DWG	CLOSURE FOUNDATION FDR DRIVE SWING GATES OVERALL REGRADING PLAN
FG274	SANDRESM1-FG274-00.DWG	CLOSURE FOUNDATION FDR DRIVE SWING GATES REGRADING PROFILES SHEET 1 OF 2
FG275	SANDRESM1-FG275-00.DWG	CLOSURE FOUNDATION FDR DRIVE SWING GATES REGRADING PROFILES SHEET 2 OF 2
FG300	SANDRESM1-FG300-00.DWG	CLOSURE STRUCTURES 14TH STREET CROSSING GENERAL PLAN
FG301	SANDRESM1-FG301-00.DWG	CLOSURE STRUCTURES 14TH STREET CROSSING ELEVATION AND SECTIONS
FG400	SANDRESM1-FG400-00.DWG	CLOSURE STRUCTURES 15TH STREET PEDESTRIAN SWING GATE PLANS
FG401	SANDRESM1-FG401-00.DWG	CLOSURE STRUCTURES 15TH STREET PEDESTRIAN SWING GATE SECTIONS
FG420	SANDRESM1-FG420-00.DWG	CLOSURE STRUCTURES 15TH STREET VEHICULAR SWING GATE GENERAL PLAN
FG421	SANDRESM1-FG421-00.DWG	CLOSURE STRUCTURES 15TH STREET VEHICULAR SWING GATE PARTIAL PLAN
FG425	SANDRESM1-FG421-00.DWG	CLOSURE STRUCTURES 15TH STREET VEHICULAR SWING GATE SECTIONS
FG440	SANDRESM1-FG440-00.DWG	CLOSURE STRUCTURES 15TH STREET GATES REGARDING OVERALL PLAN
FG442	SANDRESM1-FG442-00.DWG	CLOSURE STRUCTURES 15TH STREET GATES REGARDING OVERALE FLAN CLOSURE STRUCTURES 15TH STREET GATES REGARDING PROFILES SHEET 1 OF 2
FG500	SANDRESM1-FG500-00.DWG	CLOSURE STRUCTURES EAST 18TH STREET FDR ON RAMP & OCME GATE PLAN
FG501	SANDRESM1-FG501-00.DWG	CLOSURE STRUCTURES MURPHY BROTHERS & OCME SWING GATE ELEVATION
FG502	SANDRESM1-FG502-00.DWG	CLOSURE STRUCTURES EAST 18TH STREET FDR ON RAMP & OCME GATE SECTIONS
FG550	SANDRESM1-FG550-00.DWG	CLOSURE STRUCTURES EAST 18TH STREET FDR EXIT GATE PLAN
FG551	SANDRESM1-FG551-00.DWG	CLOSURE STRUCTURES FDR EXIT GATE SECTION
FG552	SANDRESM1-FG552-00.DWG	CLOSURE STRUCTURES EAST 18TH STREET FDR EXIT GATE REGRADING OVERALL PLAN
FG600	SANDRESM1-FG600-00.DWG	CLOSURE STRUCTURES STUYVESANT COVE SOUTH GATE PLAN
FG601	SANDRESM1-FG601-00.DWG	CLOSURE STRUCTURES FDR EXIT & STUY COVE SOUTH ROLLER GATE ELEVATION
FG609	SANDRESM1-FG609-00.DWG	CLOSURE STRUCTURES EAST 18TH STREET FDR EXIT GATE PLAN & ELEVATION SHEET 1 OF 2
FG610	SANDRESM1-FG610-00.DWG	CLOSURE STRUCTURES EAST 18TH STREET FDR EXIT GATE PLAN & ELEVATION SHEET 2 OF 2
FG611	SANDRESM1-FG611-00.DWG	CLOSURE STRUCTURES STUYVESANT COVE SOUTH GATE PLAN & ELEVATION SHEET 1 OF 2
FG650	SANDRESM1-FG650-00.DWG	CLOSURE STRUCTURES EAST 20TH STREET GATE PLAN
FG651	SANDRESM1-FG651-00.DWG	CLOSURE STRUCTURES EAST 20TH STREET GATE ELEVATION
FG652	SANDRESM1-FG652-00.DWG	CLOSURE STRUCTURES EAST 20TH STREET GATE REGRADING OVERALL PLAN
FG654	SANDRESM1-FG654-00.DWG	CLOSURE STRUCTURES EAST 20TH STREET GATE CONCRETE MONOLITH SHEET 1 OF 2
FG655	SANDRESM1-FG655-00.DWG	CLOSURE STRUCTURES EAST 20TH STREET GATE CONCRETE MONOLITH SHEET 2 OF 2
FG656	SANDRESM1-FG656-00.DWG	CLOSURE STRUCTURES EAST 20TH STREET GATE PLAN & ELEVATION SHEET 1 OF 2
FG657	SANDRESM1-FG657-00.DWG	CLOSURE STRUCTURES EAST 20TH STREET GATE PLAN & ELEVATION SHEET 2 OF 2
FG700	SANDRESM1-FG700-00.DWG	CLOSURE STRUCTURES EAST STUYVESANT COVE NORTH GATE PLAN
FG701	SANDRESM1-FG701-00.DWG	CLOSURE STRUCTURES EAST STUYVESANT COVE NORTH GATE SECTION
FG702	SANDRESM1-FG702-00.DWG	CLOSURE STRUCTURES EAST STUYVESANT COVE NORTH GATE REGRADING OVERALL PLAN
FG750	SANDRESM1-FG750-00.DWG	CLOSURE STRUCTURES EAST 23RD STREET SOUTH & NORTH GATE PLAN
FG751	SANDRESM1-FG751-00.DWG	CLOSURE STRUCTURES 23RD STREET CROSSING ELEVATION
FG752	SANDRESM1-FG752-00.DWG	CLOSURE STRUCTURES EAST 23RD STREET CROSSING SECTIONS
FG755	SANDRESM1-FG755-00.DWG	CLOSURE STRUCTURES EAST 23RD STREET SOUTH & NORTH GATE CONCRETE MONOLITH SHEET 1 OF 2
FG757	SANDRESM1-FG757-00.DWG	CLOSURE STRUCTURES EAST 23RD STREET SOUTH GATE PLAN & ELEVATION SHEET 1 OF 2
FG800	SANDRESM1-FG800-00.DWG	CLOSURE STRUCTURES WEST SERVICE ROAD CROSSING PLAN
FG801	SANDRESM1-FG801-00.DWG	CLOSURE STRUCTURES WEST SERVICE ROAD CROSSING ELEVATION
FG802	SANDRESM1-FG802-00.DWG	CLOSURE STRUCTURES WEST SERVICE ROAD CROSSING SECTIONS
FG850	SANDRESM1-FG850-00.DWG	CLOSURE STRUCTURES ASSER LEVY ROLLER GATE PLAN
FG851	SANDRESM1-FG851-00.DWG	CLOSURE STRUCTURES ASSER LEVY ROLLER GATE ELEVATION
FG852	SANDRESM1-FG852-00.DWG	CLOSURE STRUCTURES ASSER LEVY ROLLER GATE REGRADING OVERALL PLAN
1 0032	3/ (ND (LESIVIE 1 0032 00.D V 0	CLOSORE STROCTORES ASSERTED IN ROLLER GATE REGRADING OVERALL FEAR

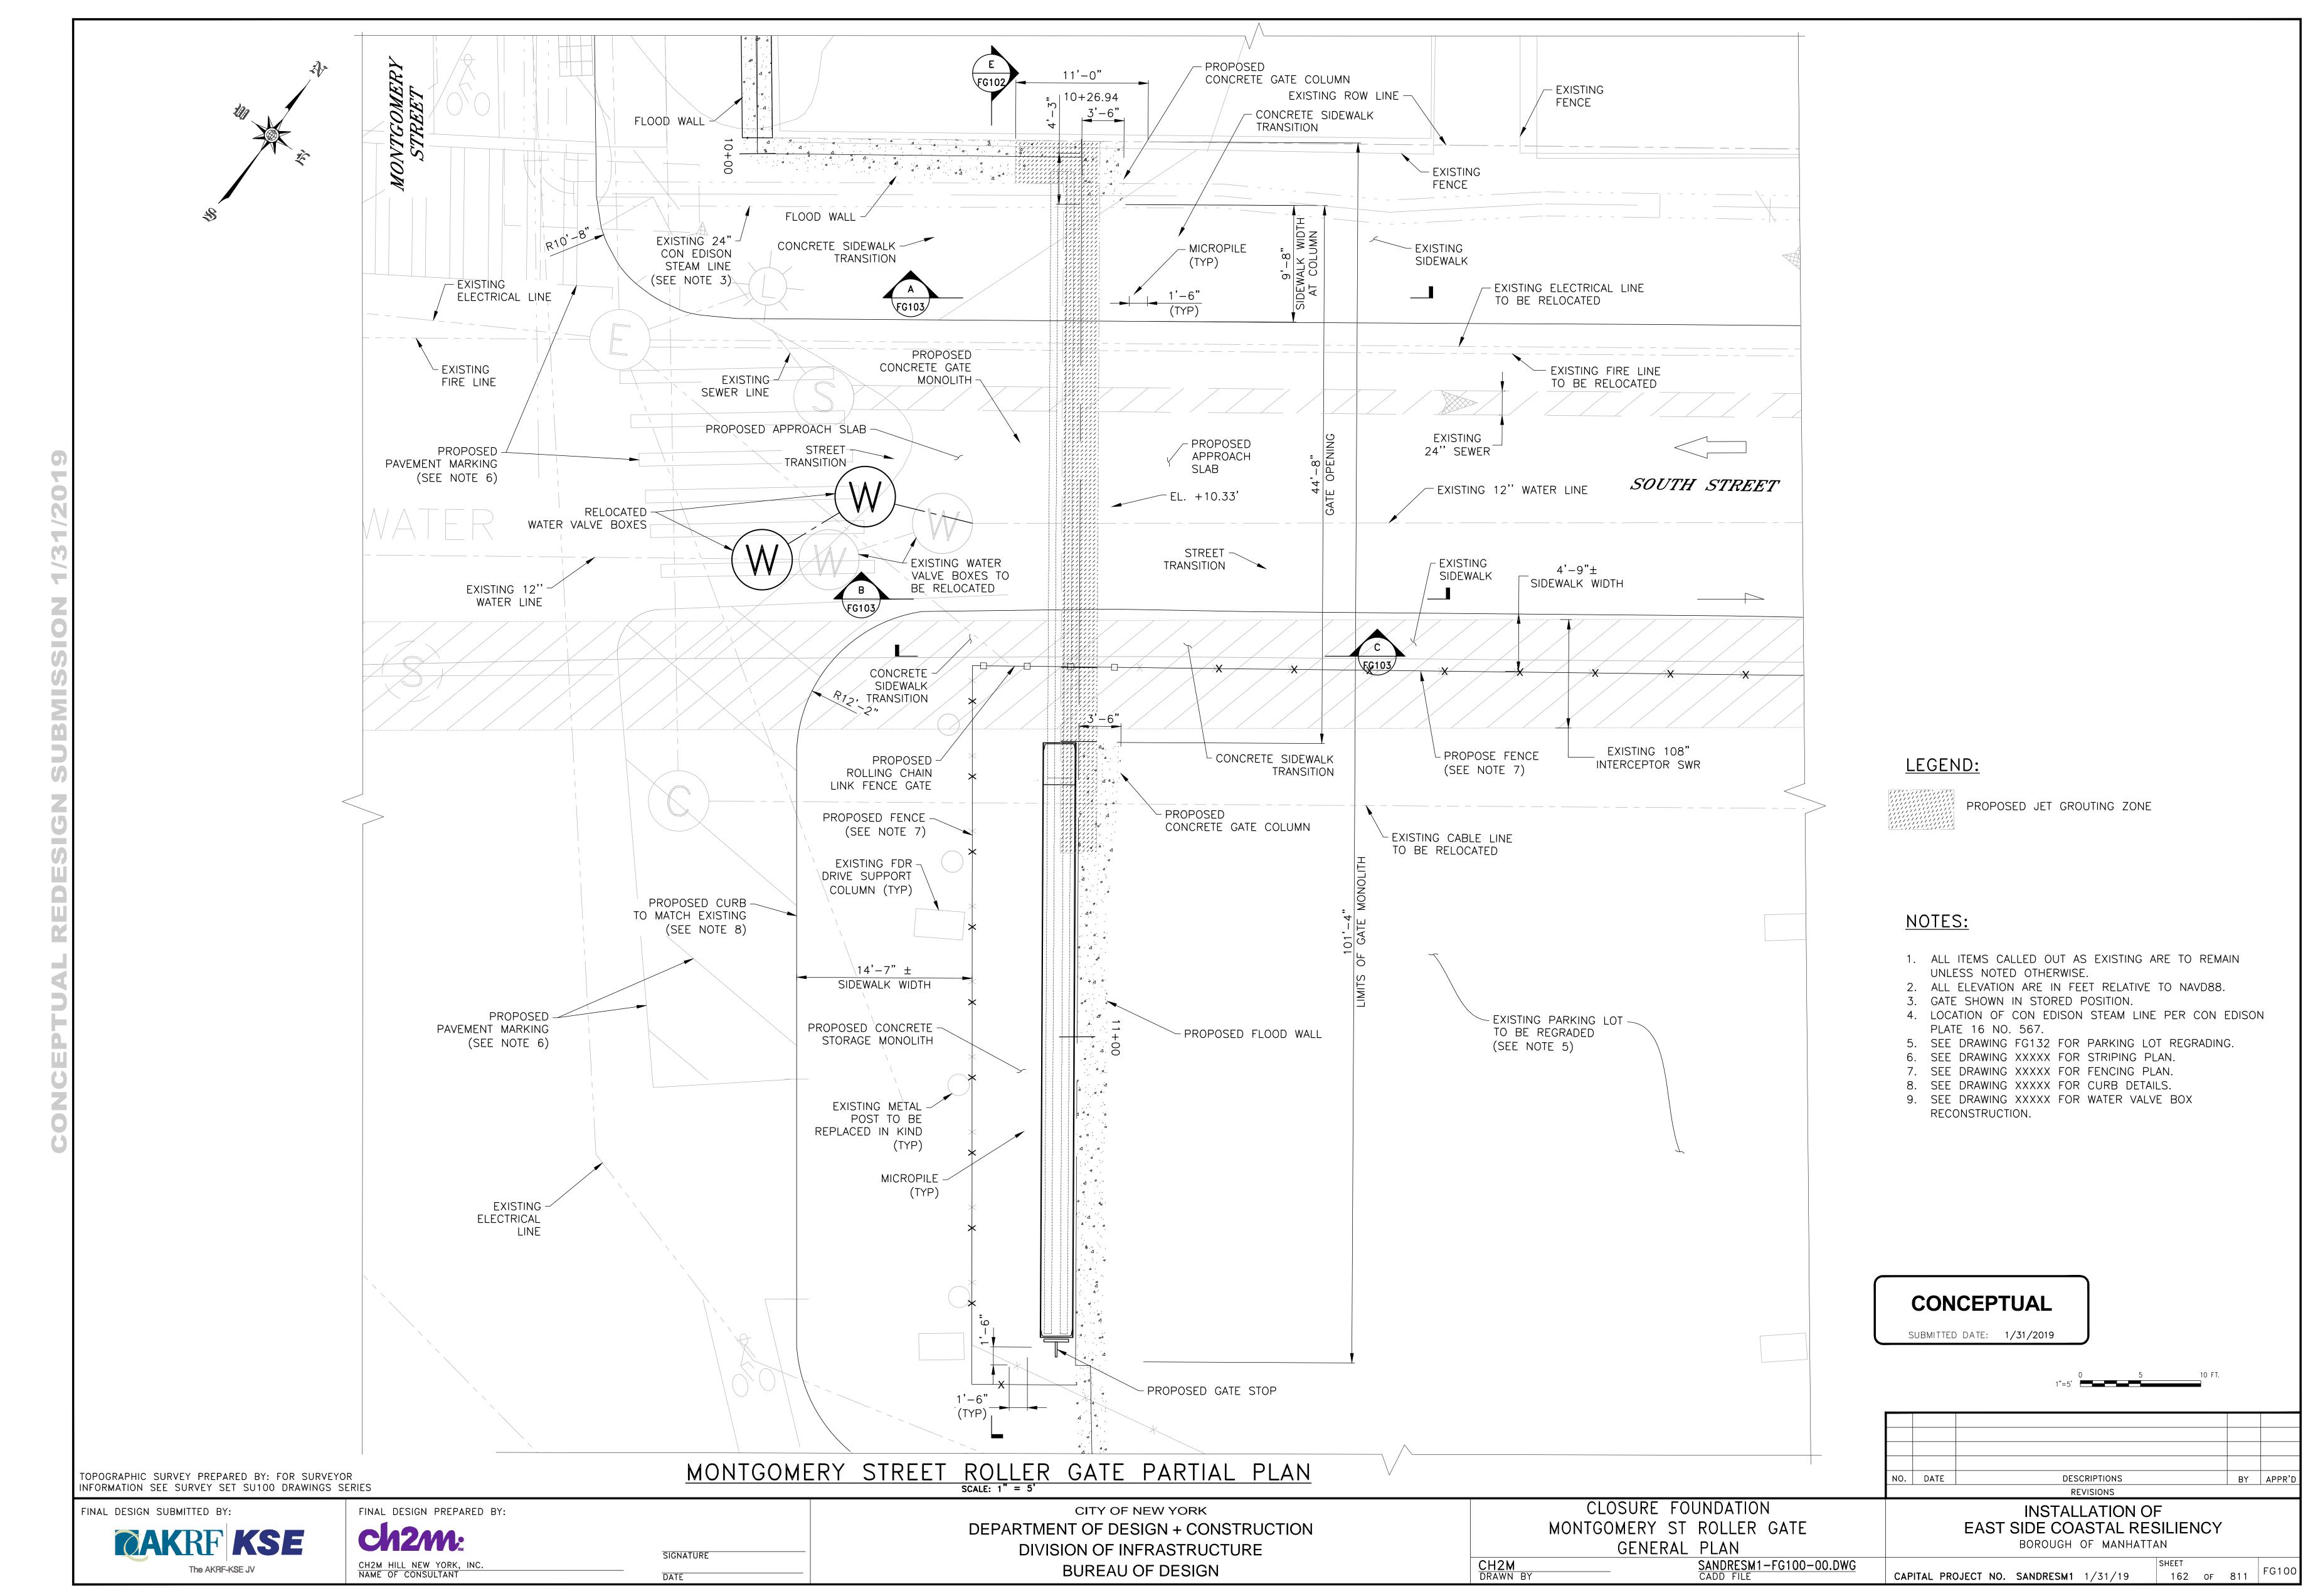


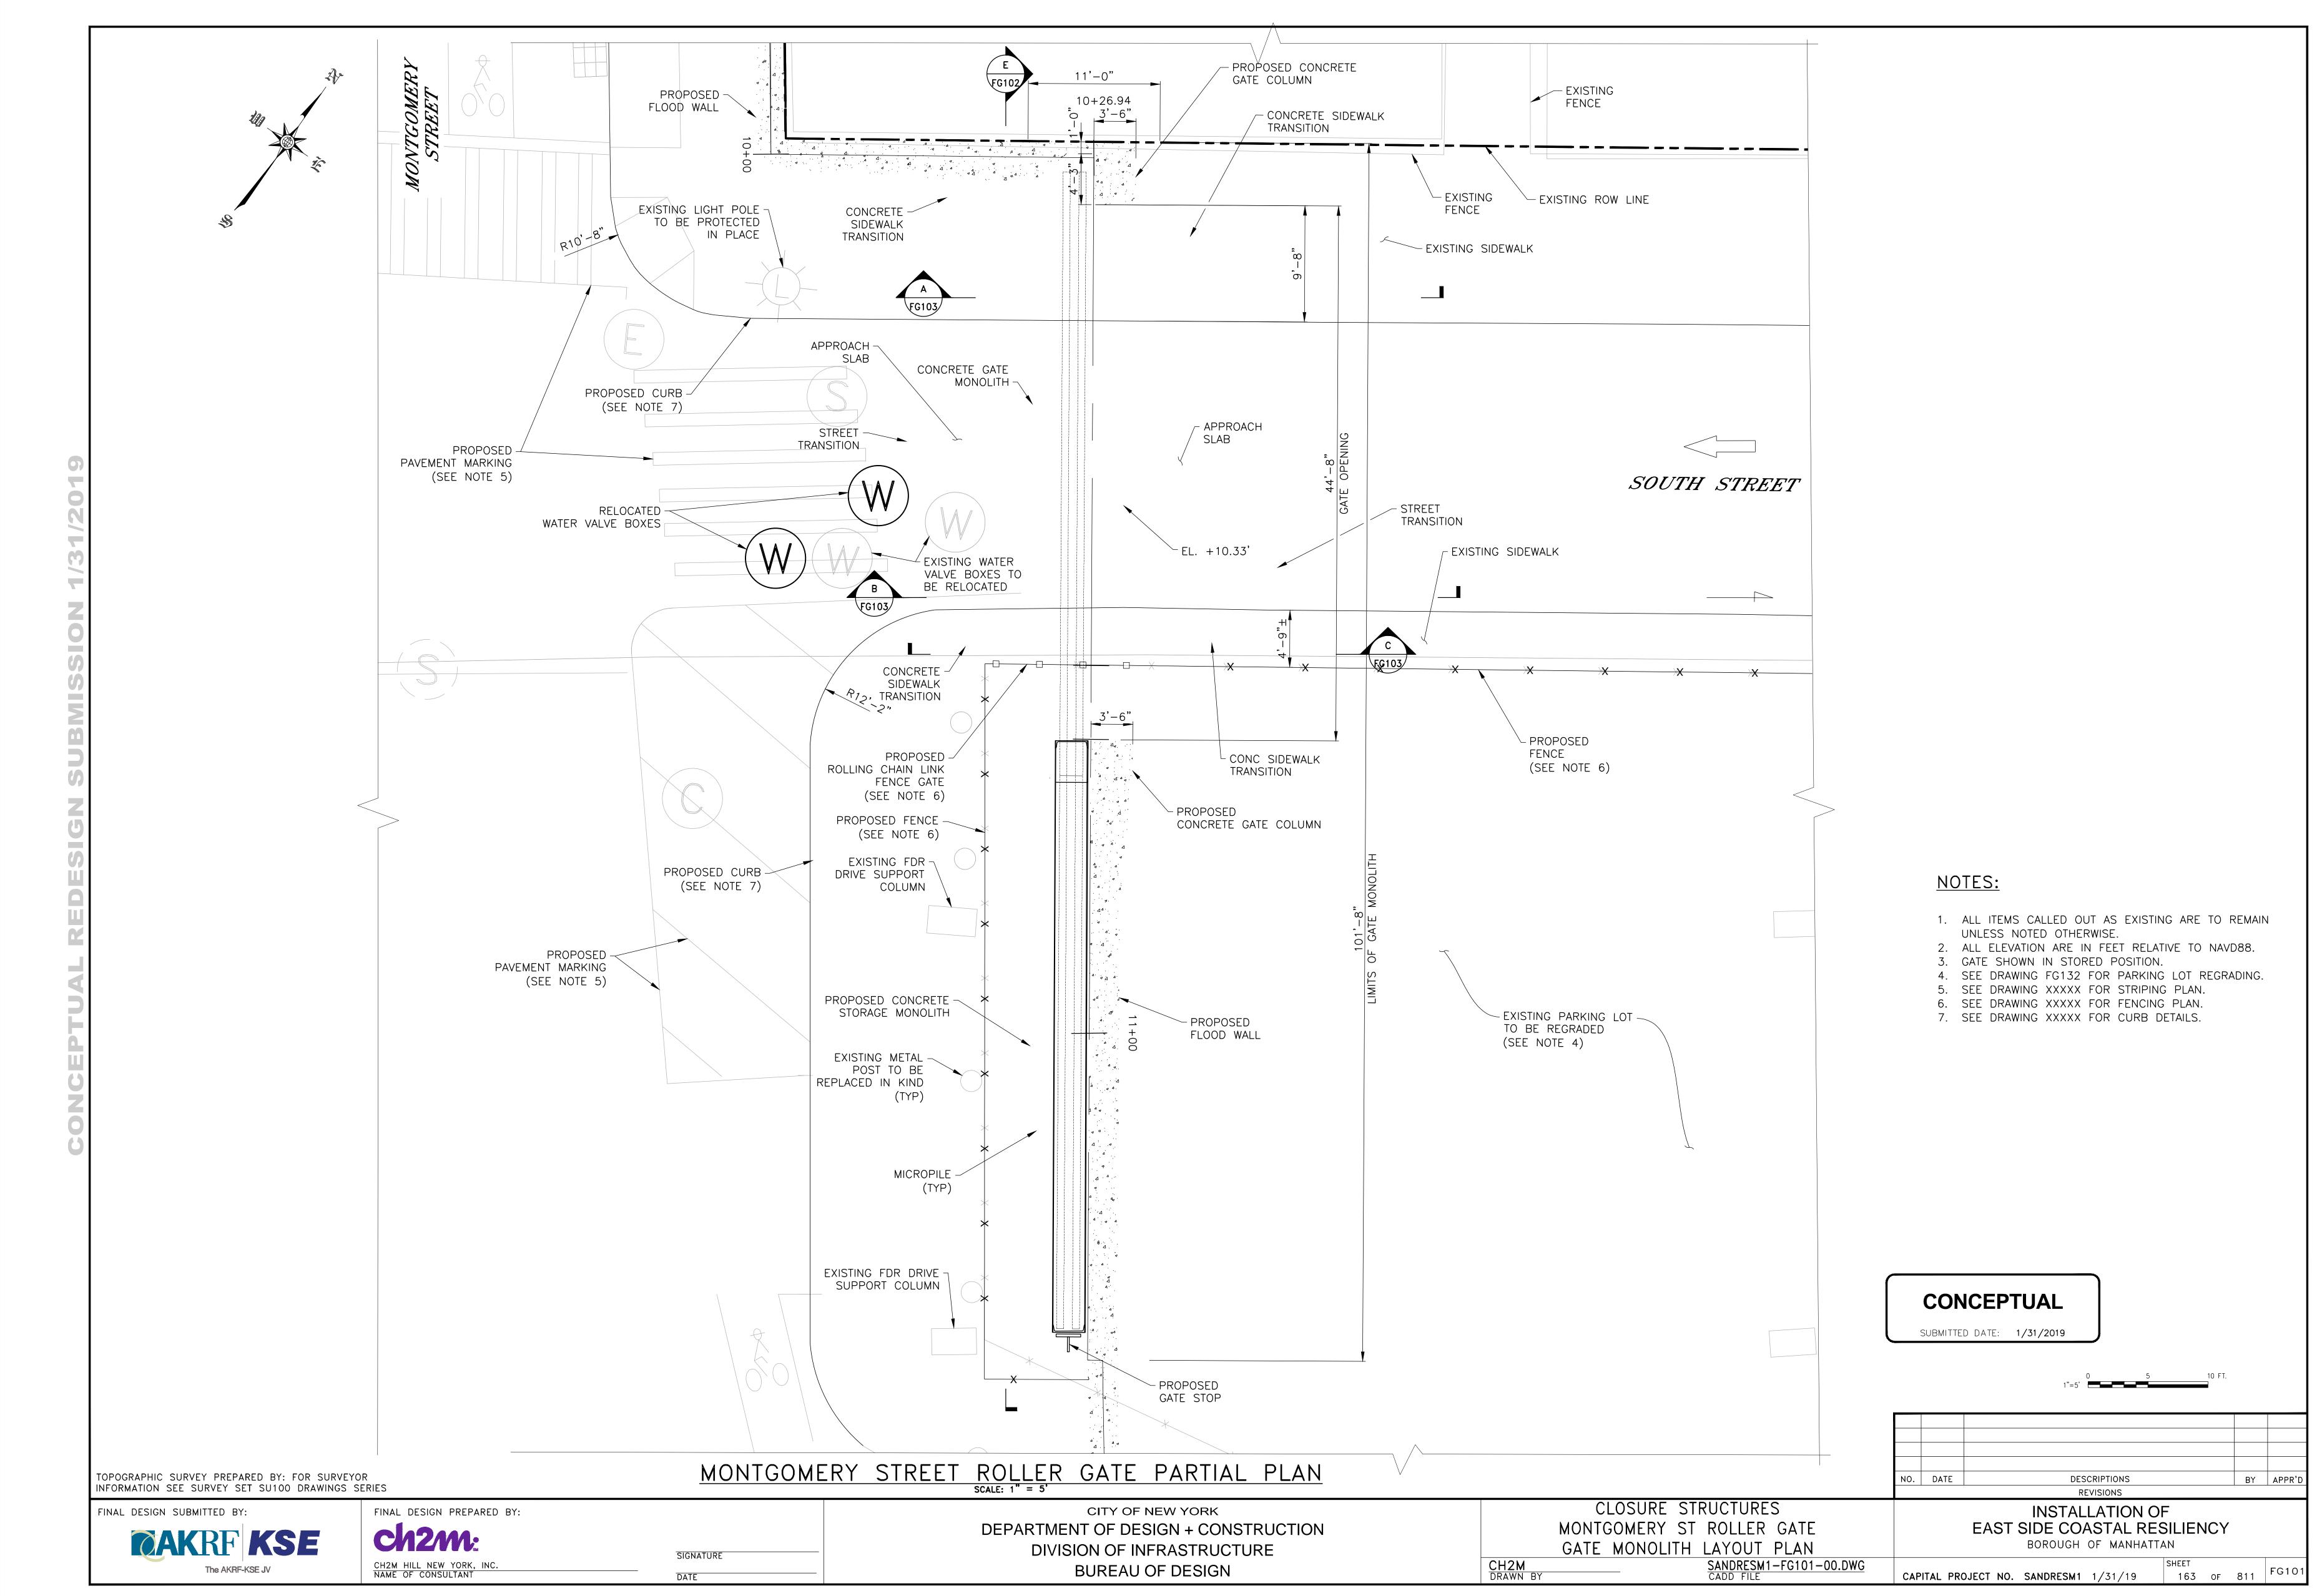


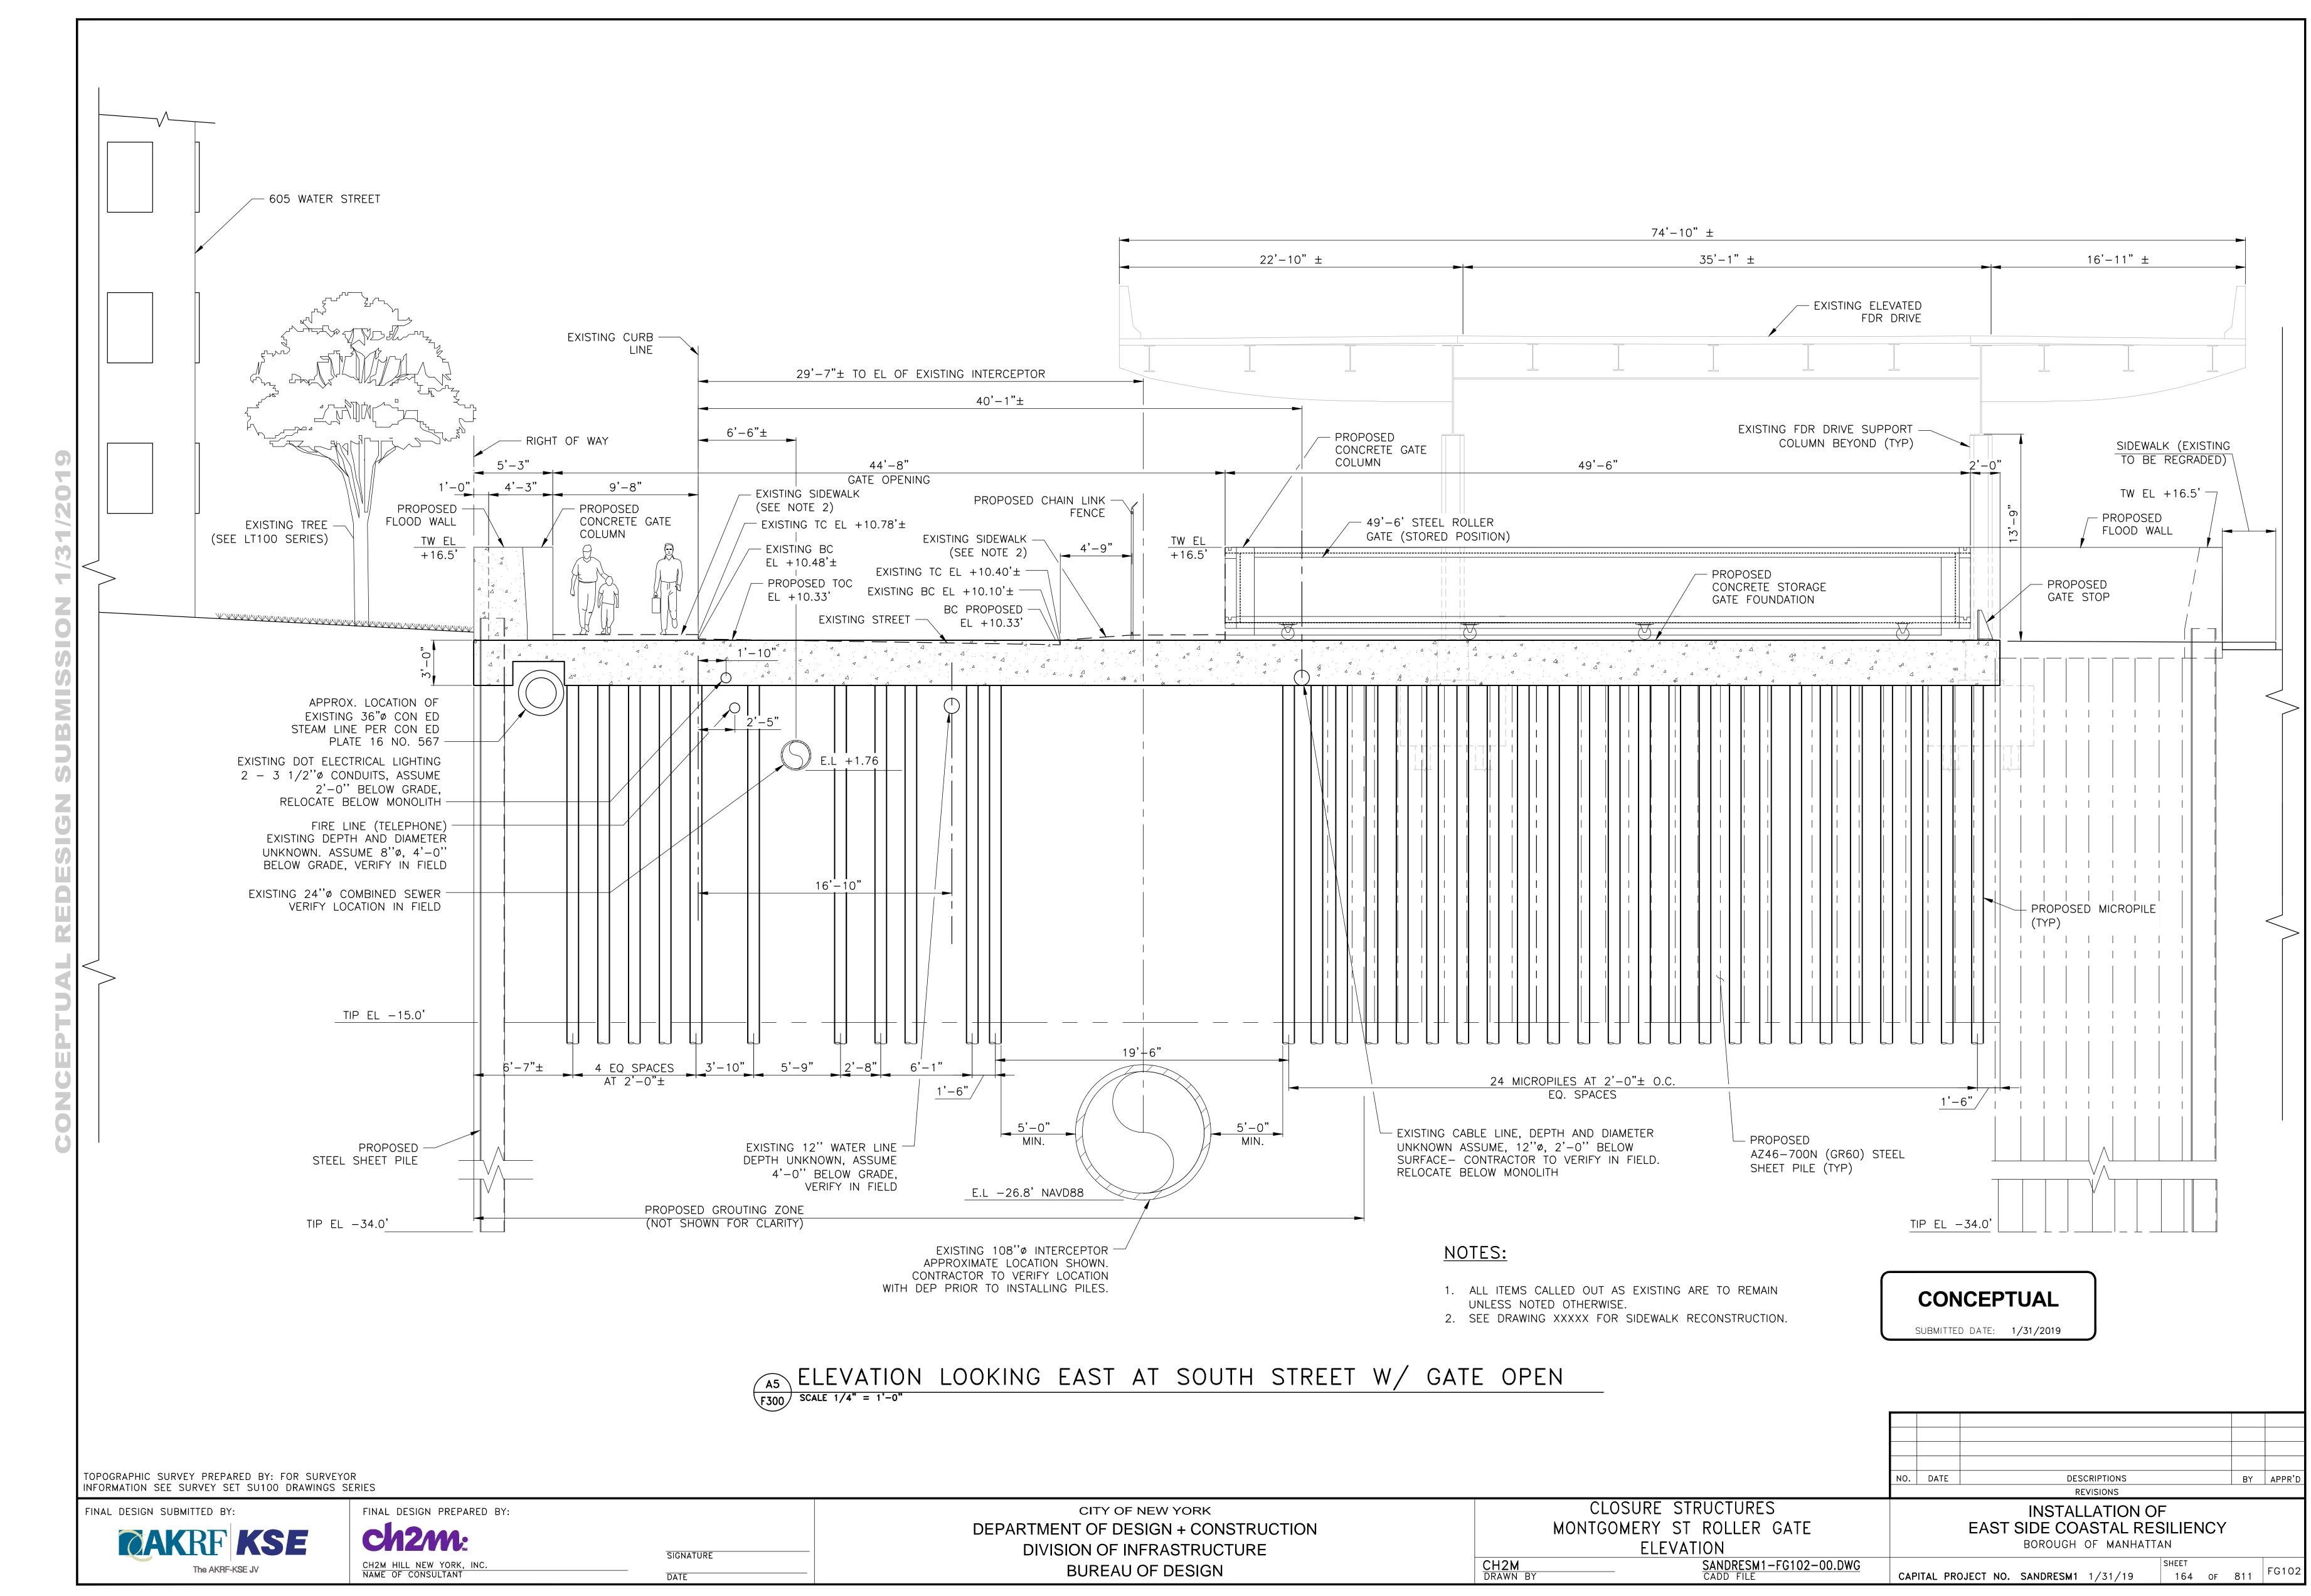


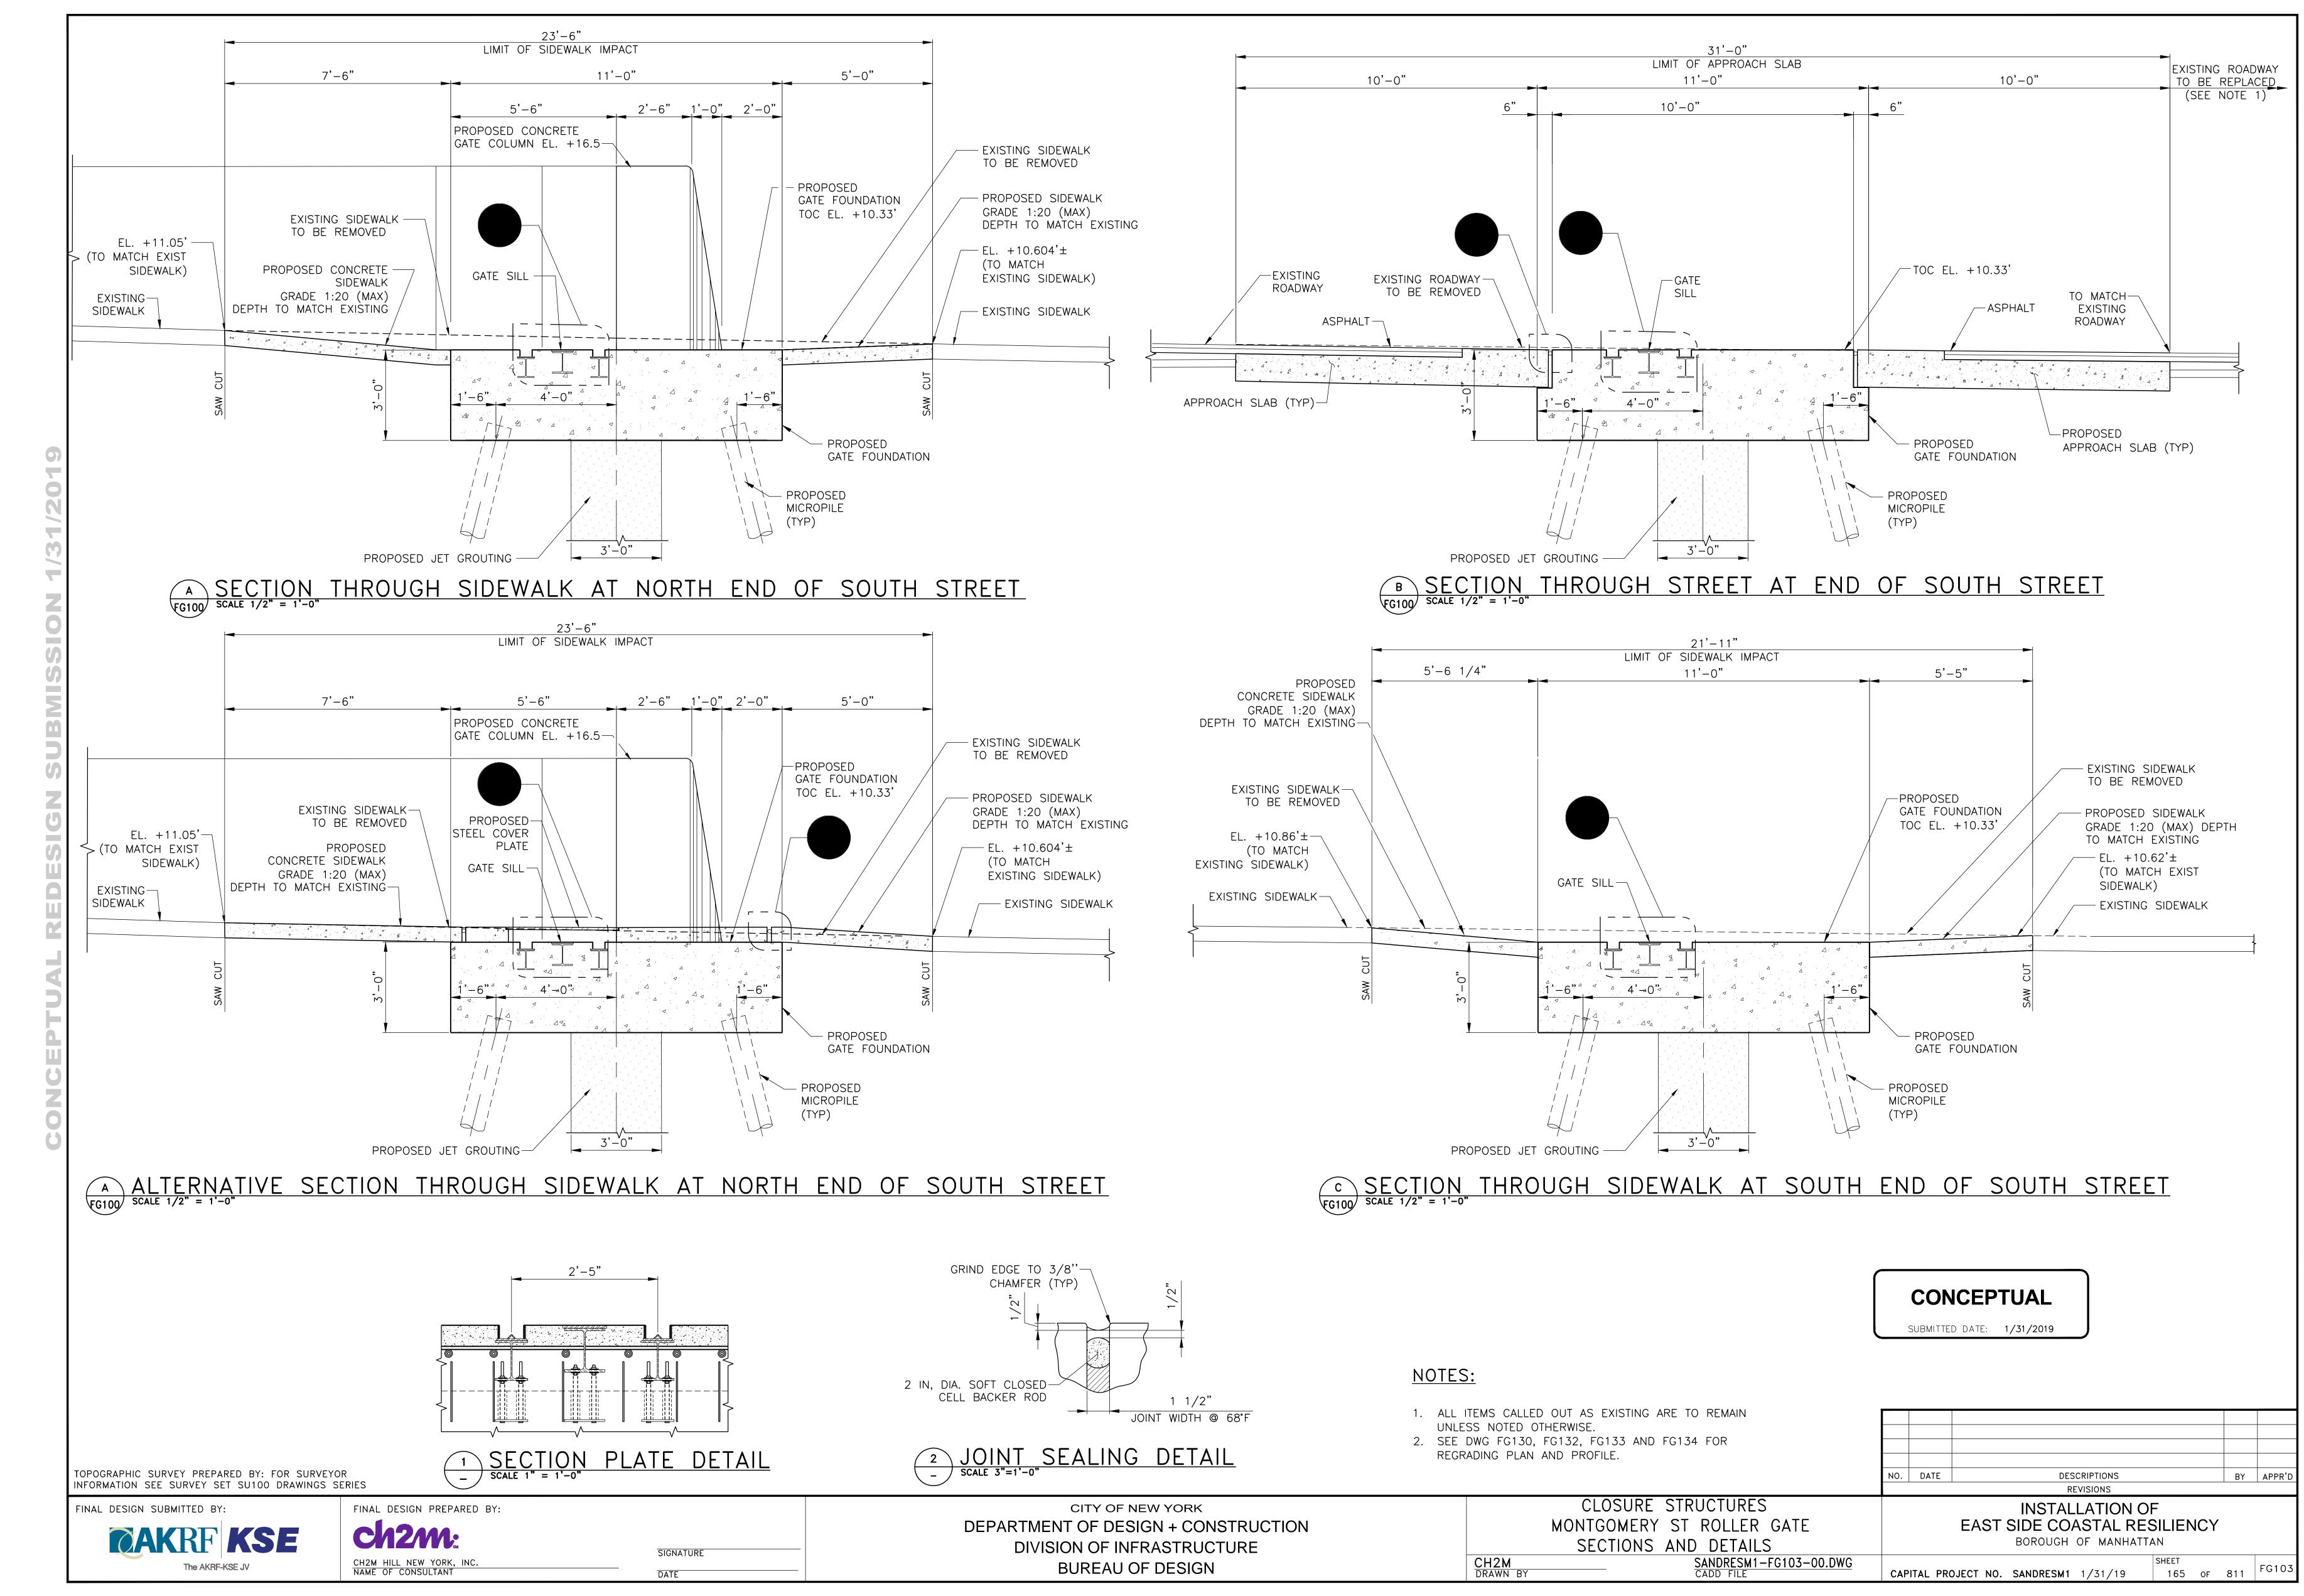


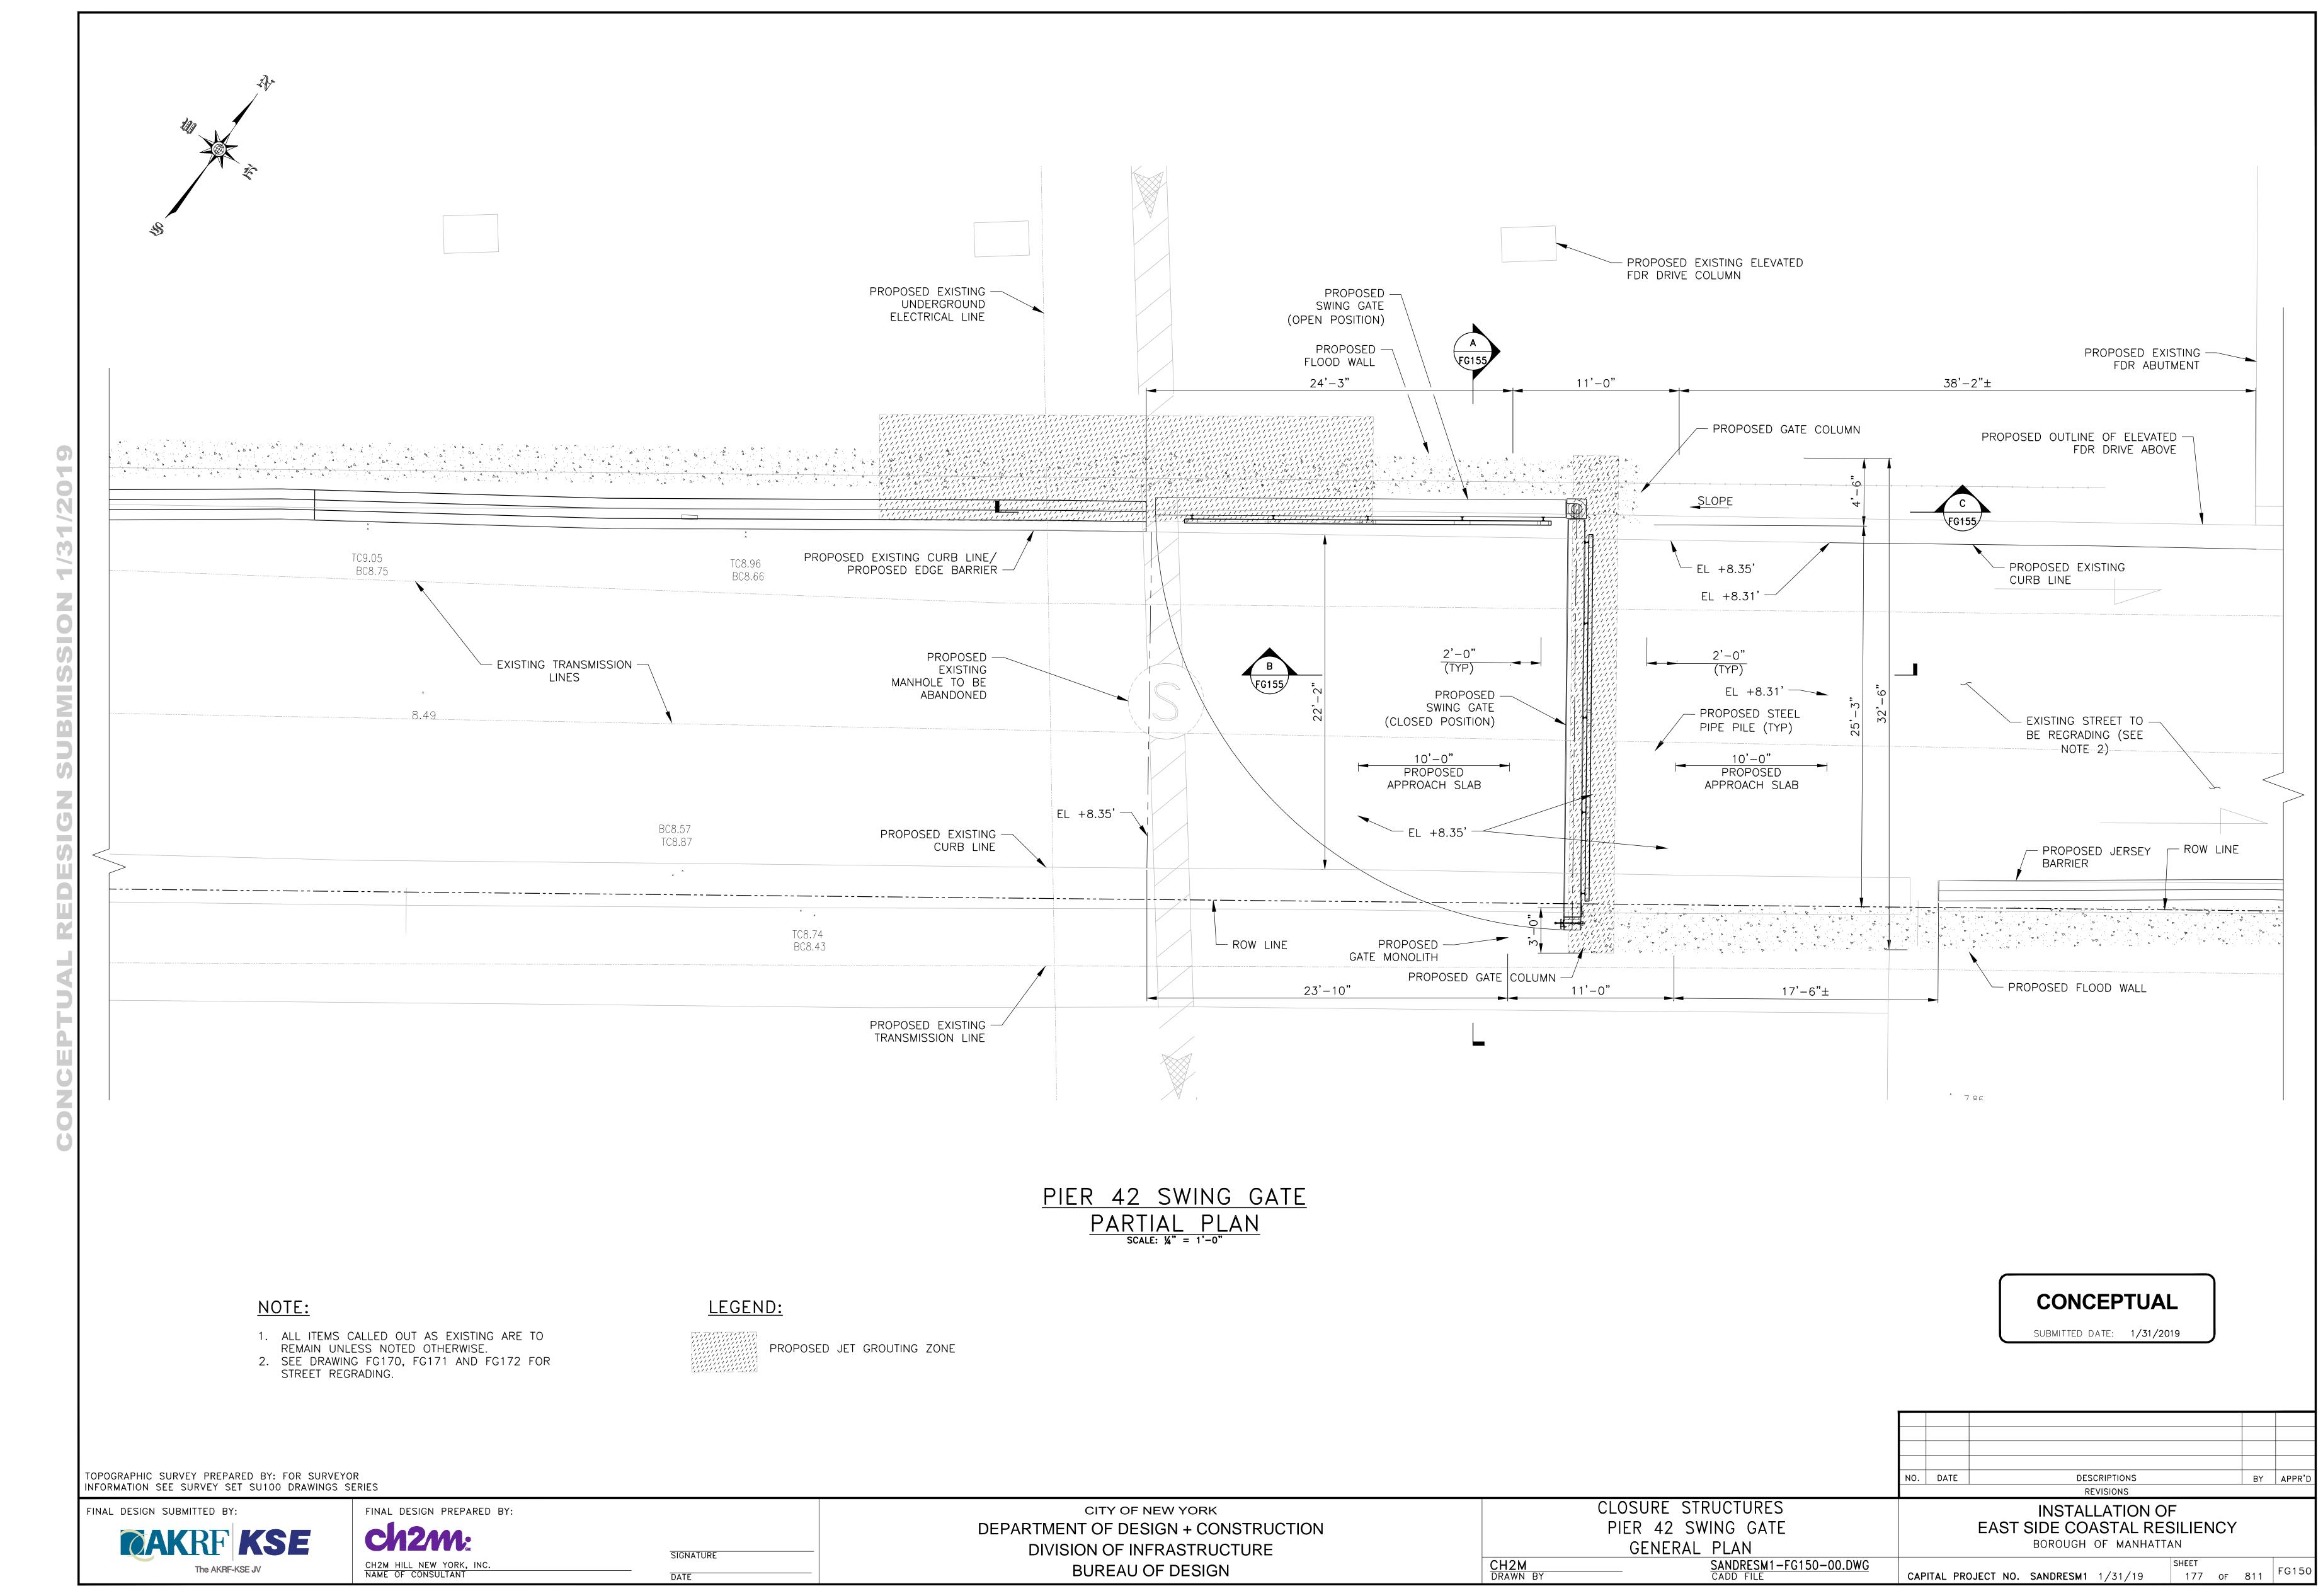


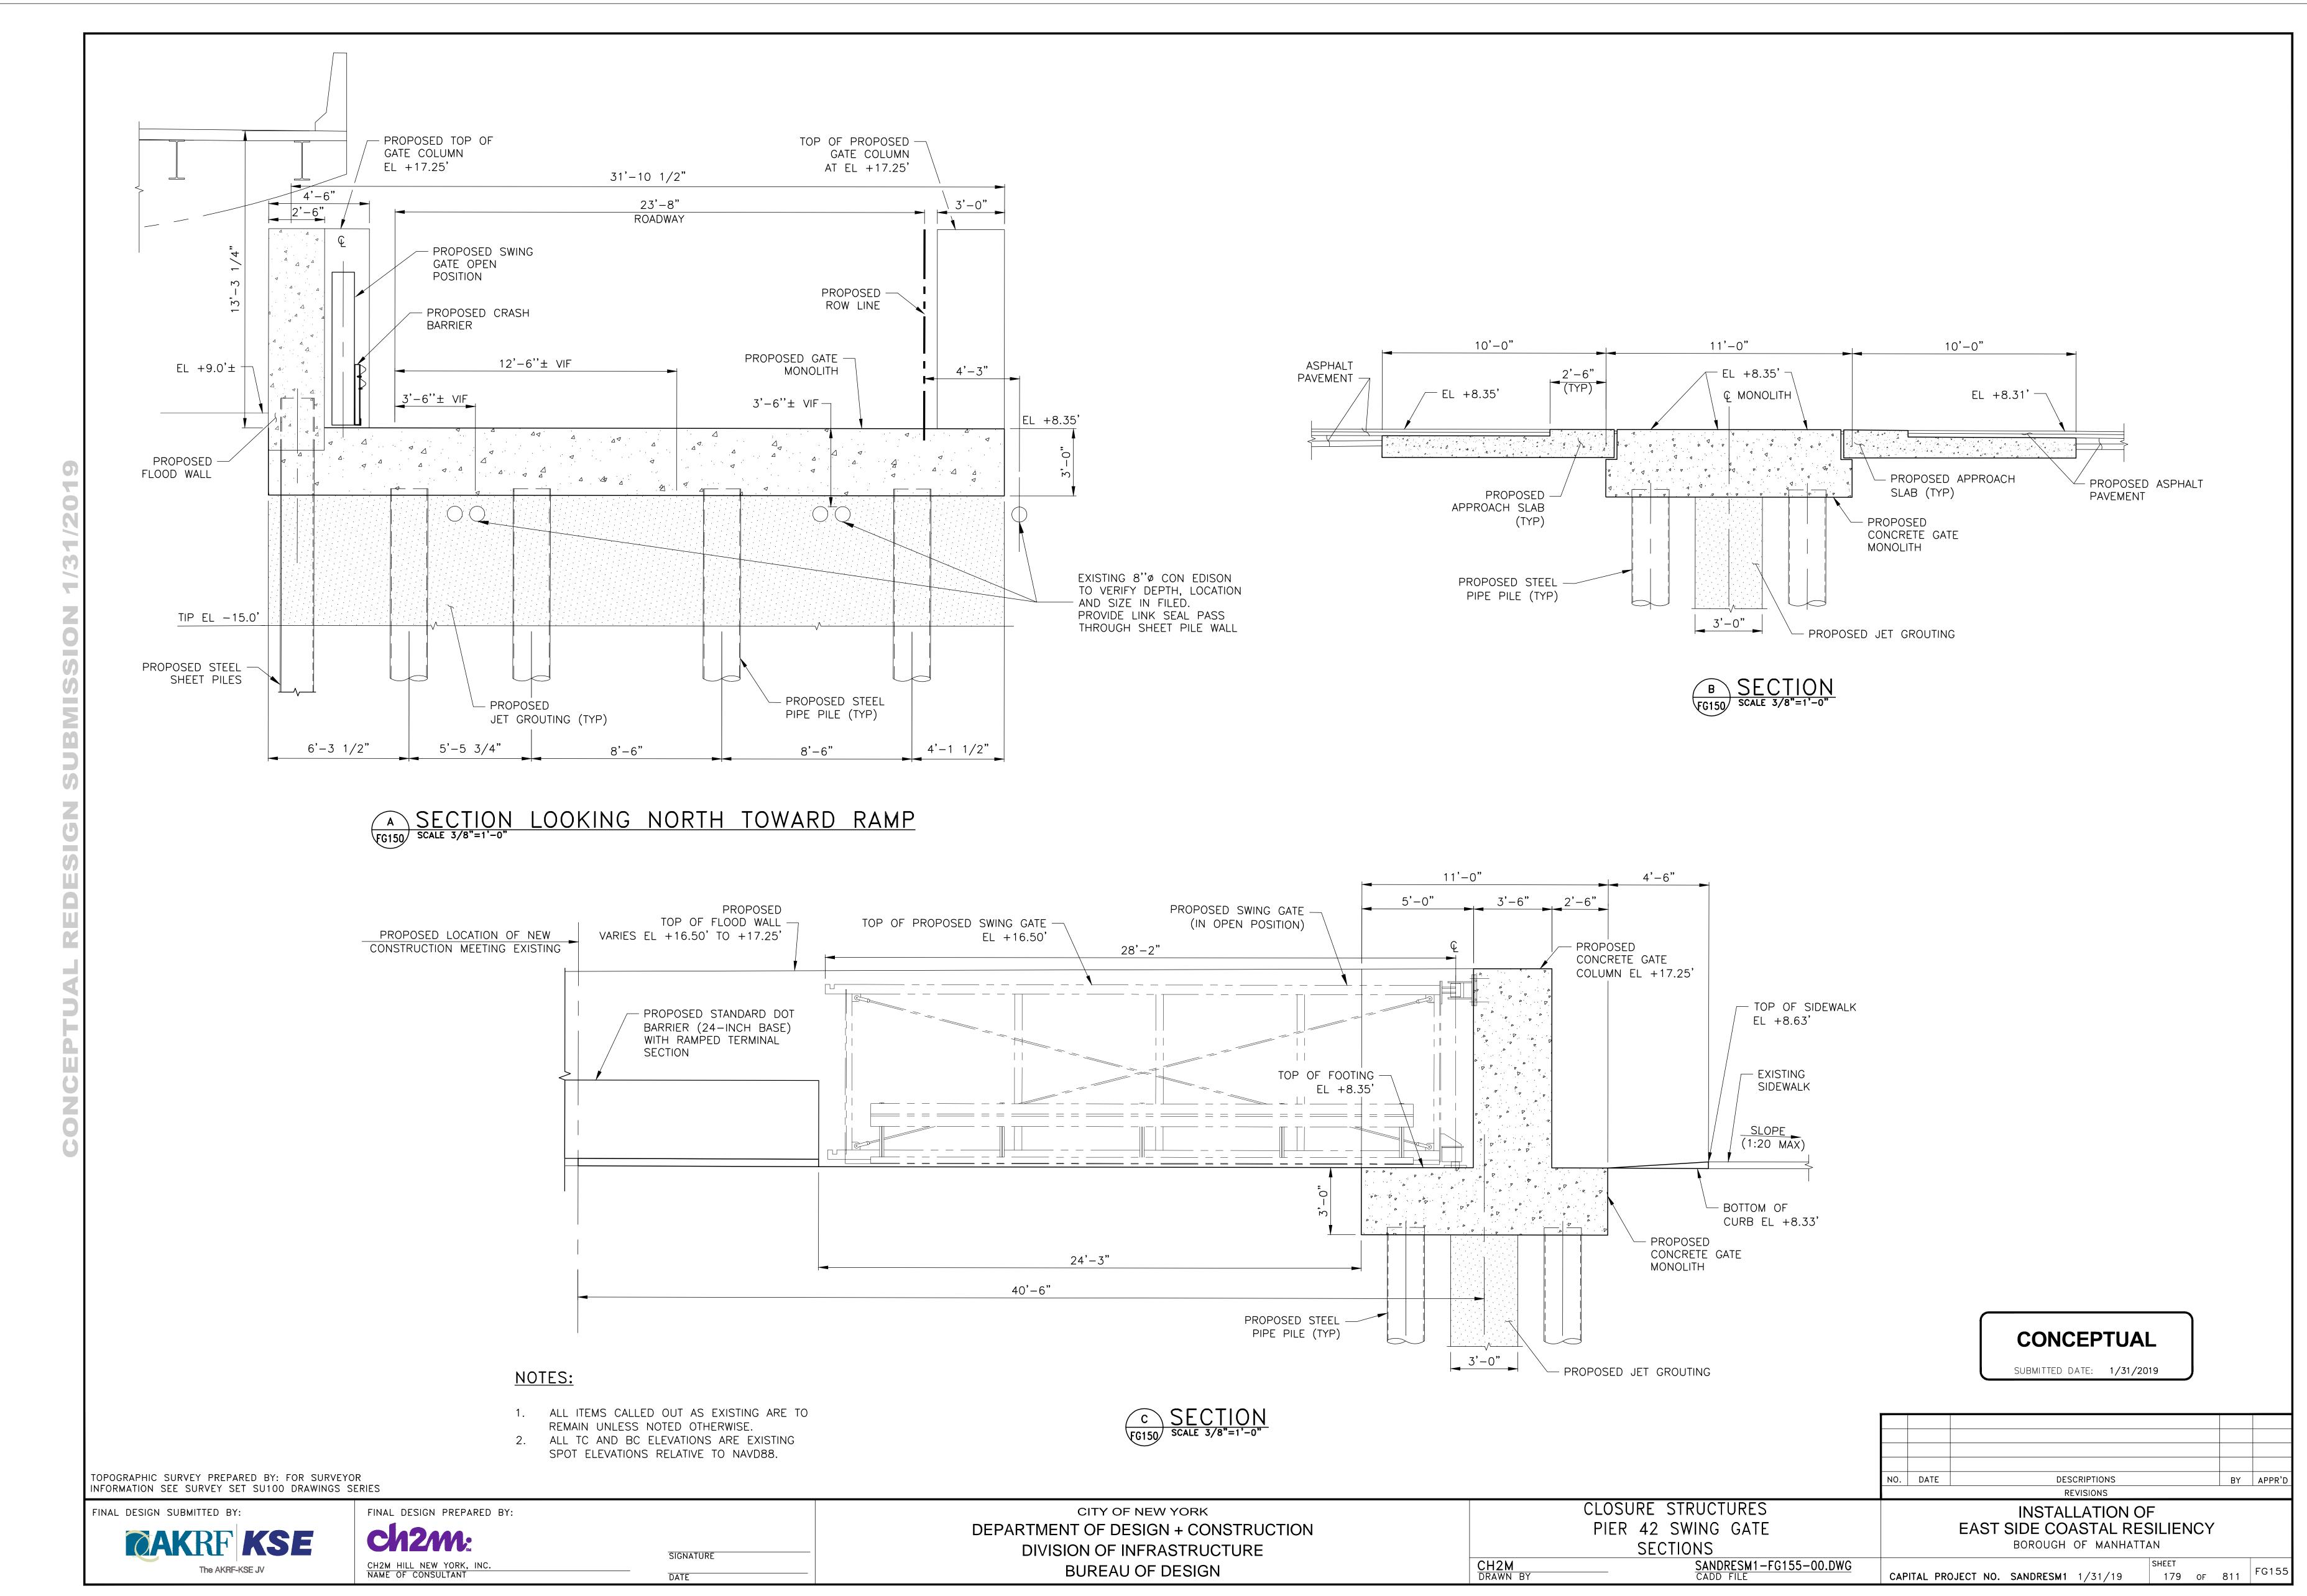


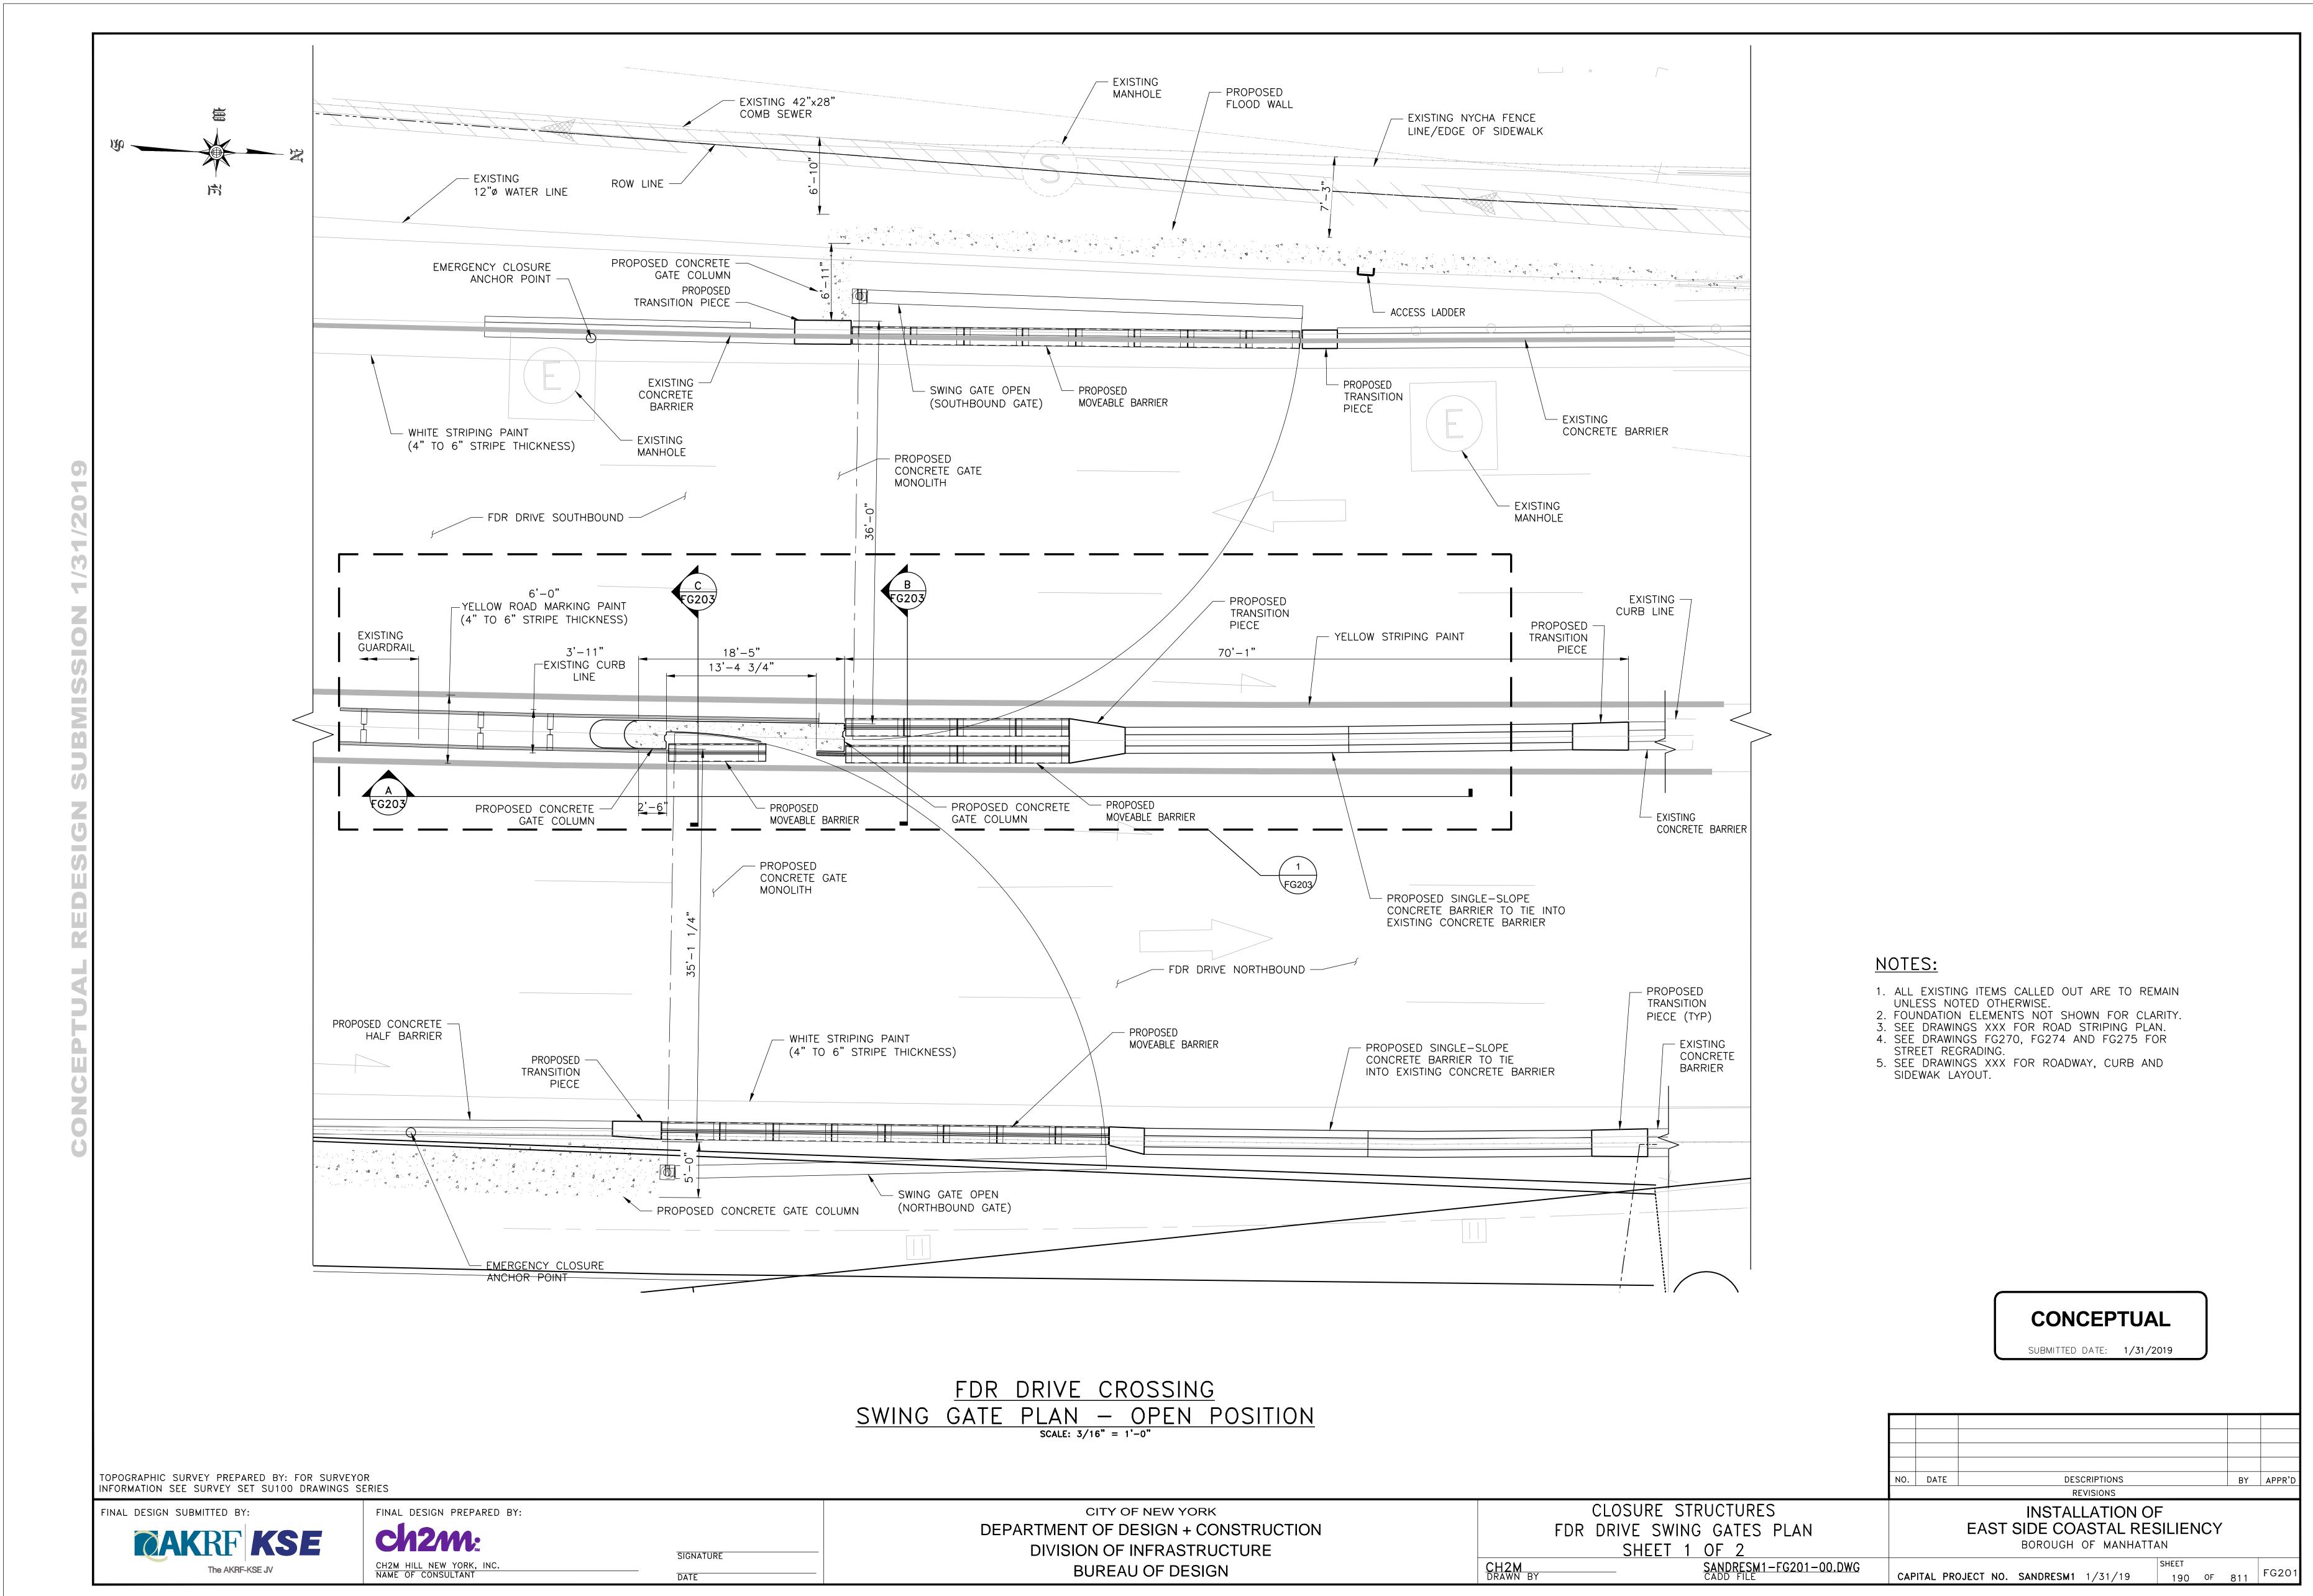


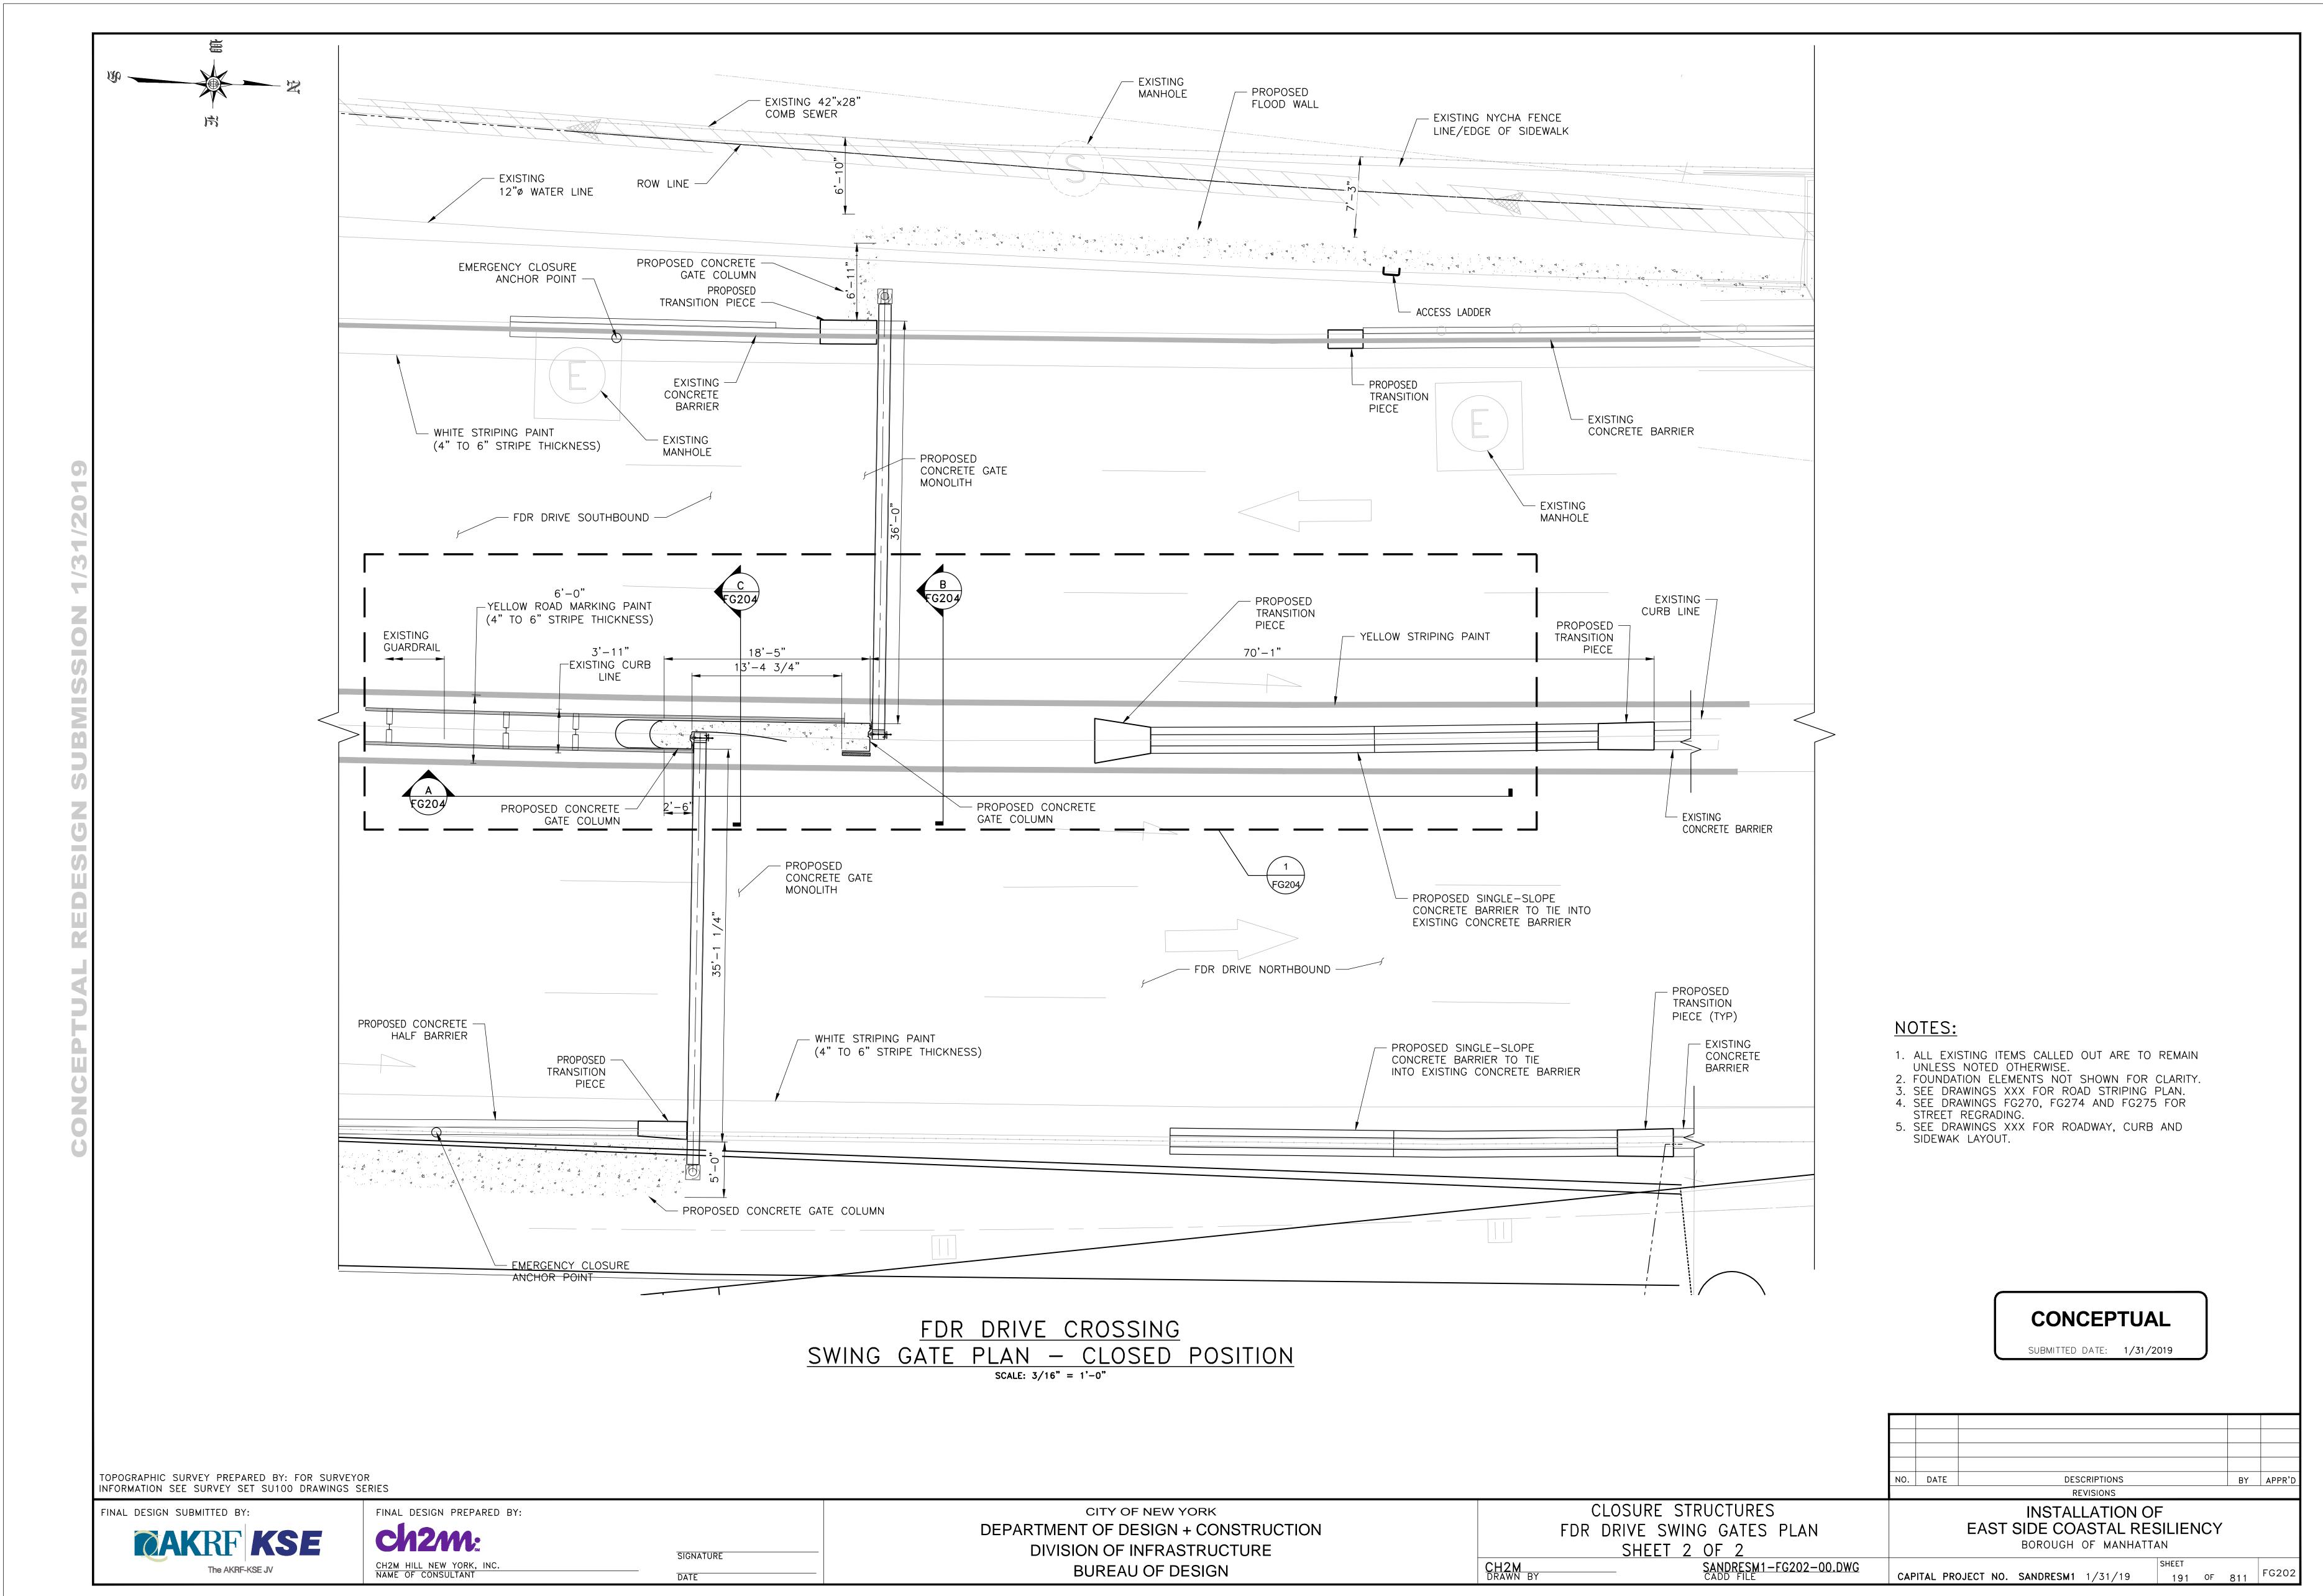

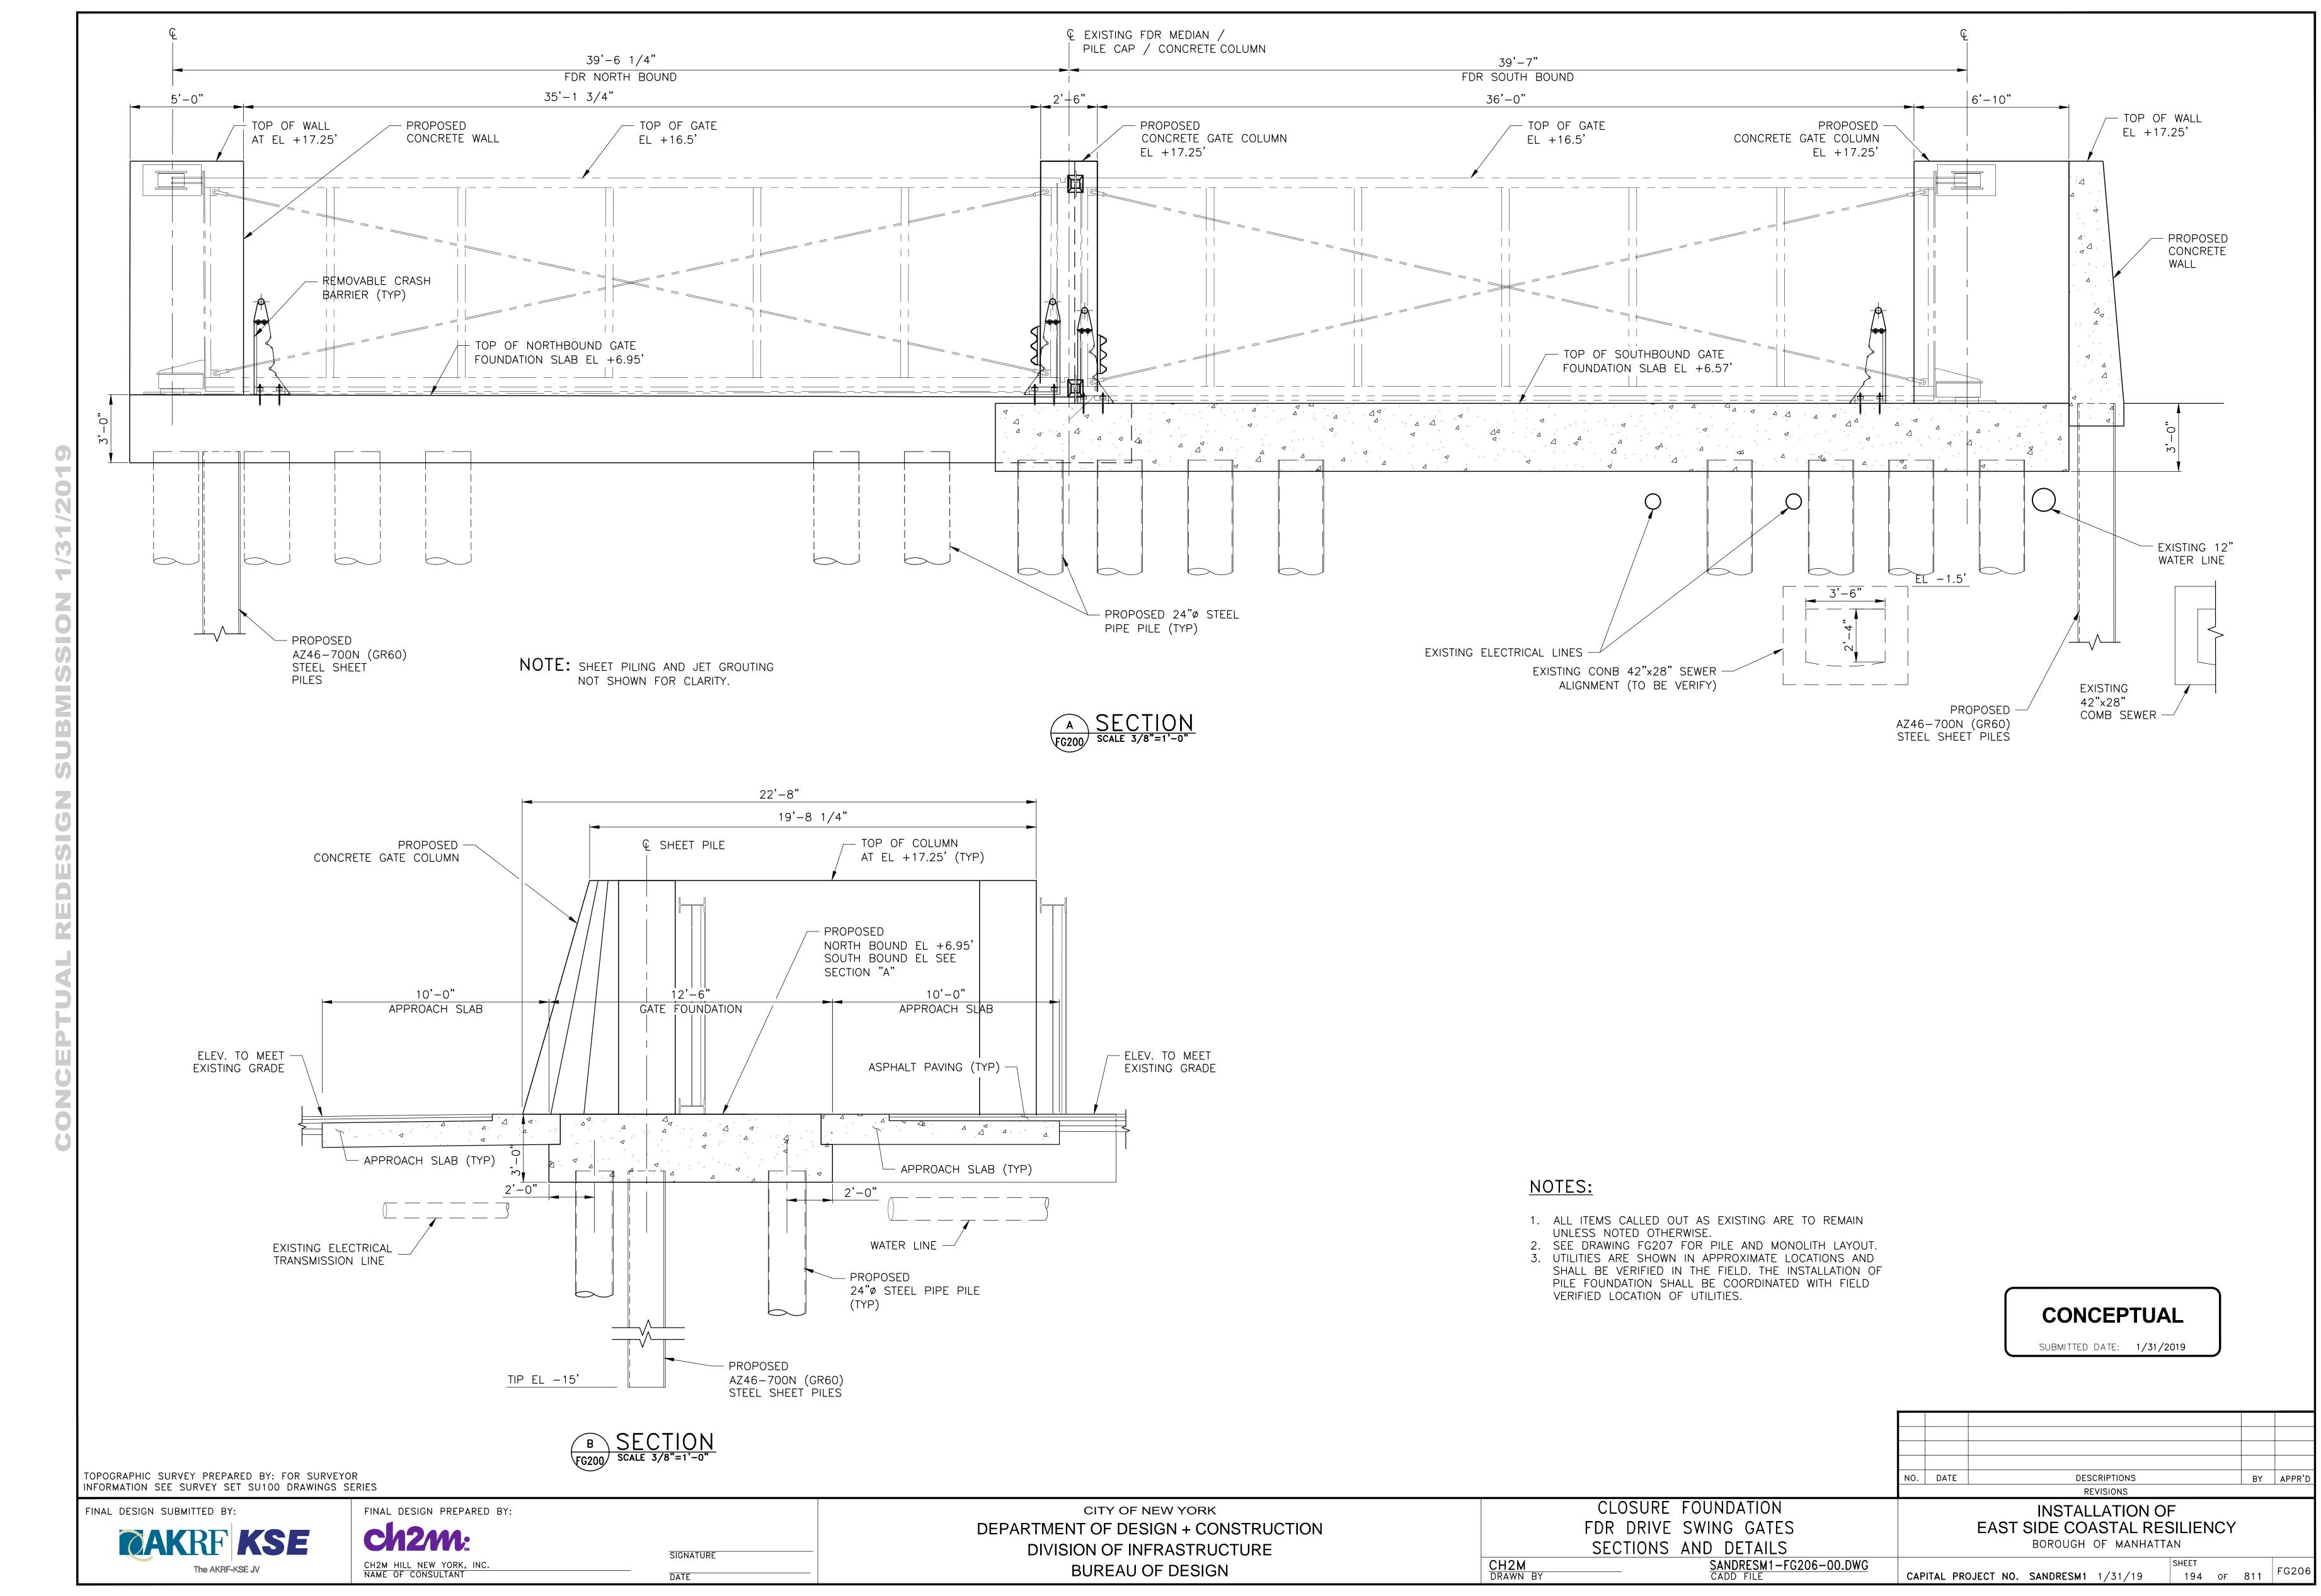

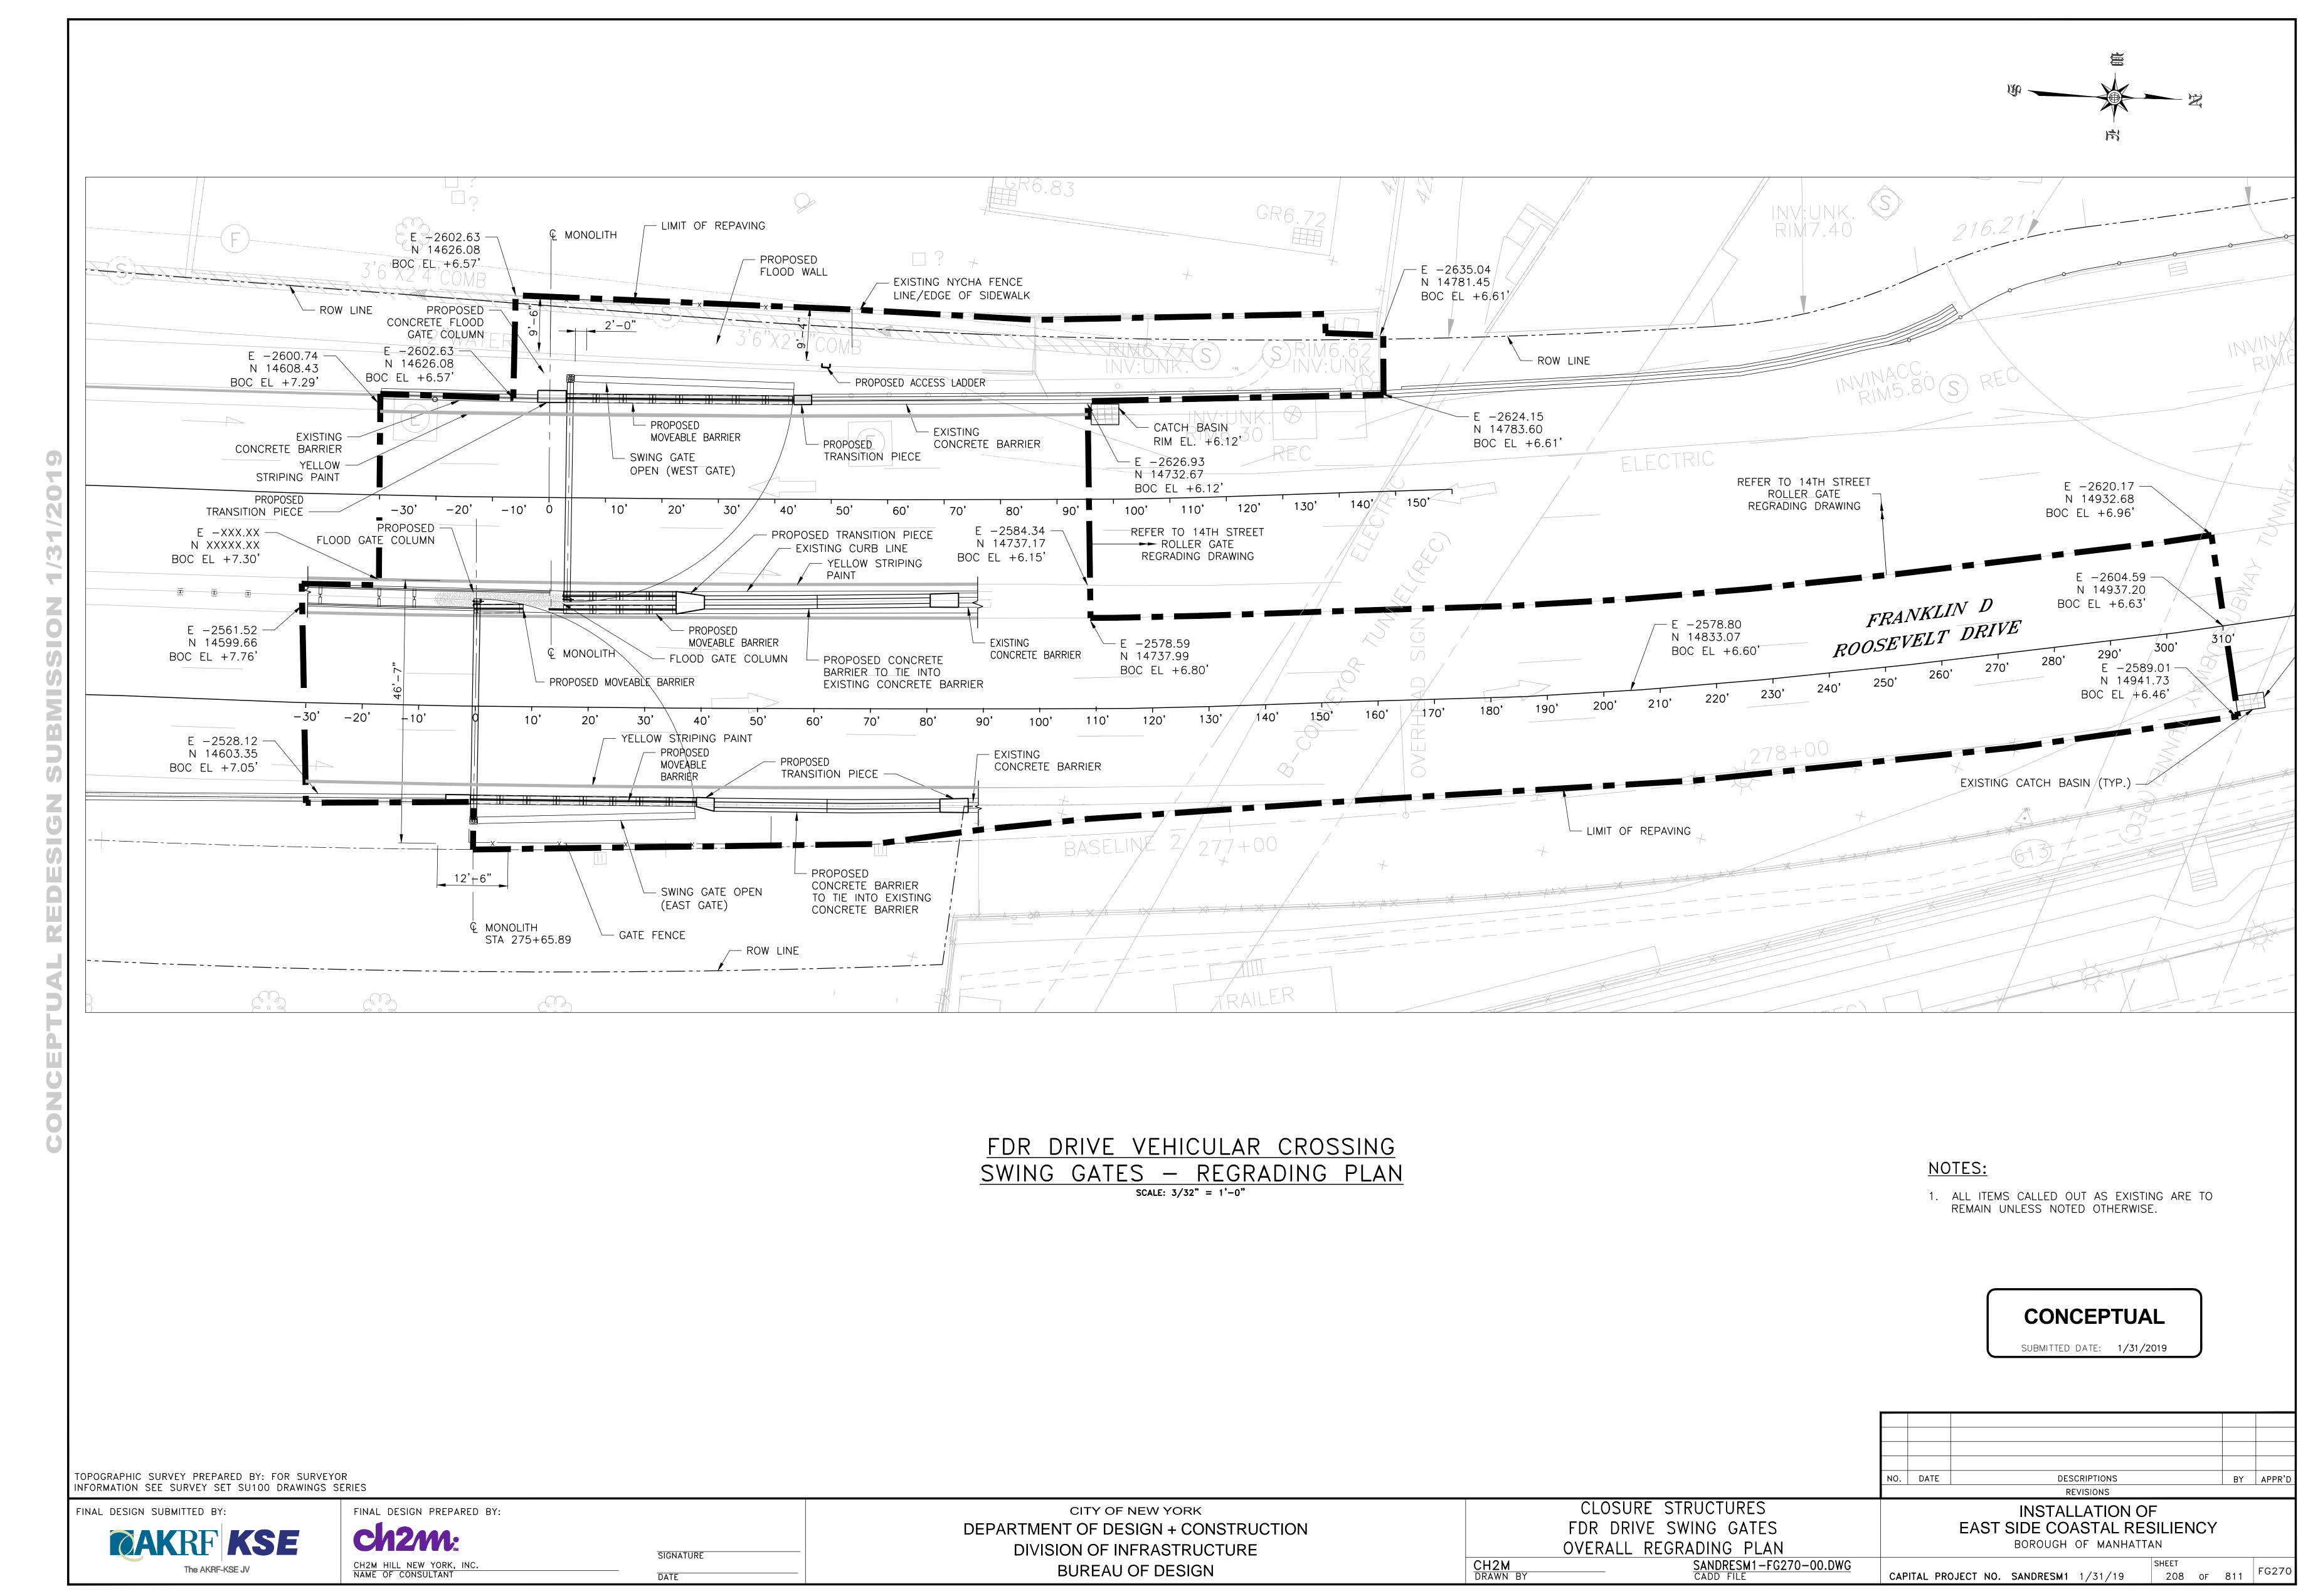

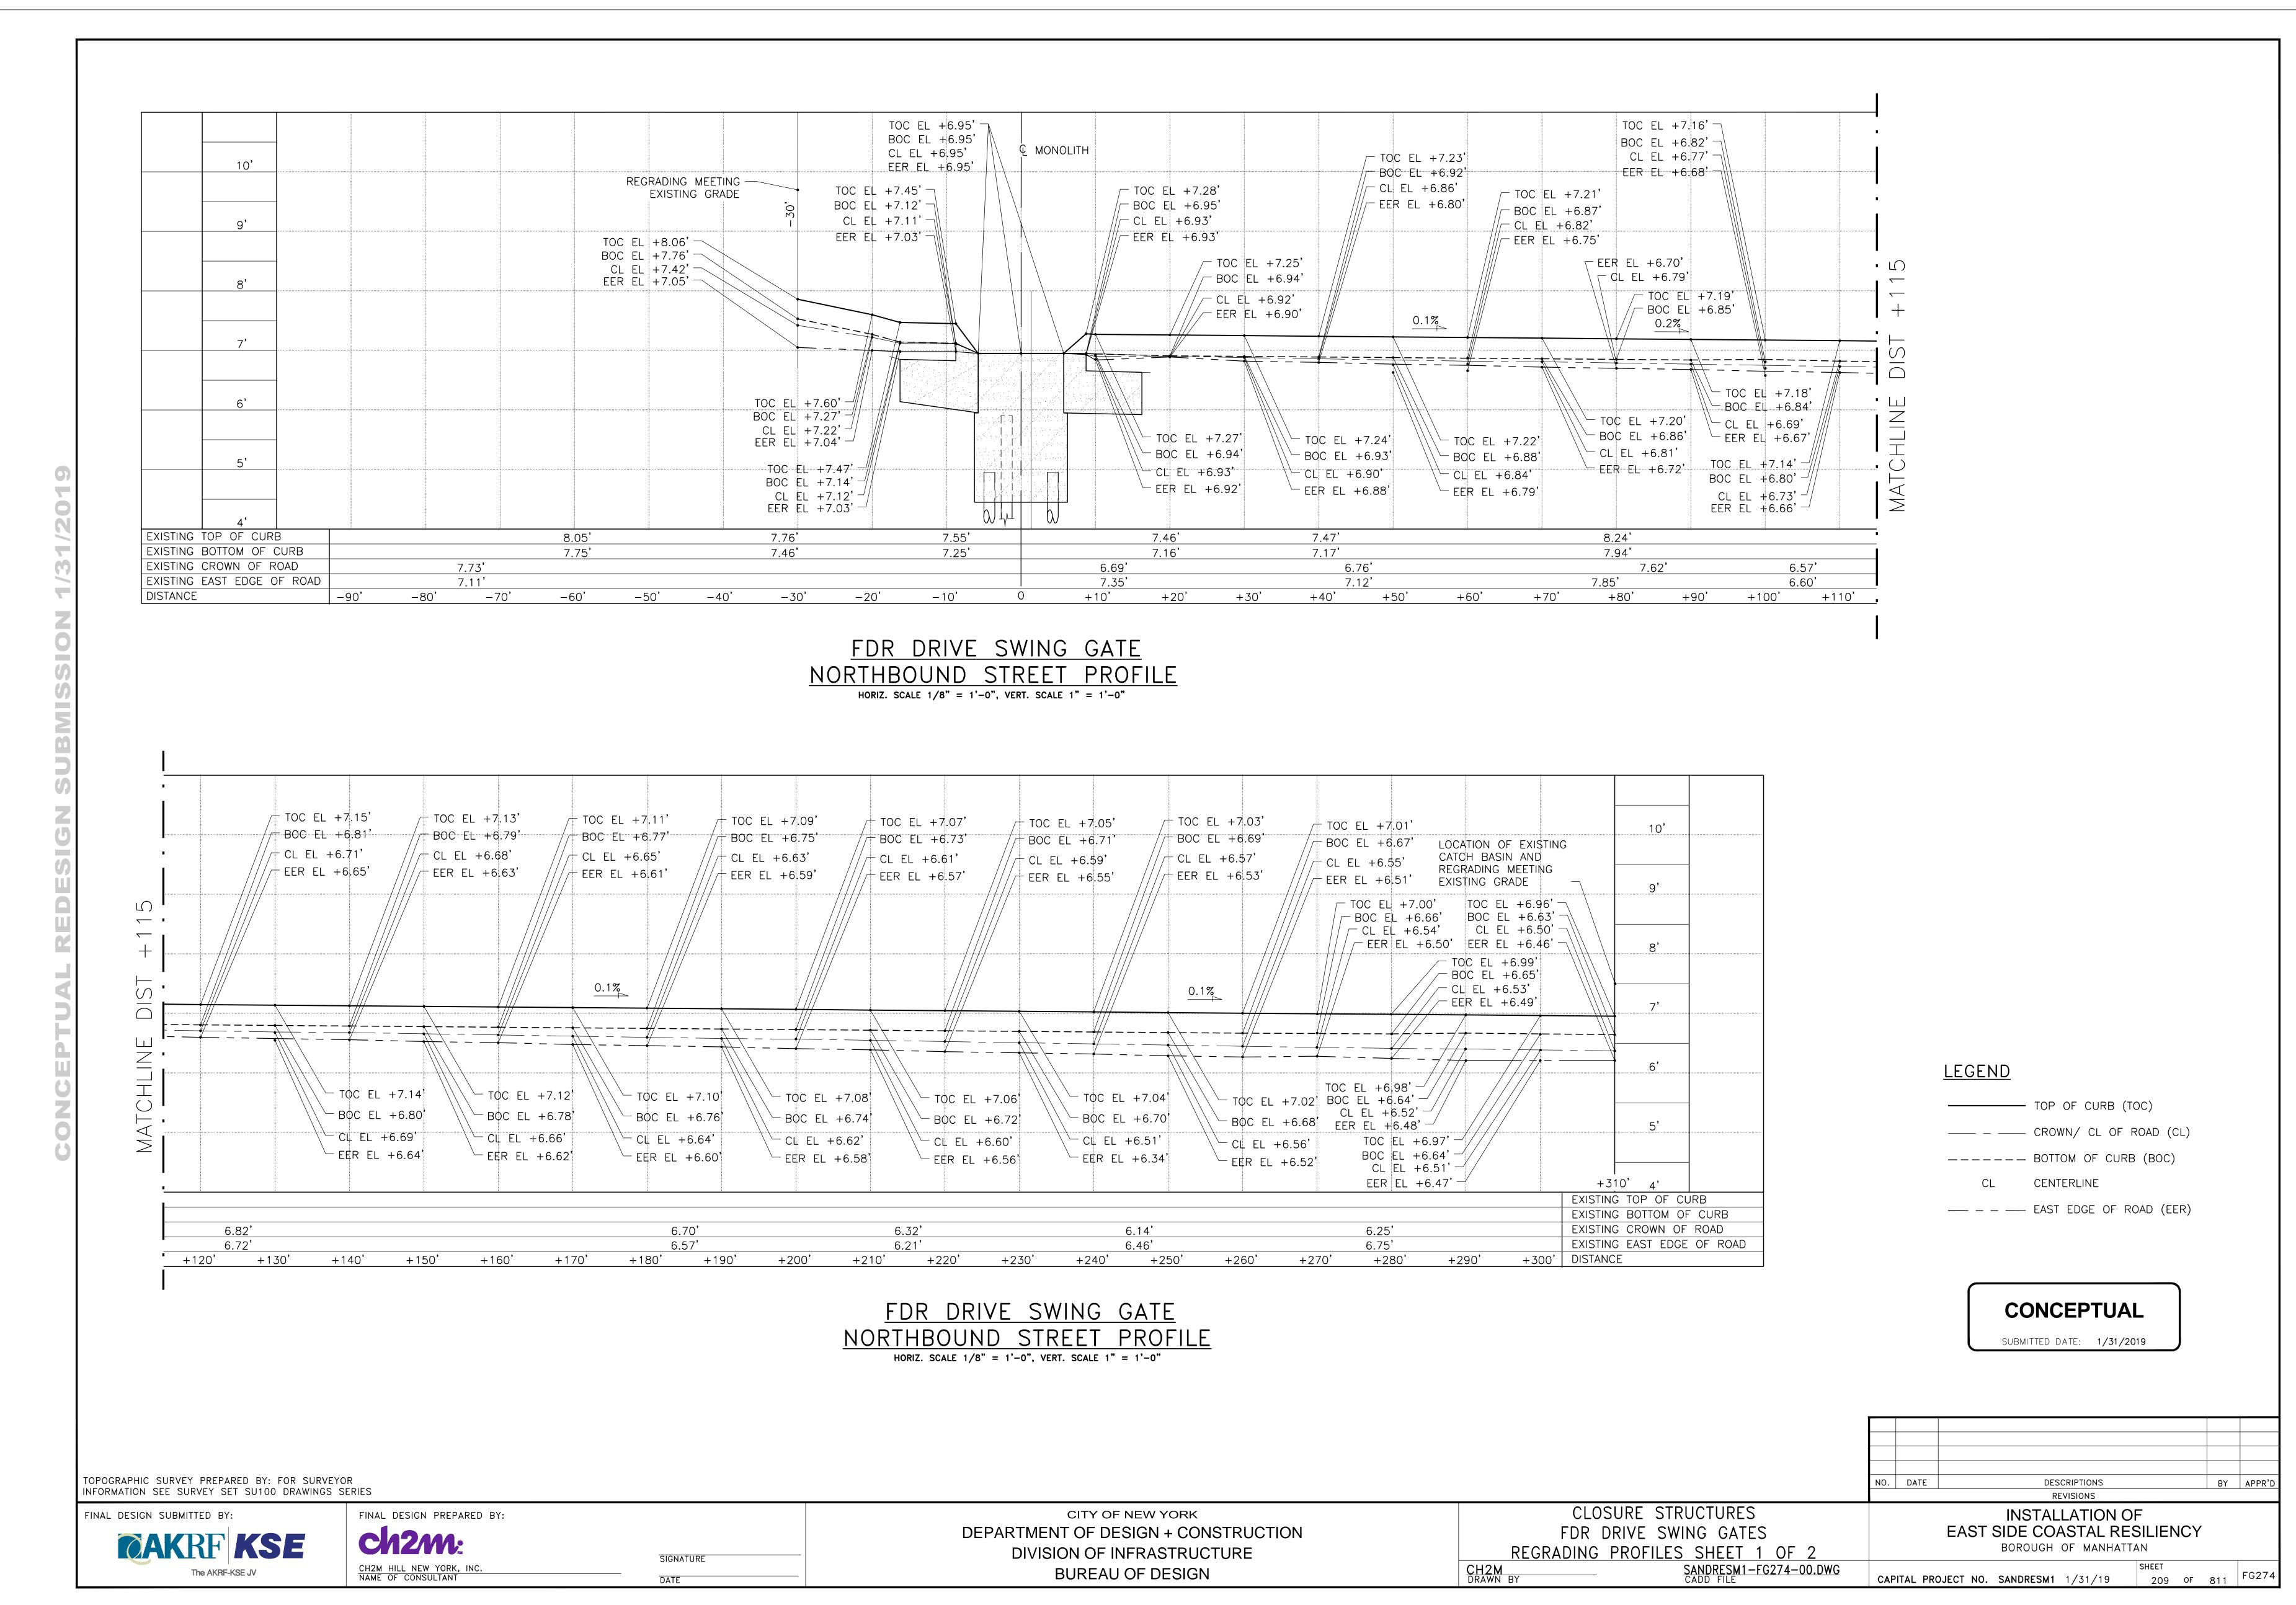

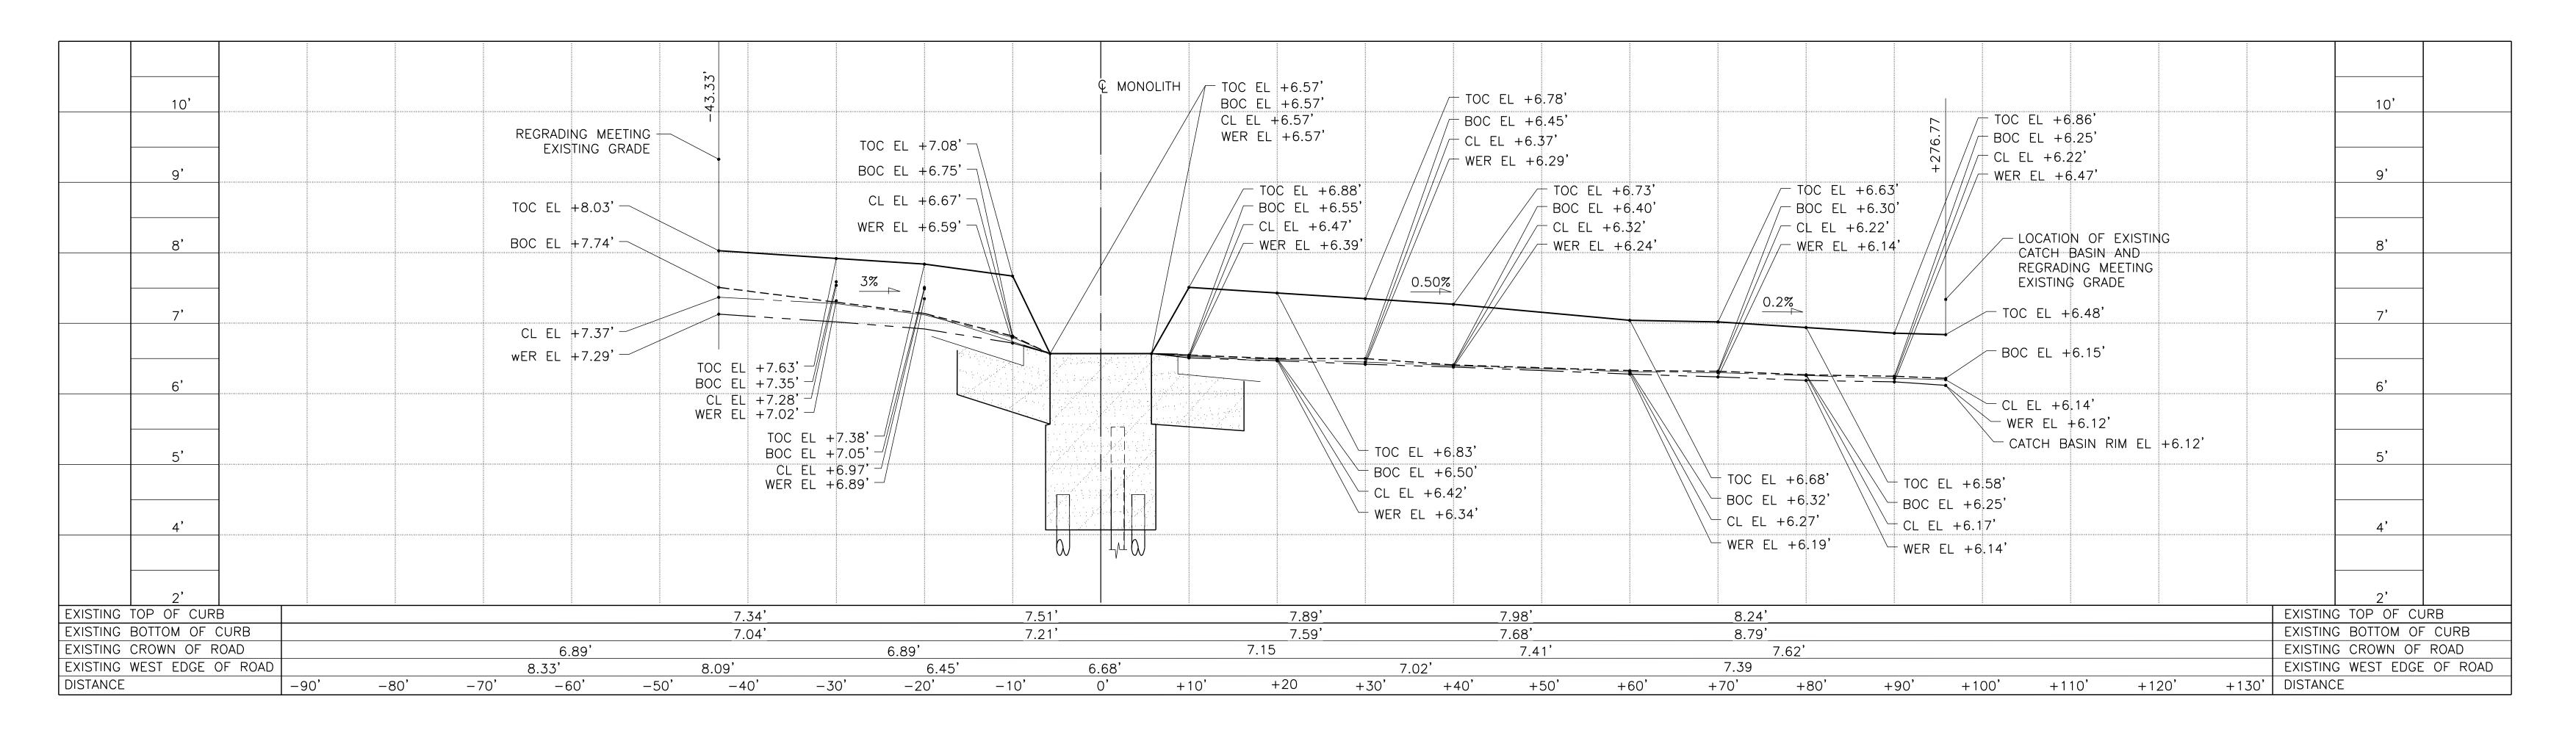

FDR DRIVE SWING GATE

SOUTHBOUND STREET PROFILE

HORIZ. SCALE 1/8" = 1'-0", VERT. SCALE 1" = 1'-0"

<u>LEGEND</u>

TOP OF CURB (TOC)

----- CROWN/ CL OF ROAD (CL)

---- BOTTOM OF CURB (BOC)

CL CENTERLINE

—— — — WEST EDGE OF ROAD (WER)

CONCEPTUAL

SUBMITTED DATE: 1/31/2019

TOPOGRAPHIC SURVEY PREPARED BY: FOR SURVEYOR INFORMATION SEE SURVEY SET SU100 DRAWINGS SERIES

FINAL DESIGN SUBMITTED BY:

The AKRF-KSE JV

FINAL DESIGN PREPARED BY:

C1211.

CH2M HILL NEW YORK, INC.

NAME OF CONSULTANT

SIGNATURE

DATE

CITY OF NEW YORK
DEPARTMENT OF DESIGN + CONSTRUCTION
DIVISION OF INFRASTRUCTURE
BUREAU OF DESIGN

CLOSURE STRUCTURES

FDR DRIVE SWING GATES

REGRADING PROFILES SHEET 2 OF 2

SANDRESM1-FG275-00.DWG
CADD FILE

INSTALLATION OF
EAST SIDE COASTAL RESILIENCY
BOROUGH OF MANHATTAN

DESCRIPTIONS

NO. DATE

BOROUGH OF MANHATTAN


CAPITAL PROJECT NO. SANDRESM1 1/31/19


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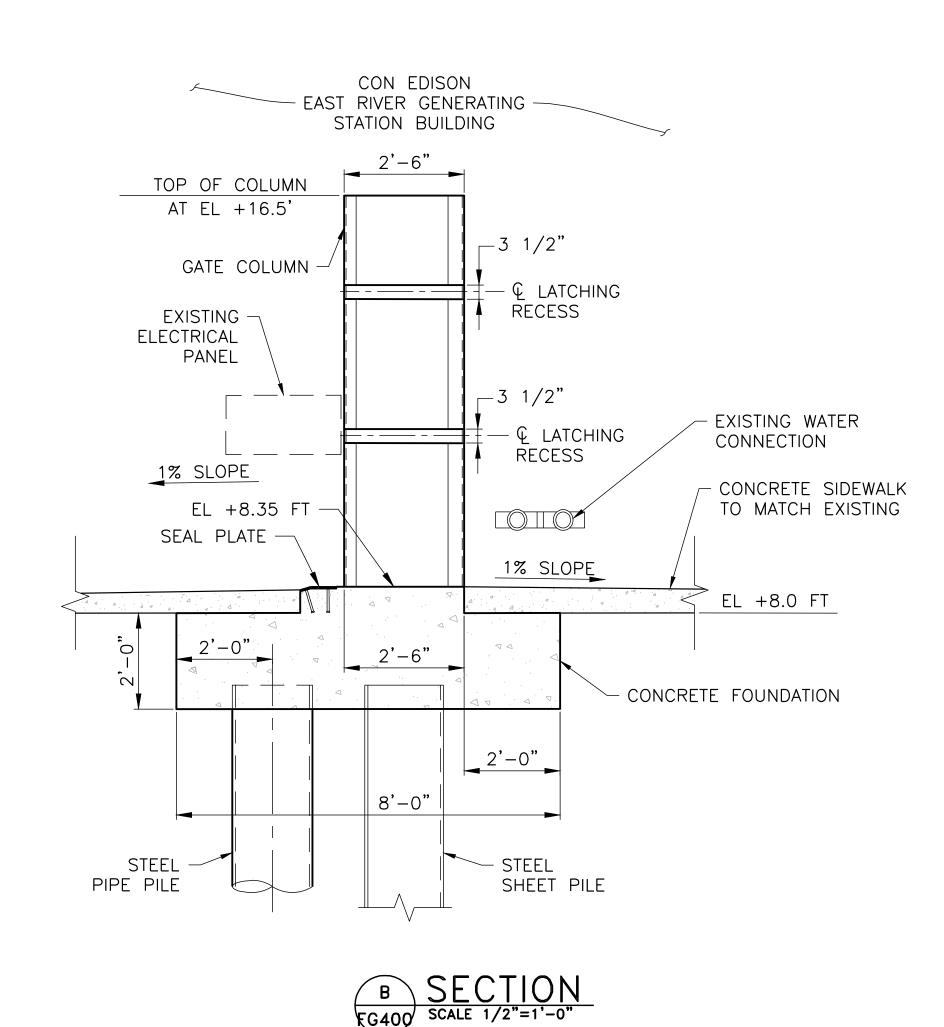
210 OF 811


FG275

BY APPR'C



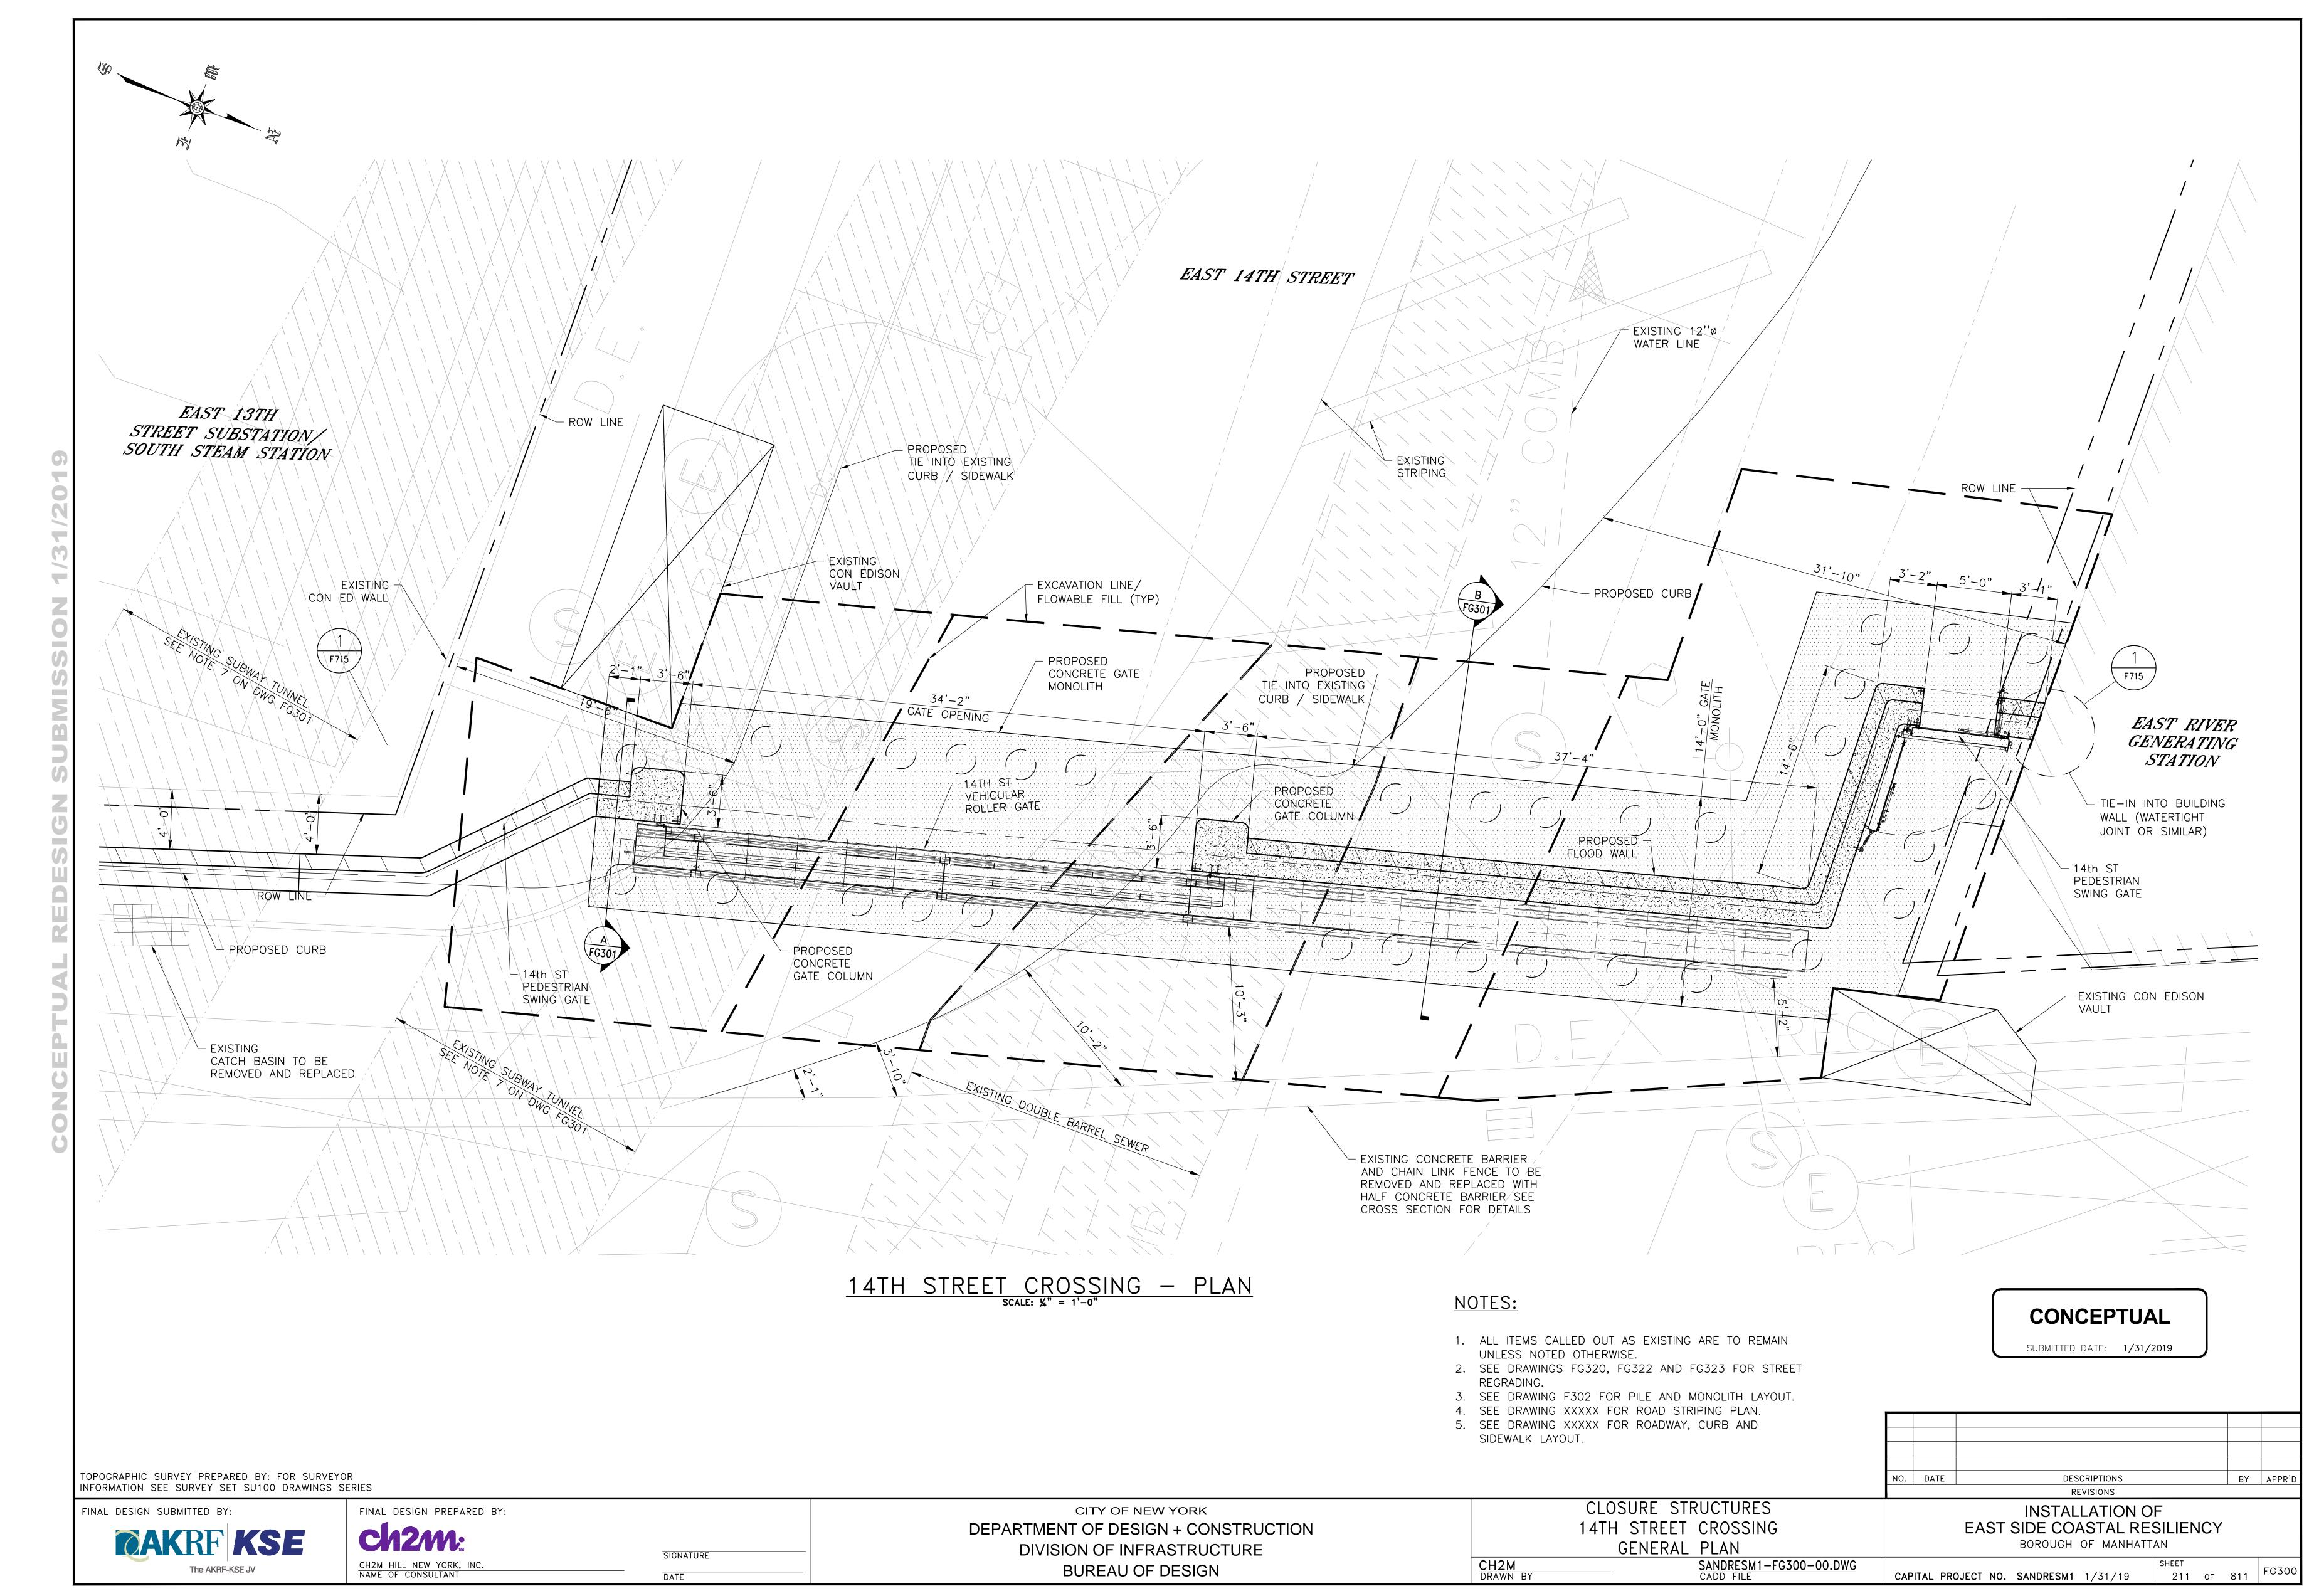

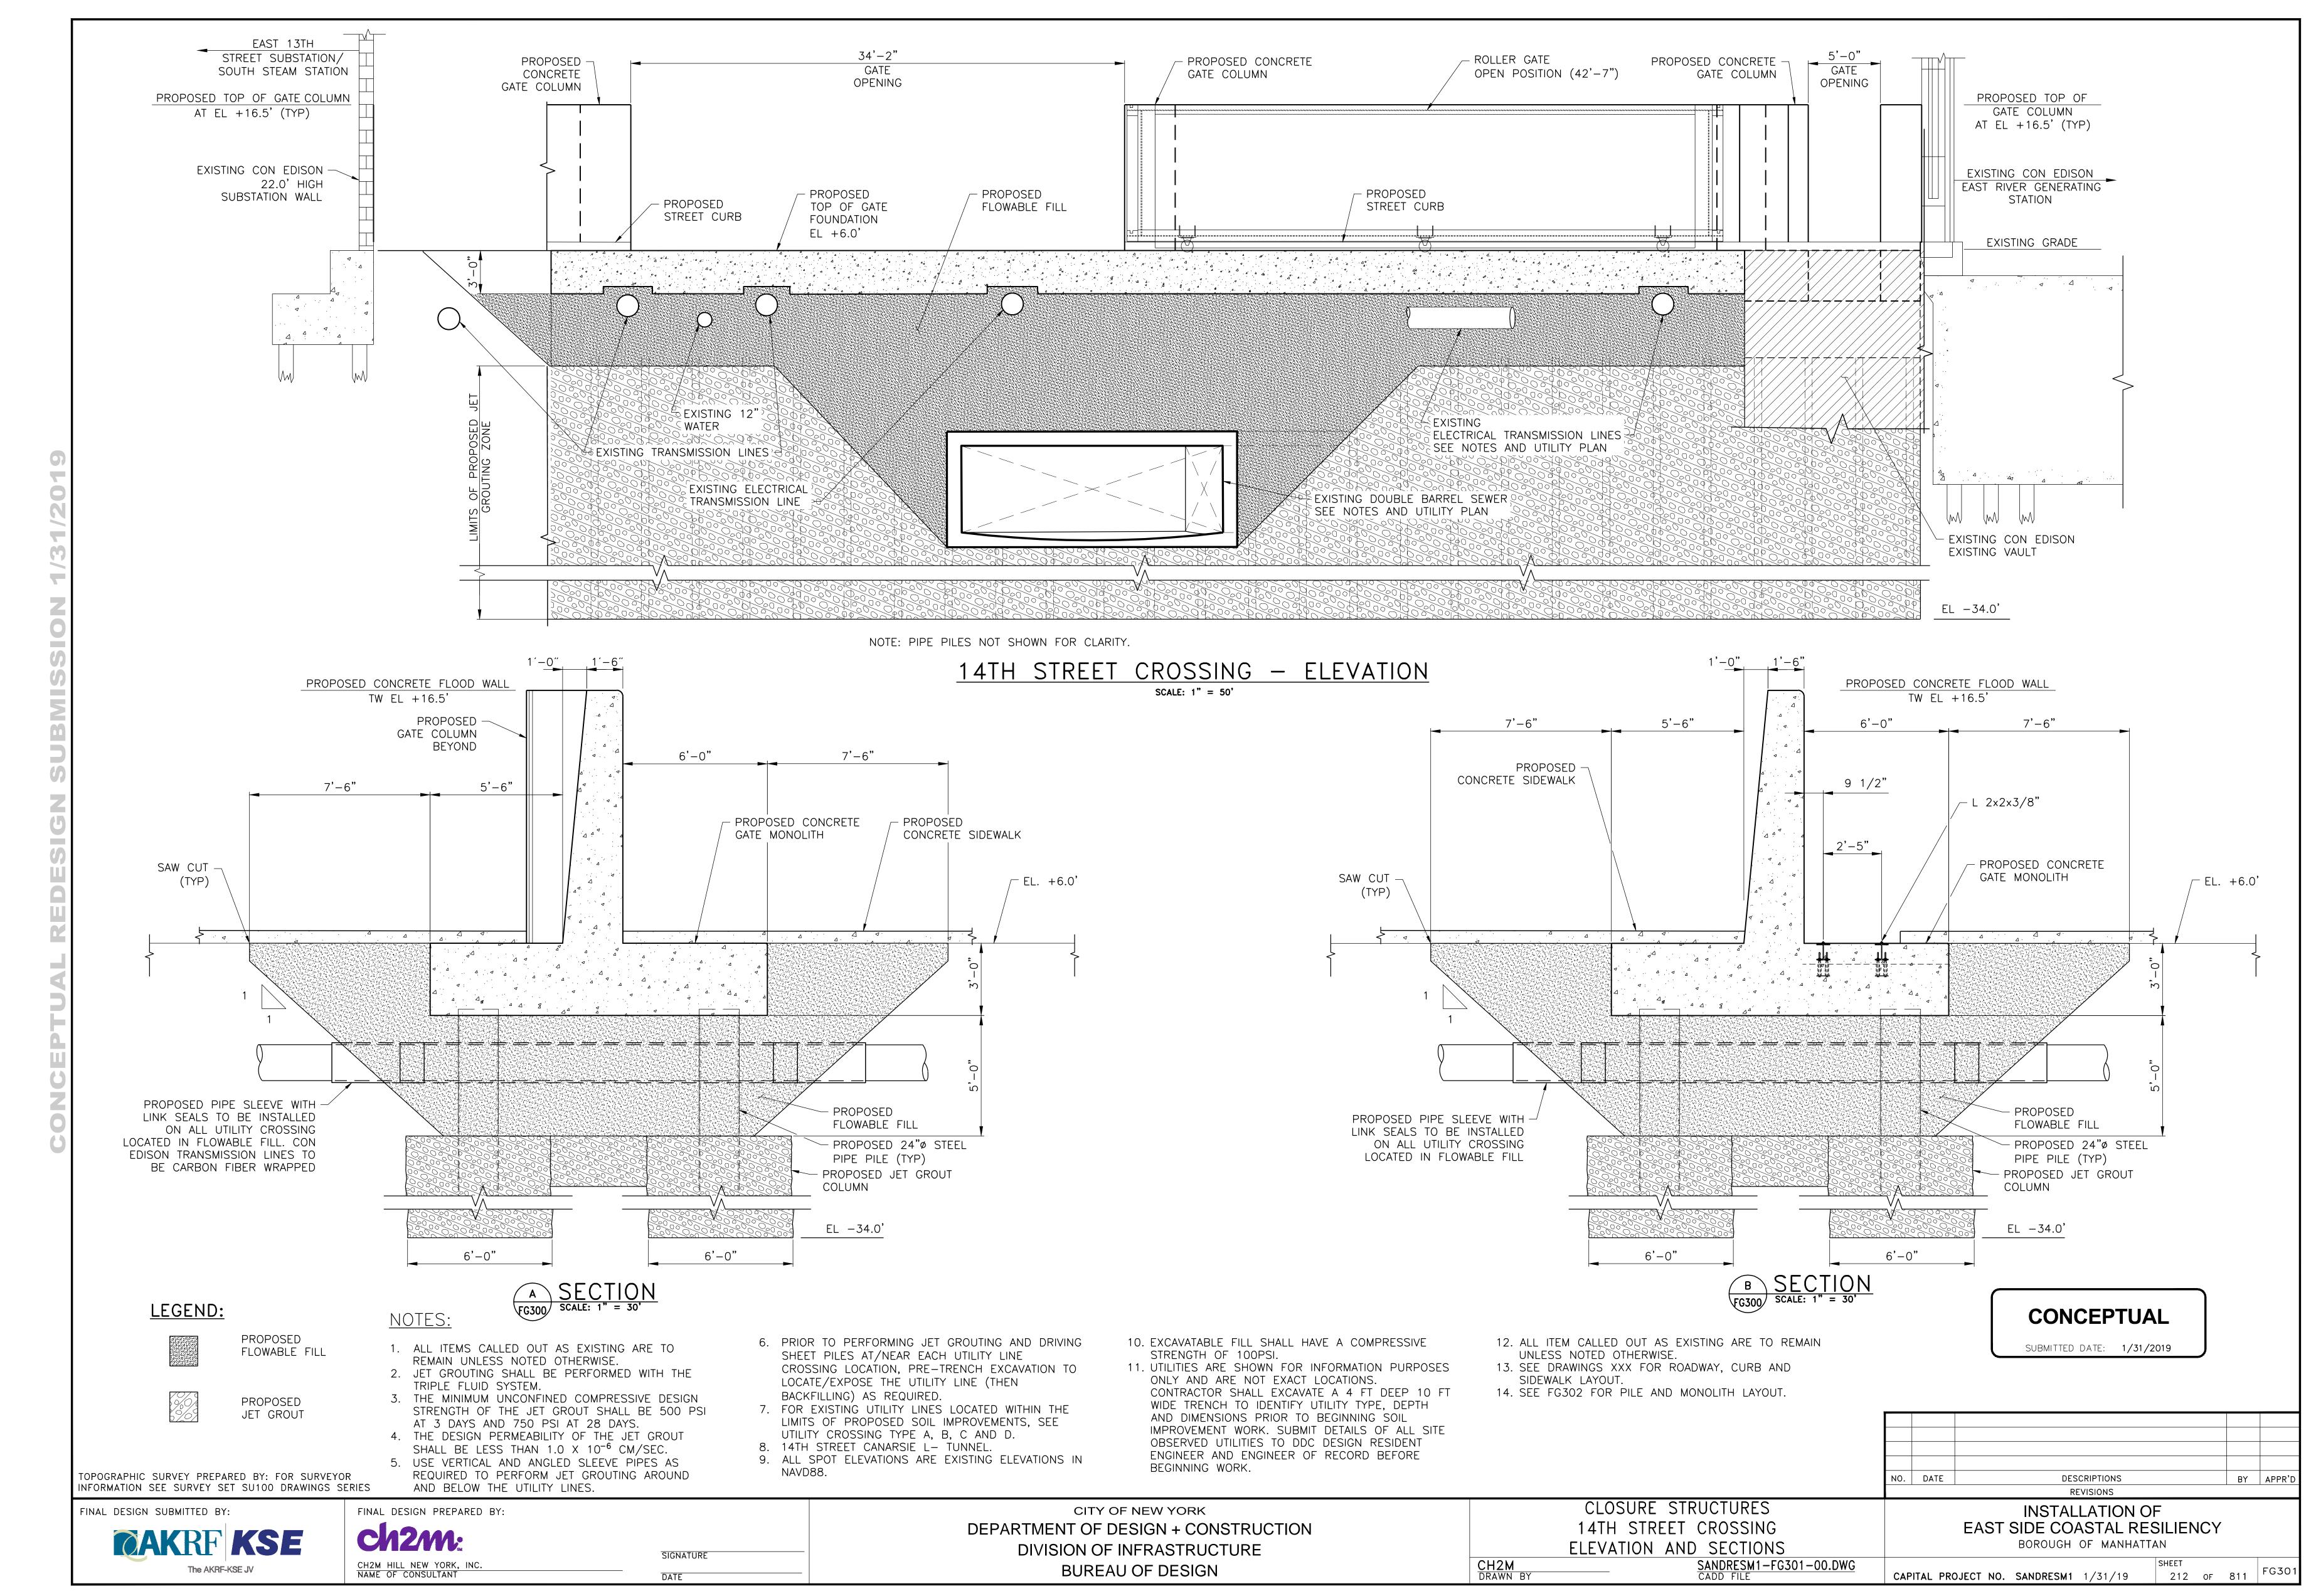

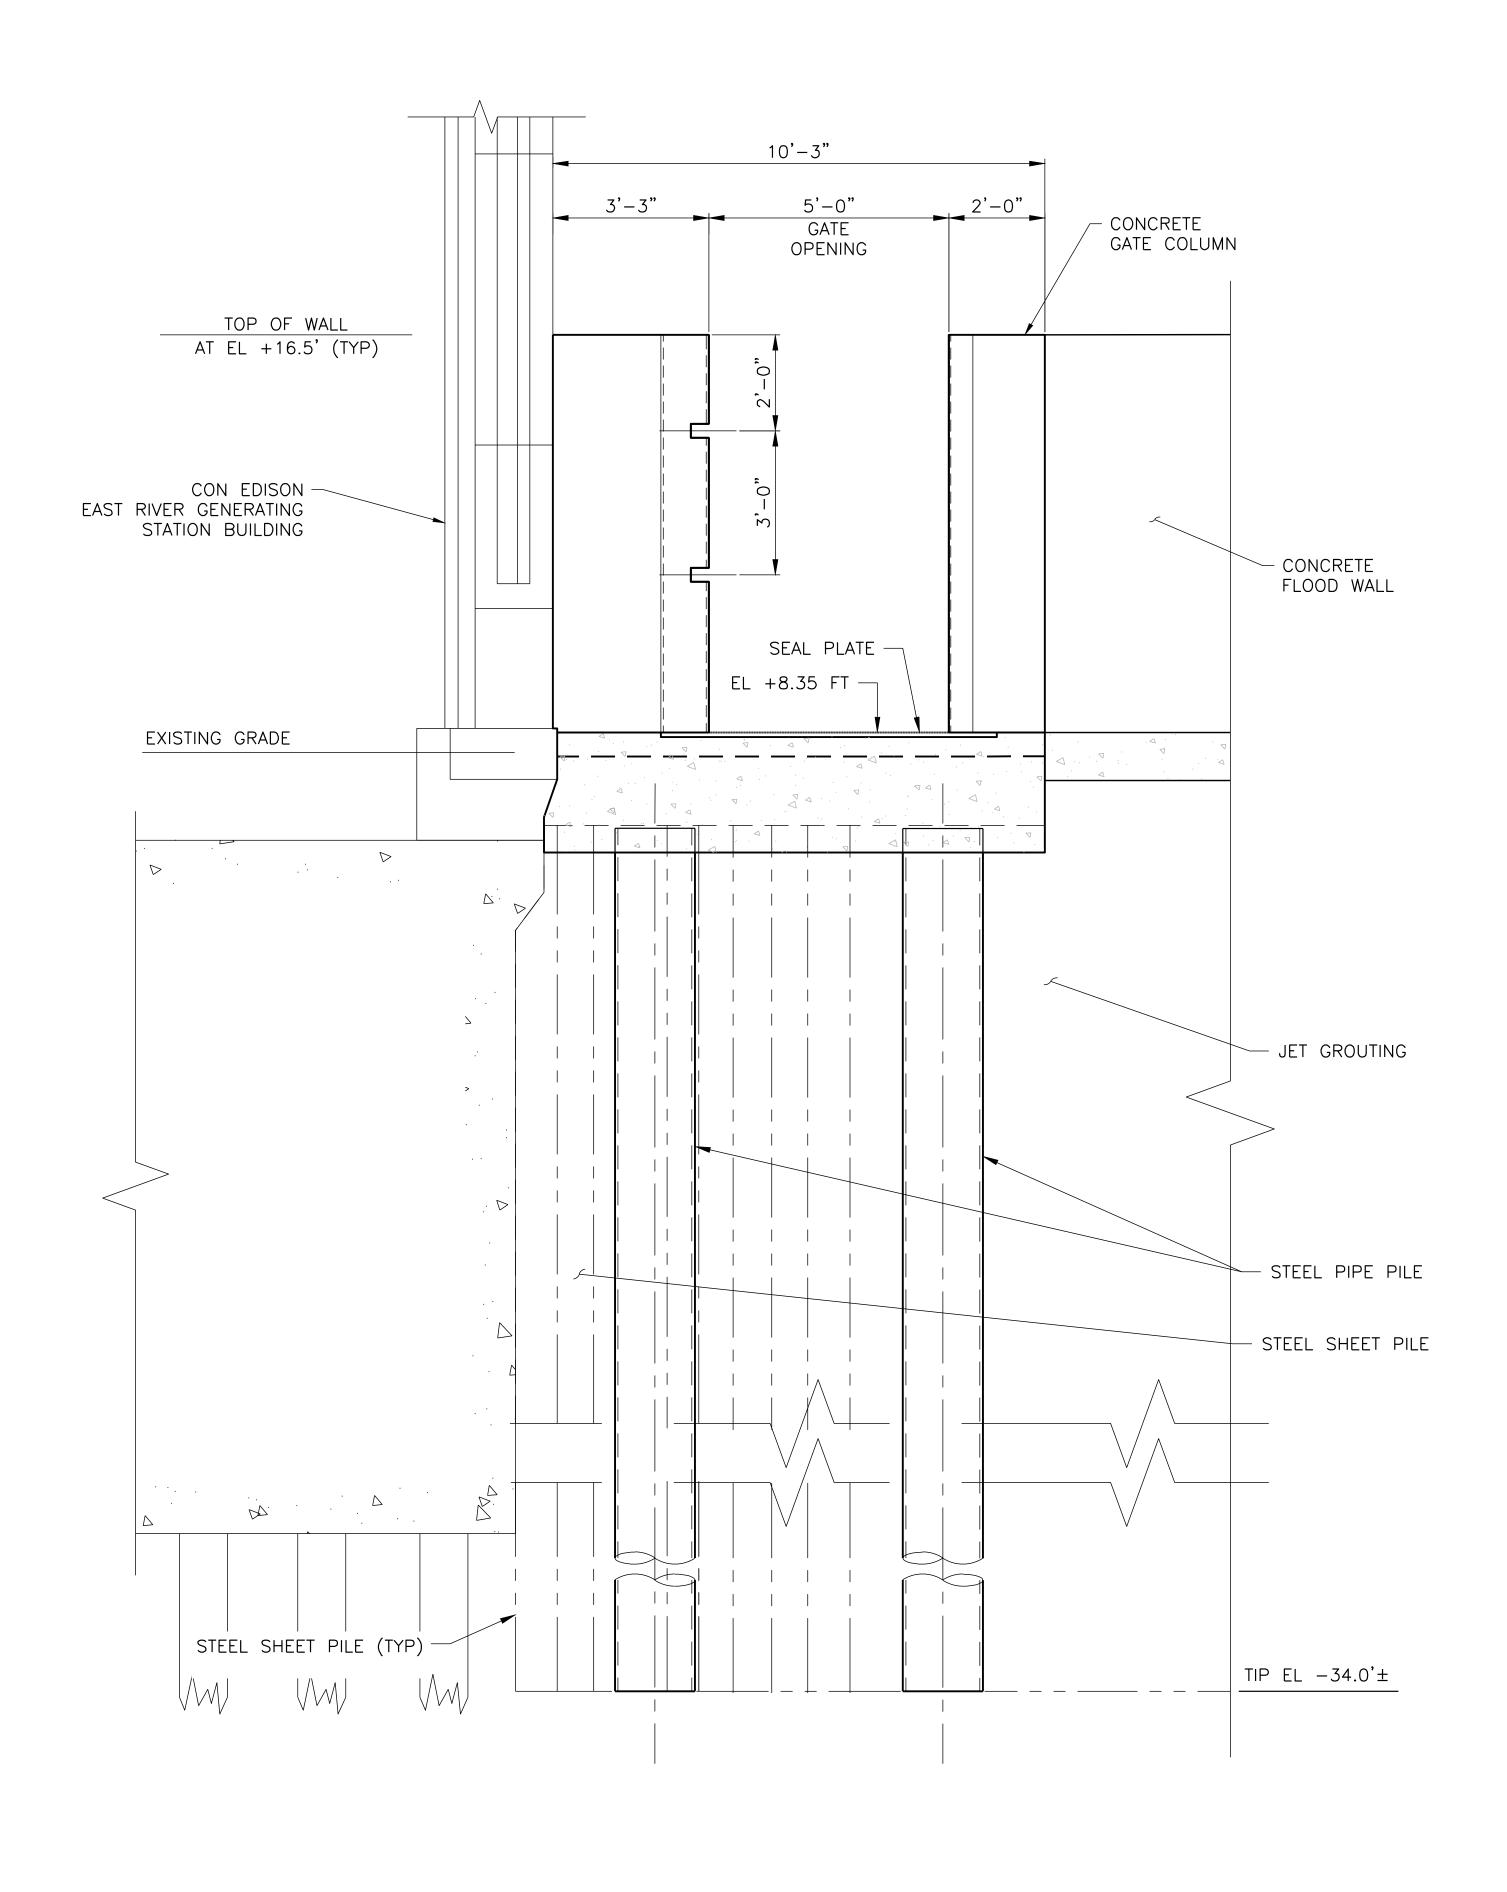

A SECTION SCALE 1/2"=1'-0

CONCEPTUAL

SUBMITTED DATE: 1/31/2019

NOTES:

 ALL ITEMS CALLED OUT AS EXISTING ARE TO REMAIN UNLESS NOTED OTHERWISE.

TOPOGRAPHIC SURVEY PREPARED BY: FOR SURVEYOR INFORMATION SEE SURVEY SET SU100 DRAWINGS SERIES

FINAL DESIGN SUBMITTED BY:

CAKRF KSE

The AKRF-KSE JV

FINAL DESIGN PREPARED BY:

C12111:
CH2M HILL NEW YORK, INC.
NAME OF CONSULTANT

SIGNATURE

CITY OF NEW YORK
DEPARTMENT OF DESIGN + CONSTRUCTION
DIVISION OF INFRASTRUCTURE
BUREAU OF DESIGN

CLOSURE STRUCTURES

15TH STREET PEDESTRIAN SWING GATE

SECTIONS

CH2M
DRAWN BY


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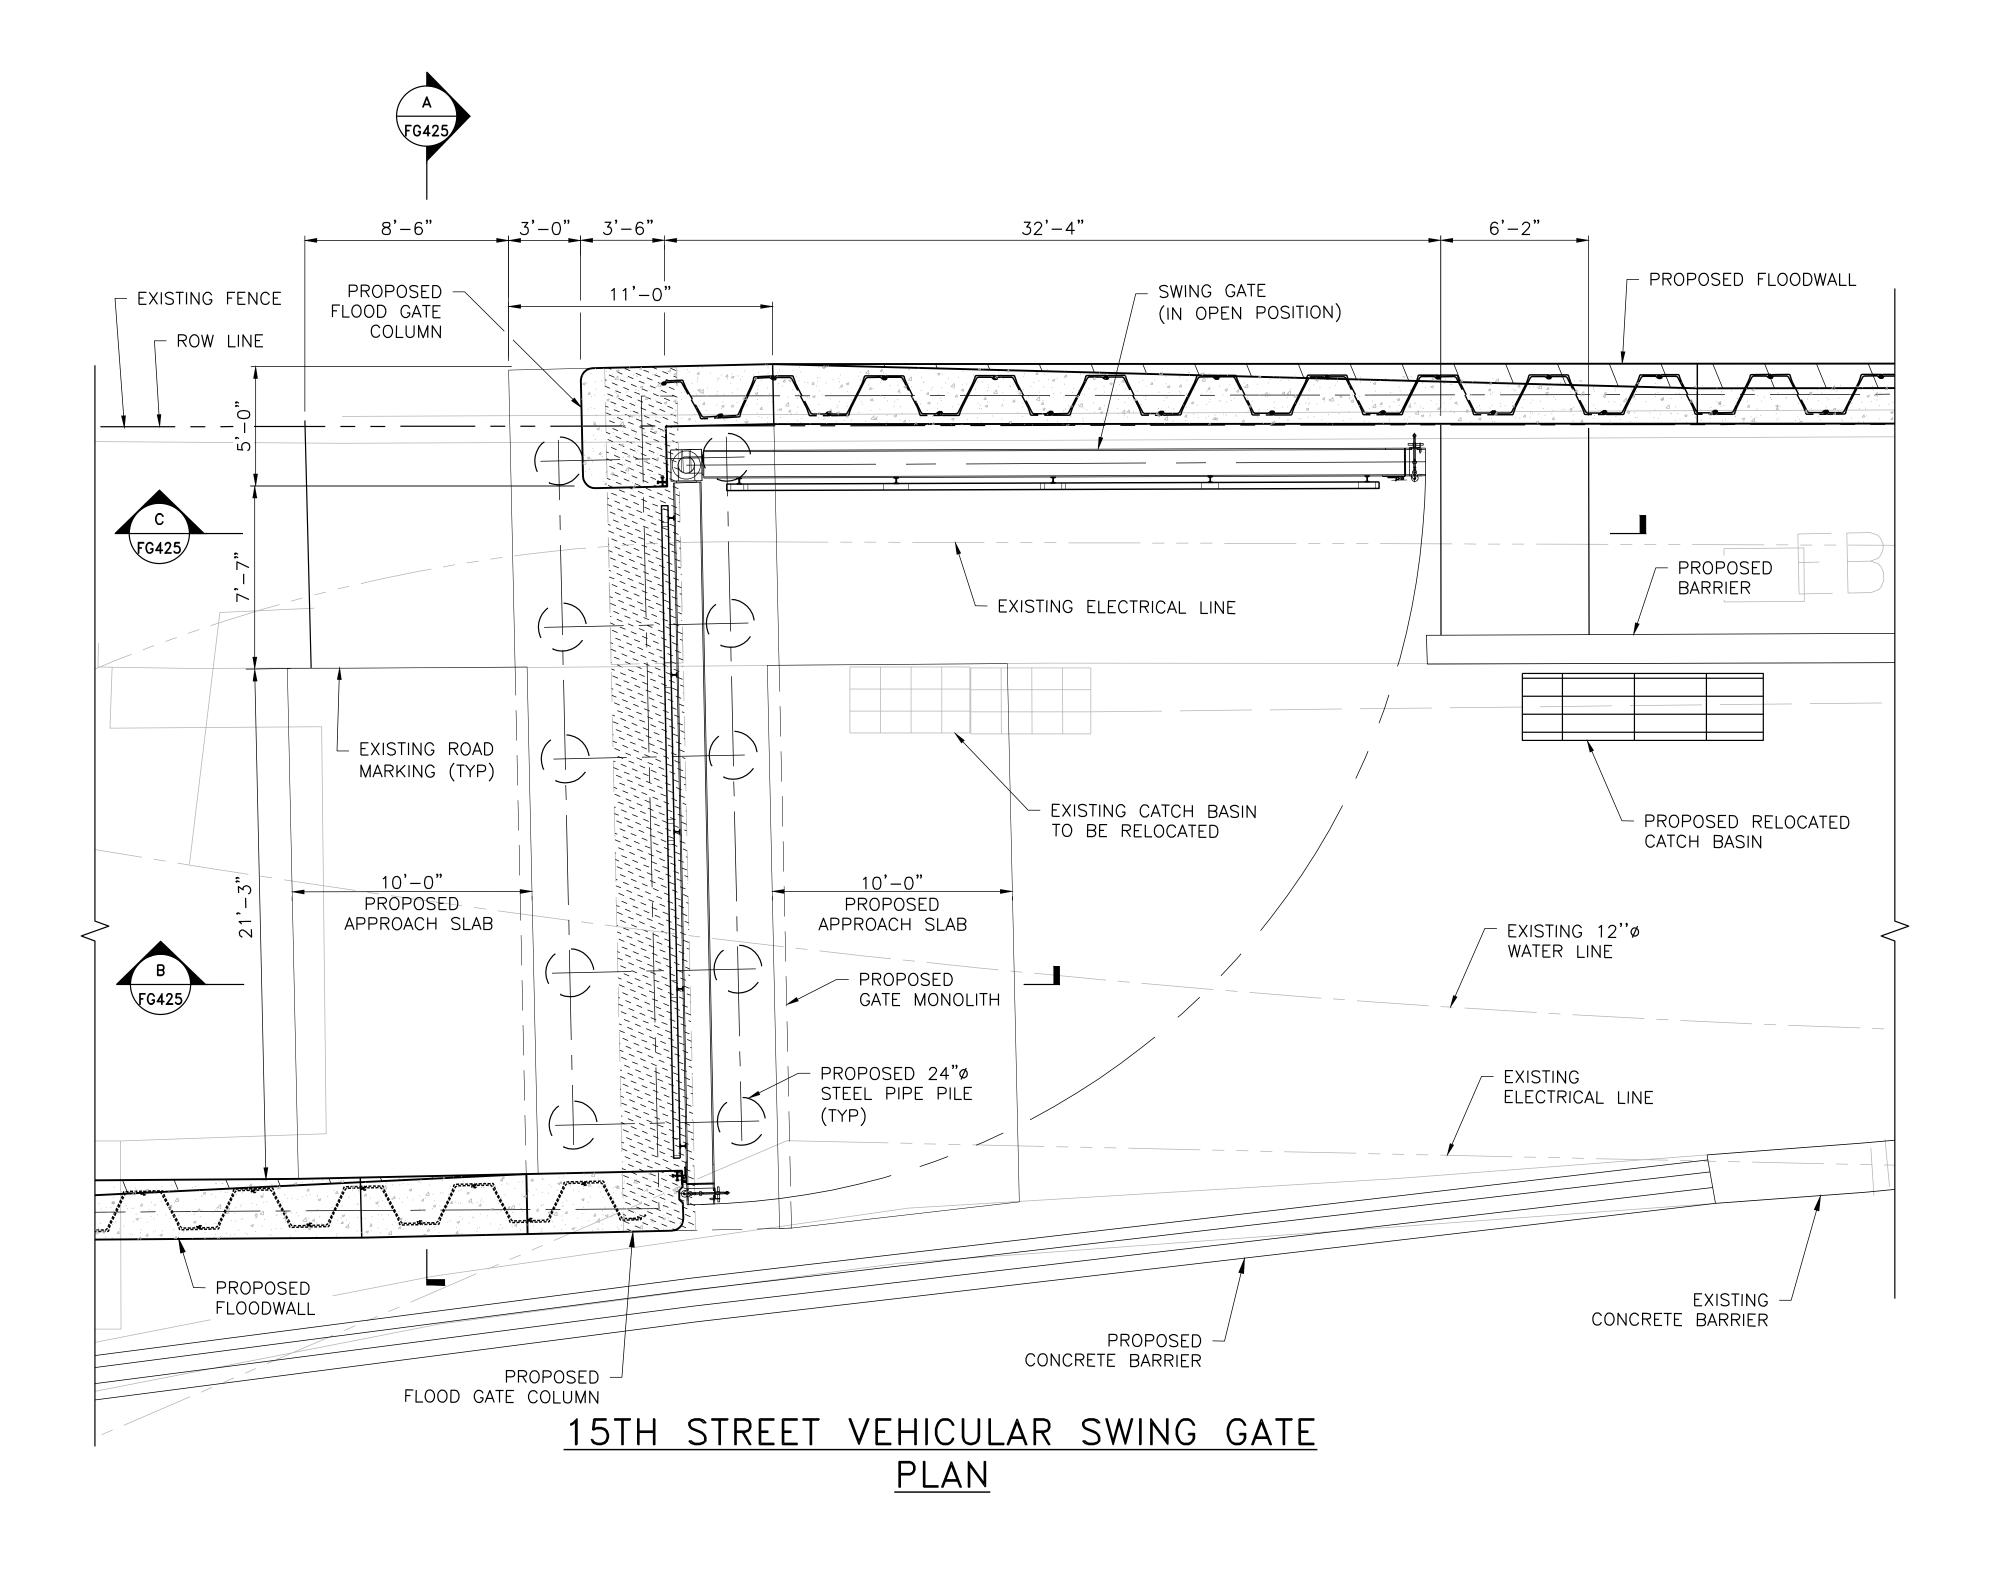
NO. DATE DESCRIPTIONS

REVISIONS

INSTALLATION OF
EAST SIDE COASTAL RESILIENCY
BOROUGH OF MANHATTAN

CAPITAL PROJECT NO. SANDRESM1 1/31/19 222 OF 811 FG401



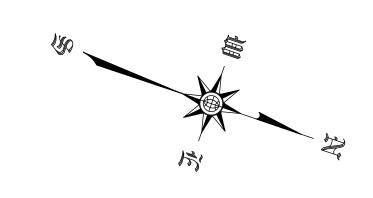

SCALE: $\frac{1}{4}$ " = 1'-0"

LEGEND:

SIGNATURE

DATE



PROPOSED JET GROUTING ZONE

NOTES:

- ALL ITEMS CALLED OUT AS EXISTING ARE TO REMAIN UNLESS NOTED OTHERWISE.
 SEE DRAWINGS FG440, FG442, FG443, FG444, FG445, FG446, FG447, FG448 AND FG449 FOR STREET
- 3. SEE DRAWING FG426 FOR PILE AND MONOLITH LAYOUT.
- SEE DRAWING XXXXXX FOR ROAD STRIPING PLAN.
 SEE DRAWINGS XXXXXX FOR ROADWAY, CURB AND SIDEWALK LAYOUT.

CONCEPTUAL

SUBMITTED DATE: 1/31/2019

NO. DATE DESCRIPTIONS BY APPR'D REVISIONS **INSTALLATION OF**

TOPOGRAPHIC SURVEY PREPARED BY: FOR SURVEYOR INFORMATION SEE SURVEY SET SU100 DRAWINGS SERIES





FINAL DESIGN PREPARED BY: CH2M HILL NEW YORK, INC.
NAME OF CONSULTANT

CITY OF NEW YORK DEPARTMENT OF DESIGN + CONSTRUCTION DIVISION OF INFRASTRUCTURE **BUREAU OF DESIGN**


CLOSURE STRUCTURES 15TH STREET VEHICULAR SWING GATE GENERAL PLAN SANDRESM1-FG420-00.DWG CH2M DRAWN BY

EAST SIDE COASTAL RESILIENCY BOROUGH OF MANHATTAN CAPITAL PROJECT NO. SANDRESM1 1/31/19 223 OF 811 FG420

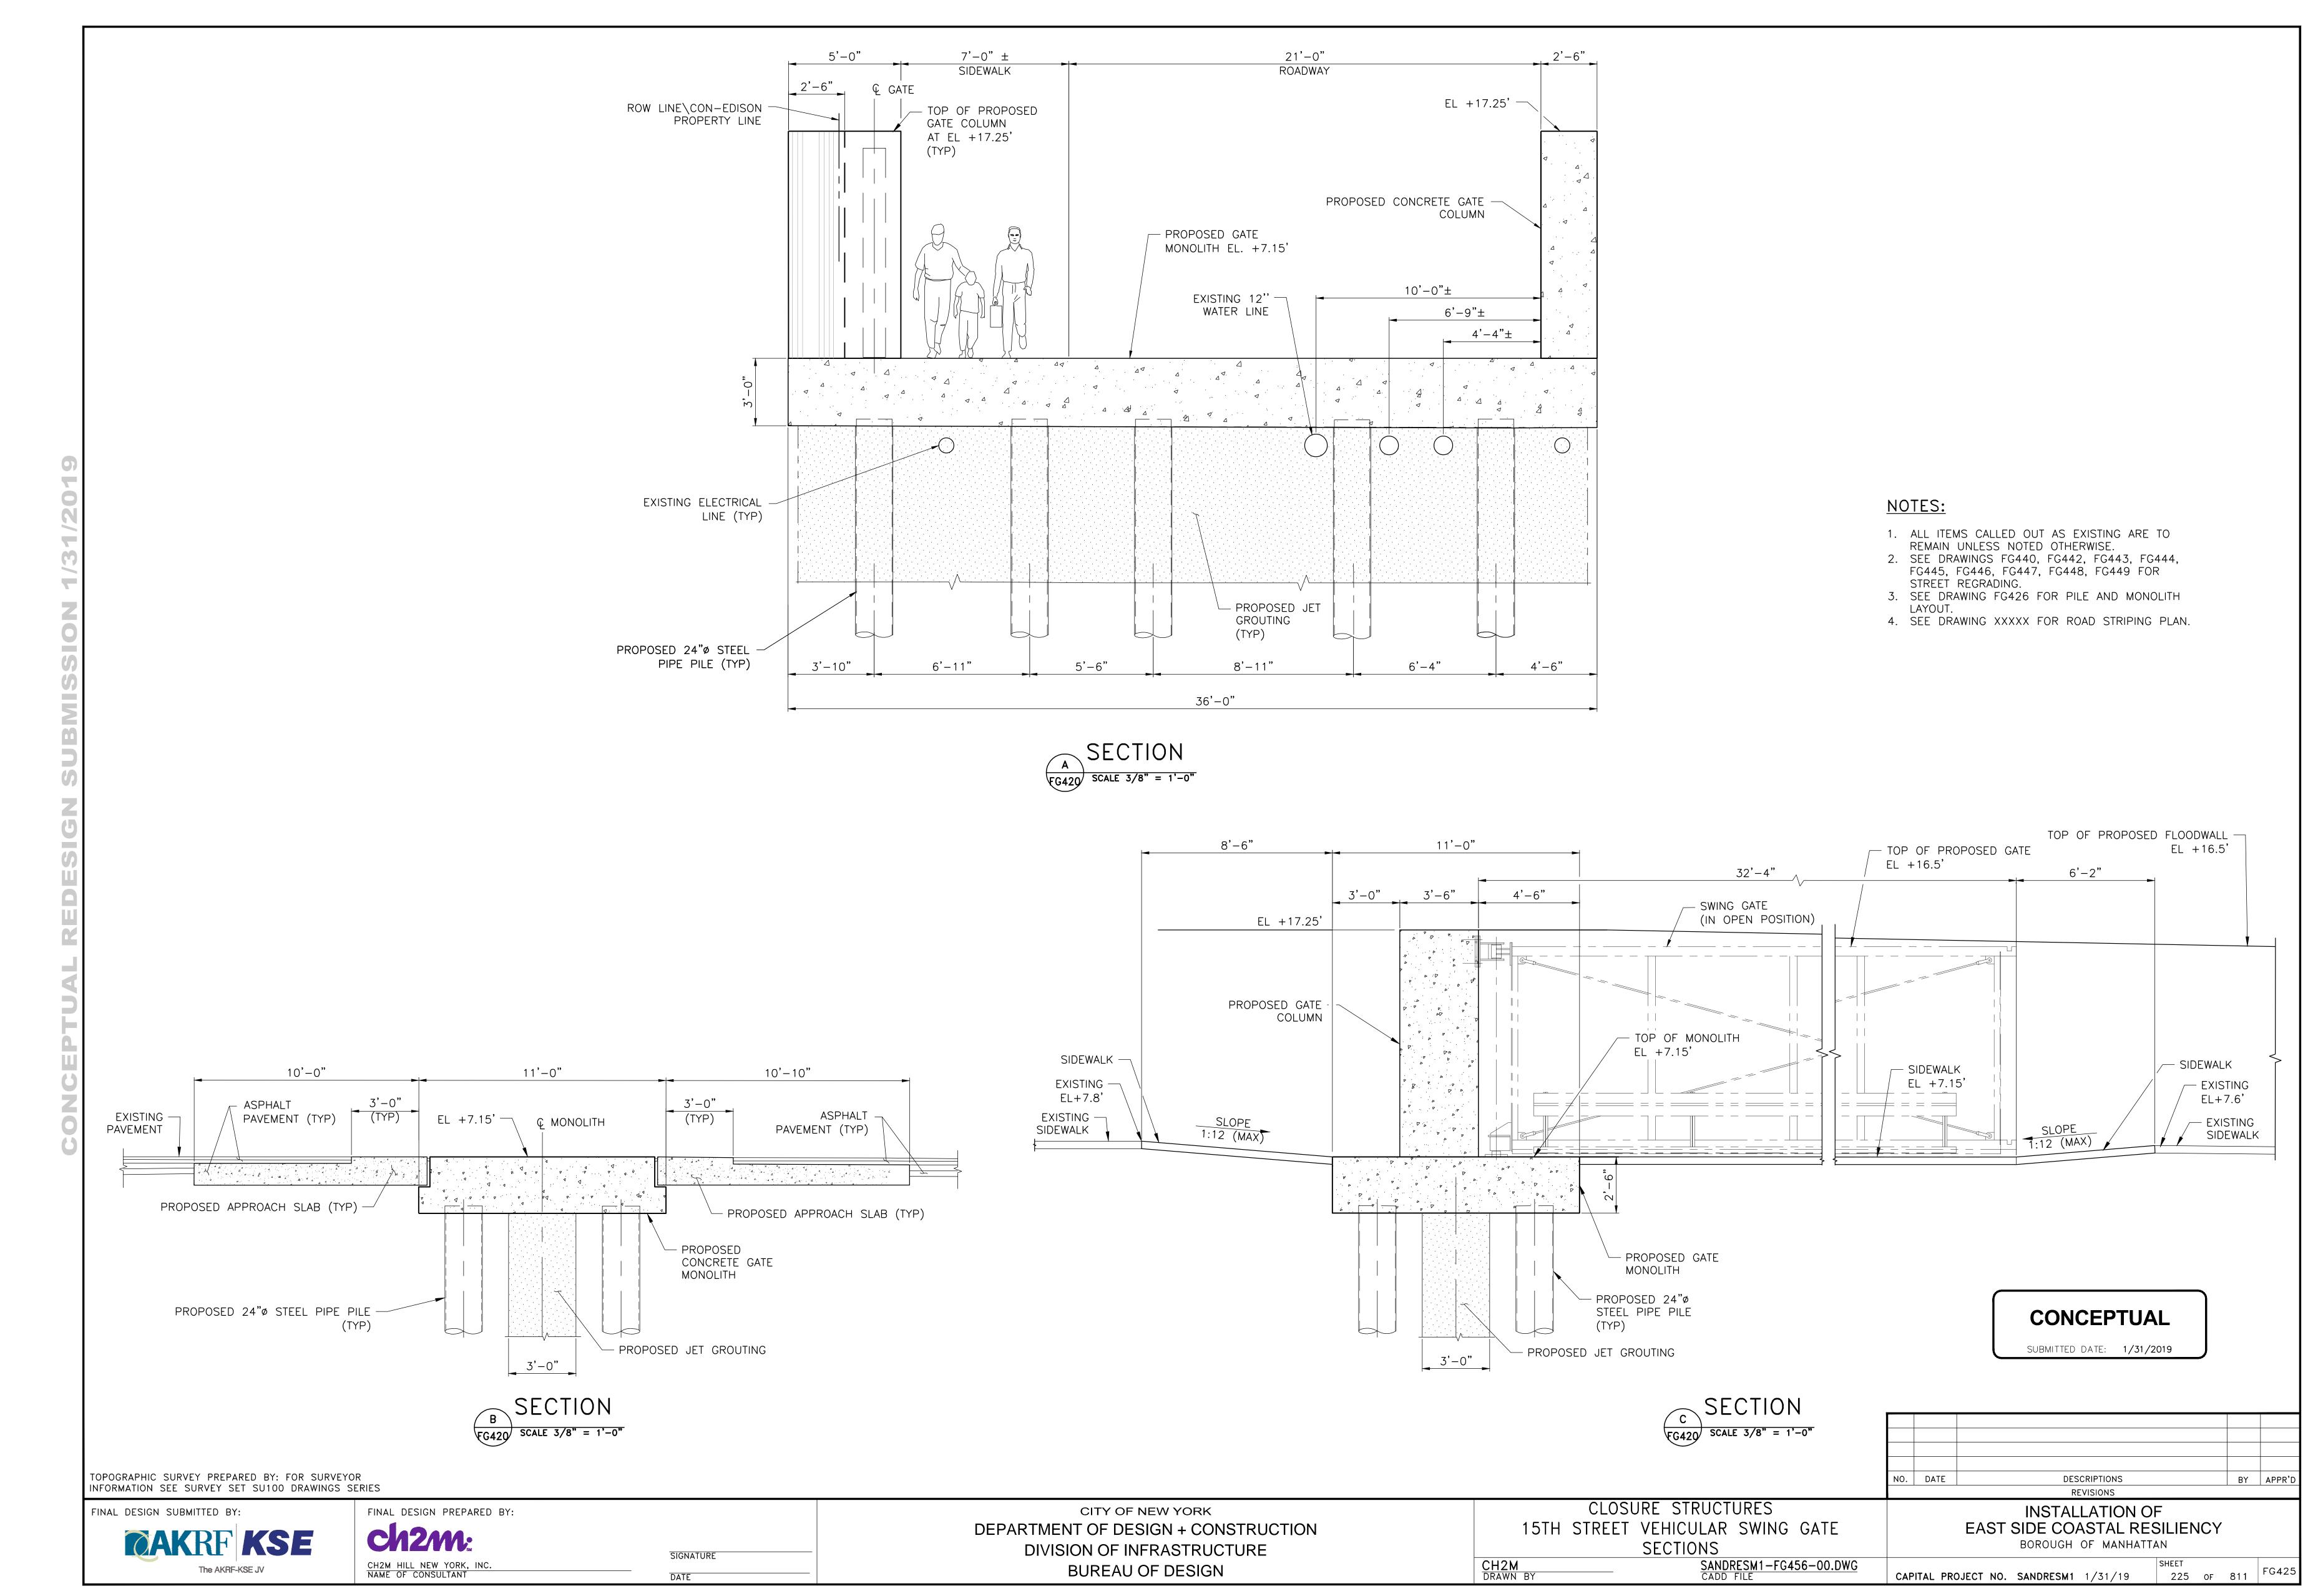


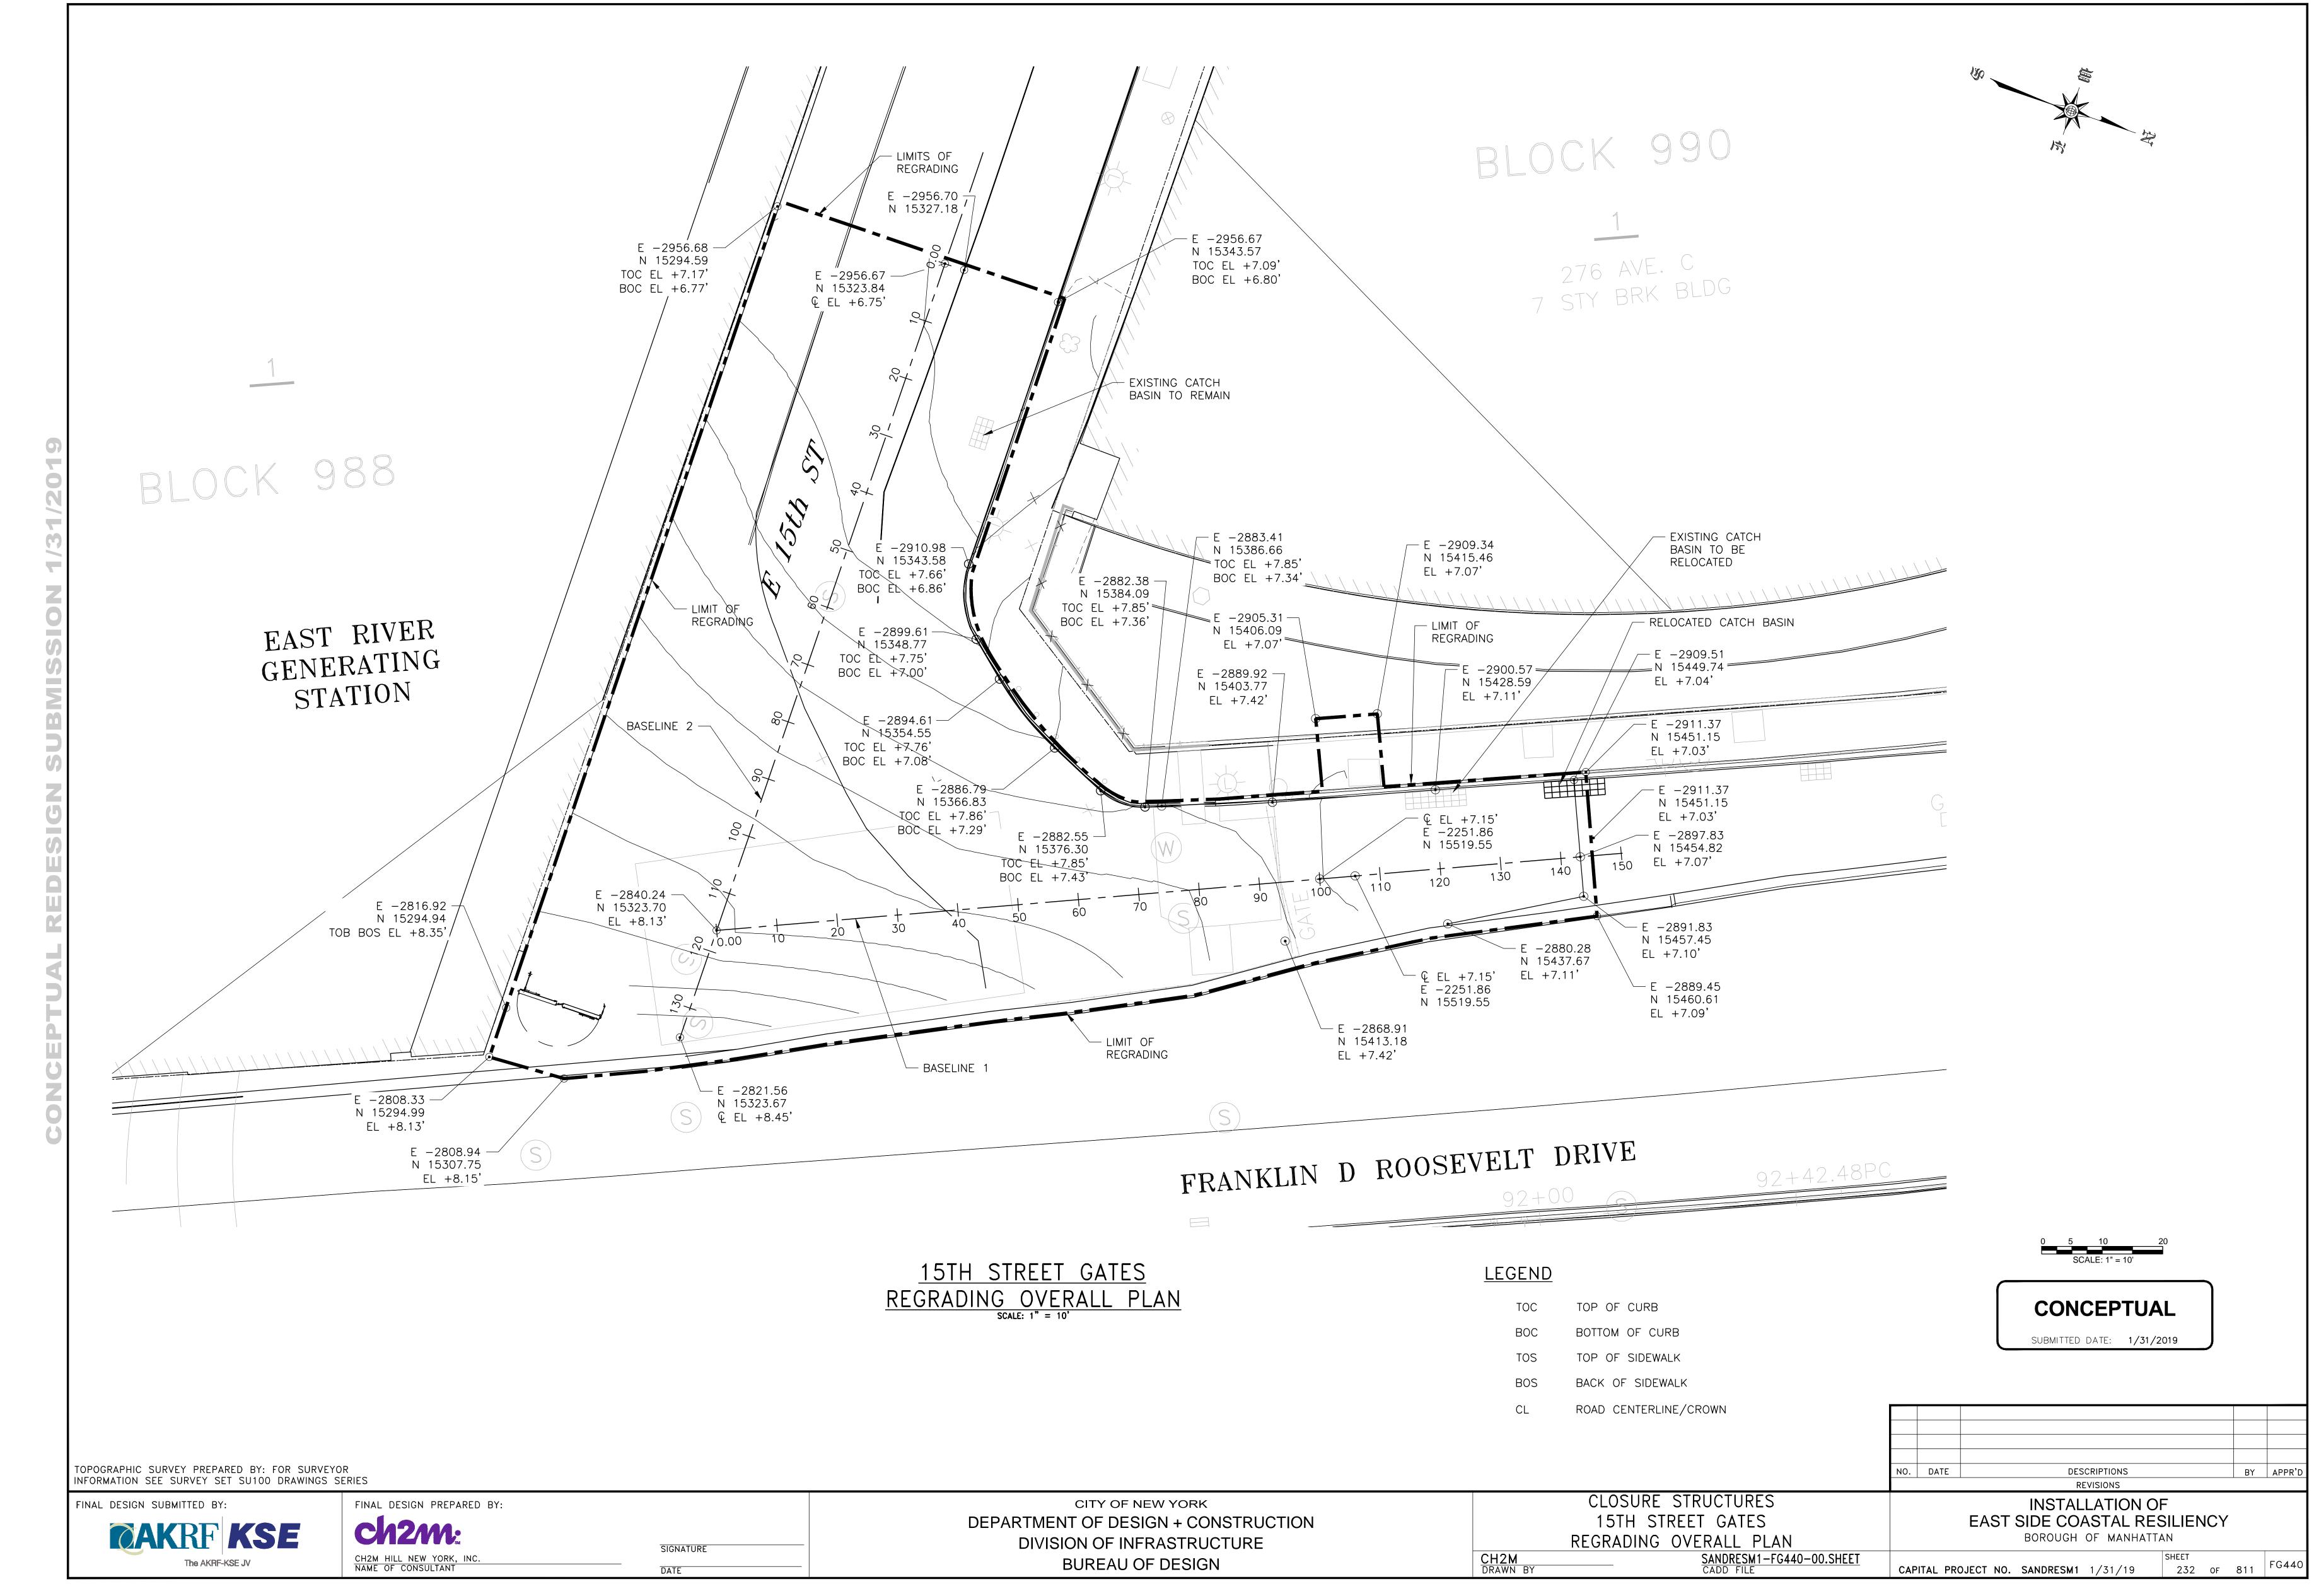



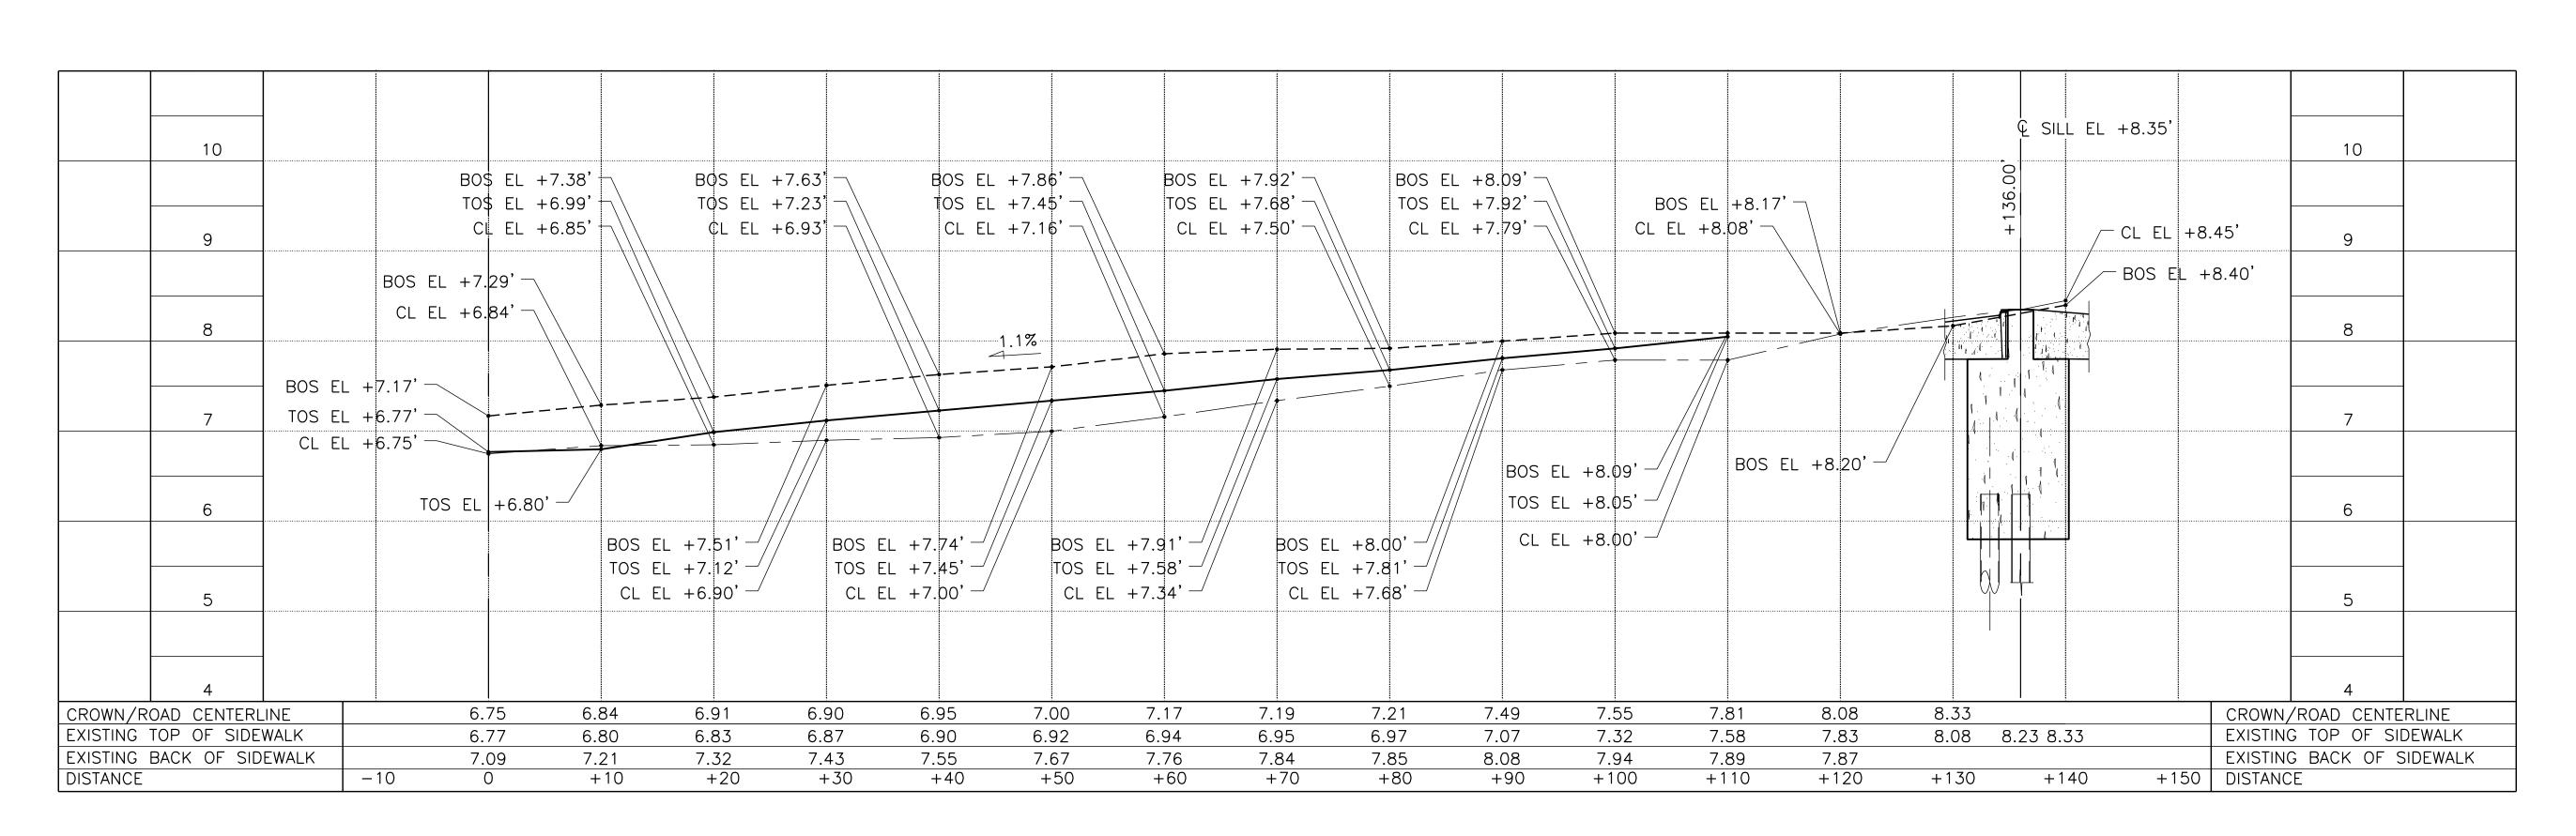

PROFILE ALONG 15TH STREET- SOUTH SIDE (BASELINE 2) HORIZ. SCALE 1/8" = 1'-0", VERT. SCALE 1" = 1'-0"

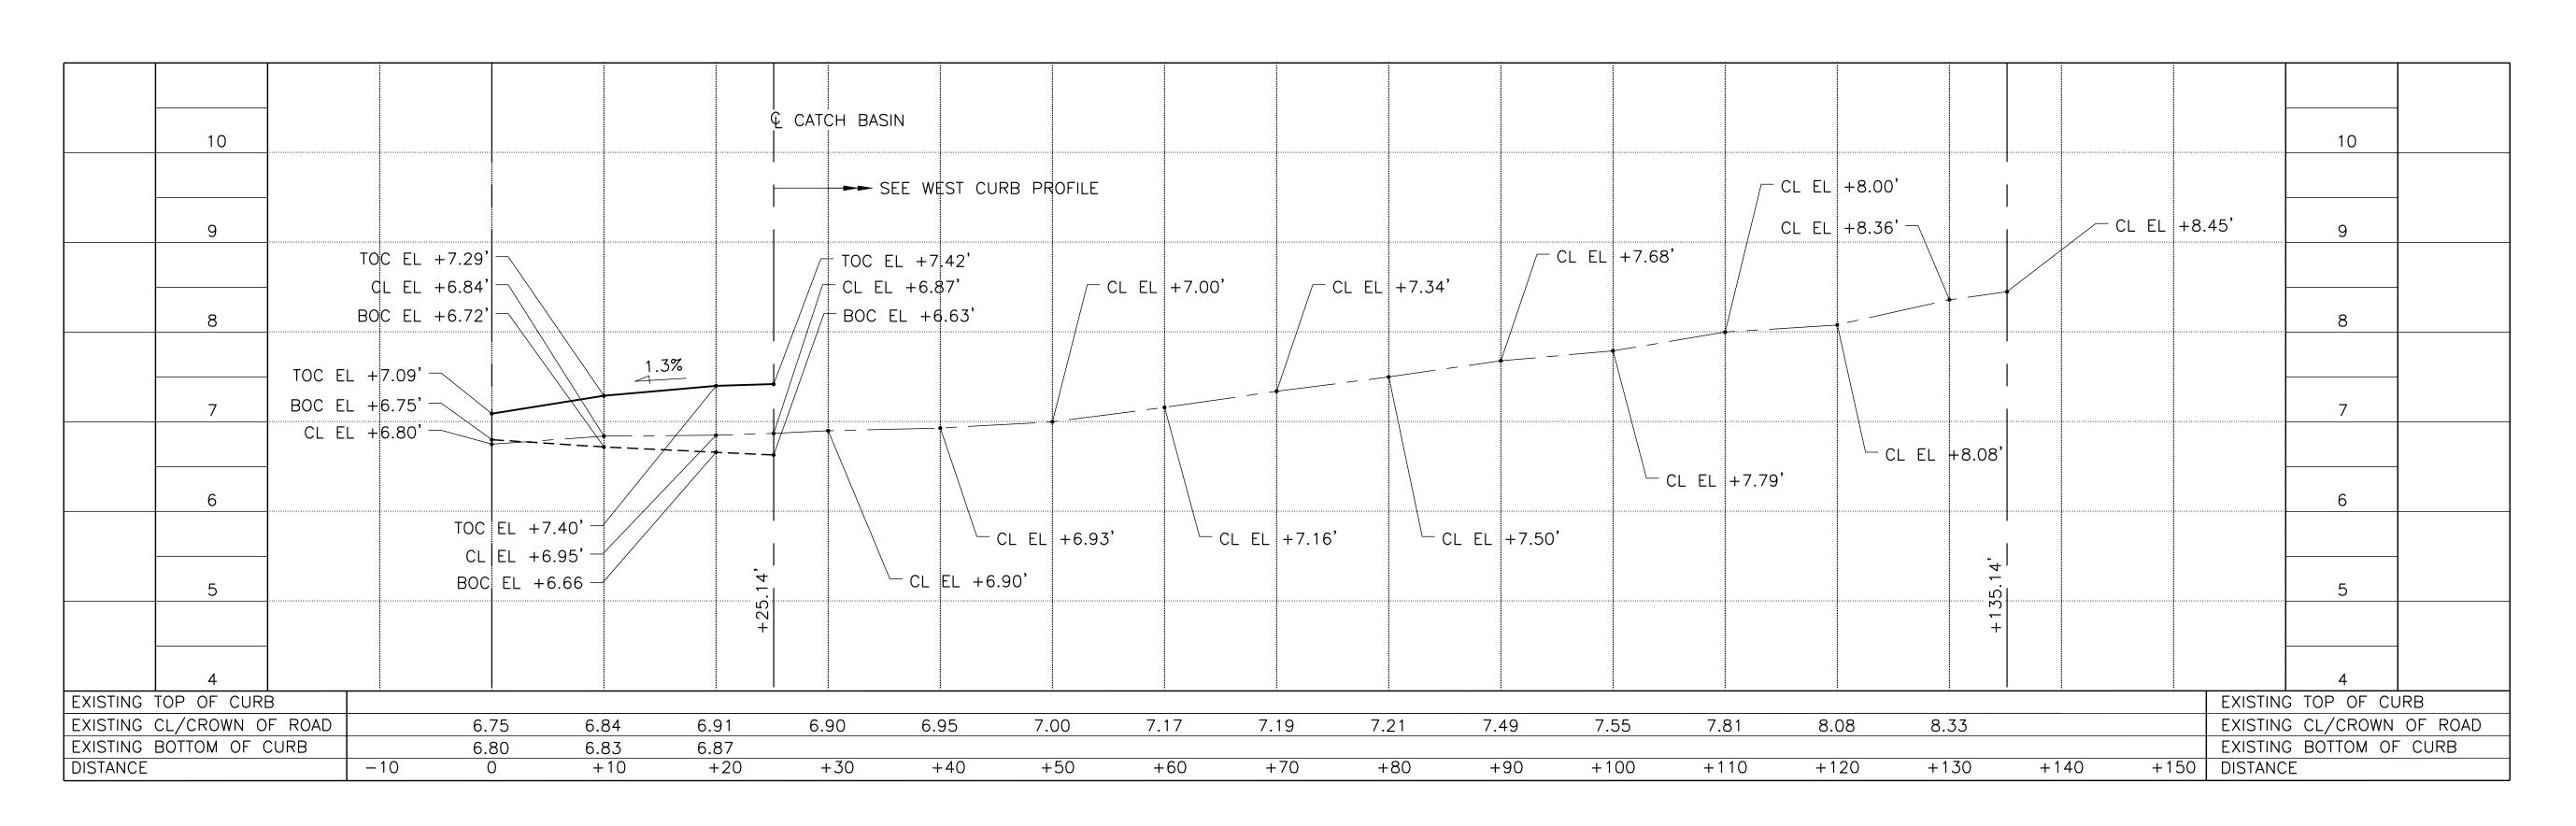

PROFILE ALONG 15TH STREET— NORTH SIDE (BASELINE 2) HORIZ. SCALE 1/8" = 1'-0", VERT. SCALE 1" = 1'-0"

CONCEPTUAL

SUBMITTED DATE: 1/31/2019

TOP OF CURB (TOC)

---- CROWN/ CL OF ROAD (CL)

BACK OF SIDEWALK (BOS)

CENTERLINE

TOP OF SIDEWALK (TOS)

<u>LEGEND</u>

DATE DESCRIPTIONS BY APPR'C REVISIONS CLOSURE STRUCTURES INSTALLATION OF CITY OF NEW YORK EAST SIDE COASTAL RESILIENCY 15TH STREET GATES REGRADING PROFILES BOROUGH OF MANHATTAN SHEET 1 OF 2 SANDRESM1-FG442-00.DWG CH2M DRAWN BY CAPITAL PROJECT NO. SANDRESM1 1/31/19 233 OF 811 FG442

INFORMATION SEE SURVEY SET SU100 DRAWINGS SERIES

TOPOGRAPHIC SURVEY PREPARED BY: FOR SURVEYOR


OAKRF KSE


FINAL DESIGN SUBMITTED BY:

FINAL DESIGN PREPARED BY: CH2M HILL NEW YORK, INC.
NAME OF CONSULTANT

SIGNATURE DATE

DEPARTMENT OF DESIGN + CONSTRUCTION DIVISION OF INFRASTRUCTURE **BUREAU OF DESIGN**

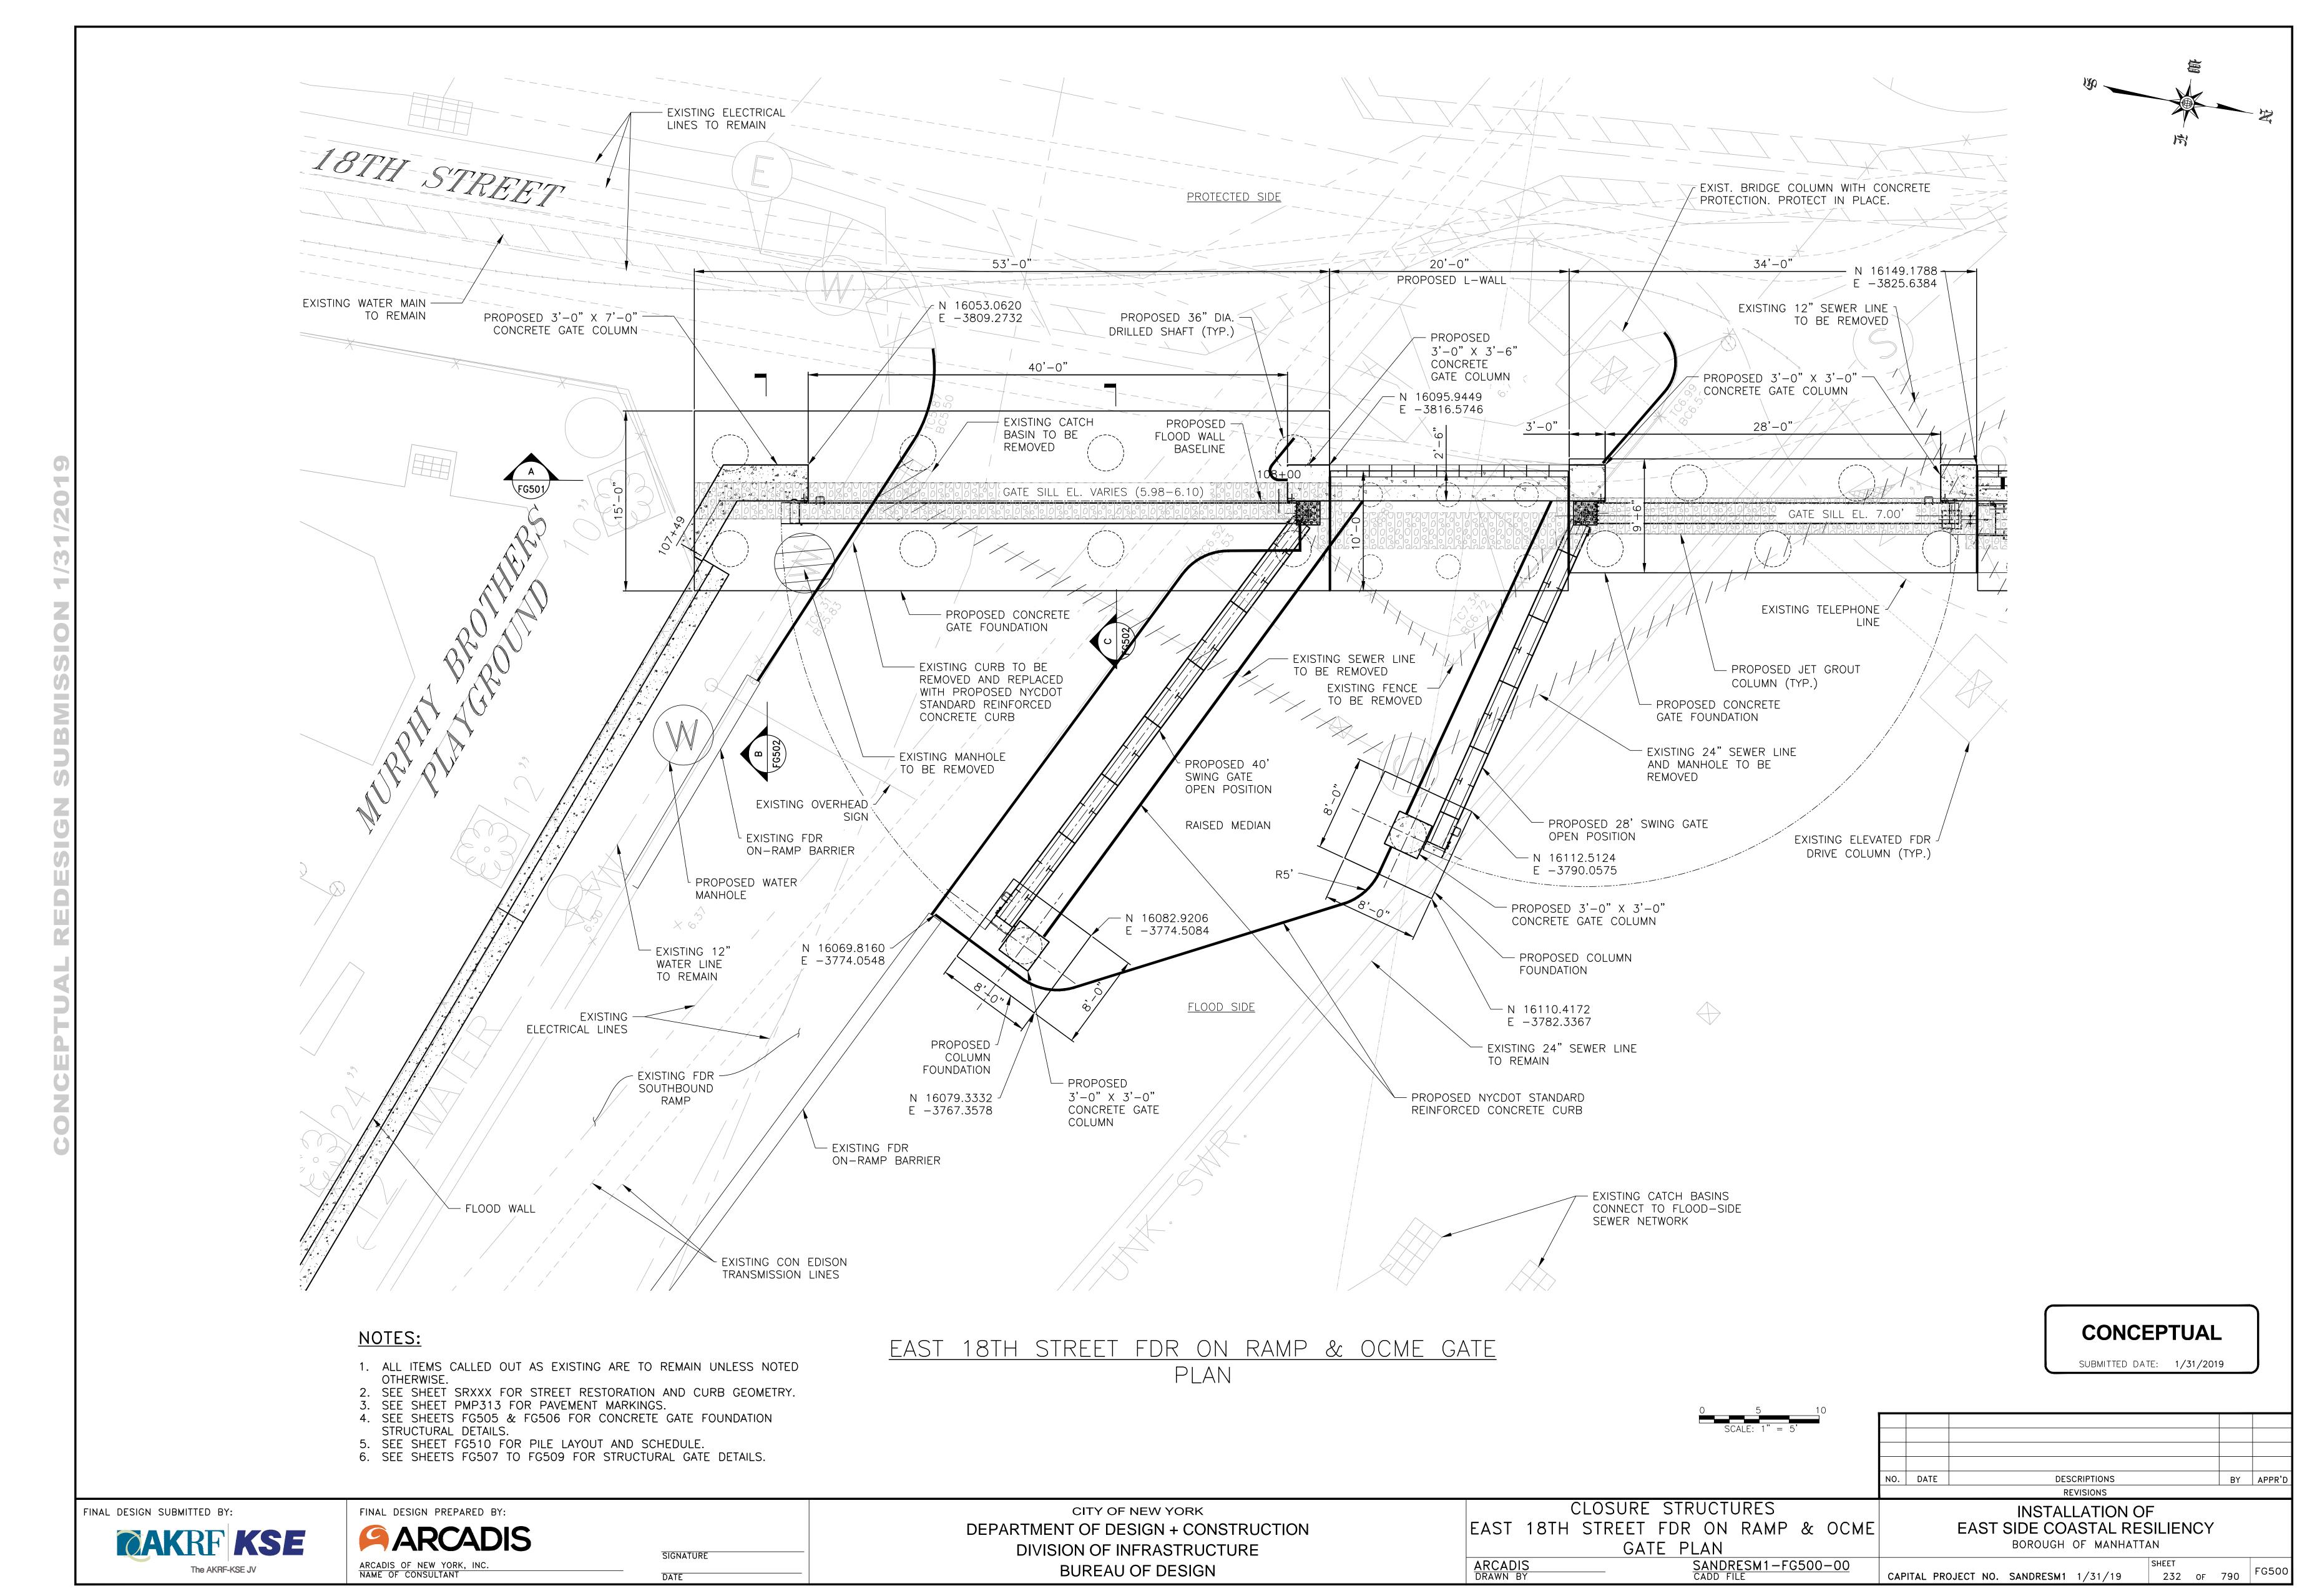

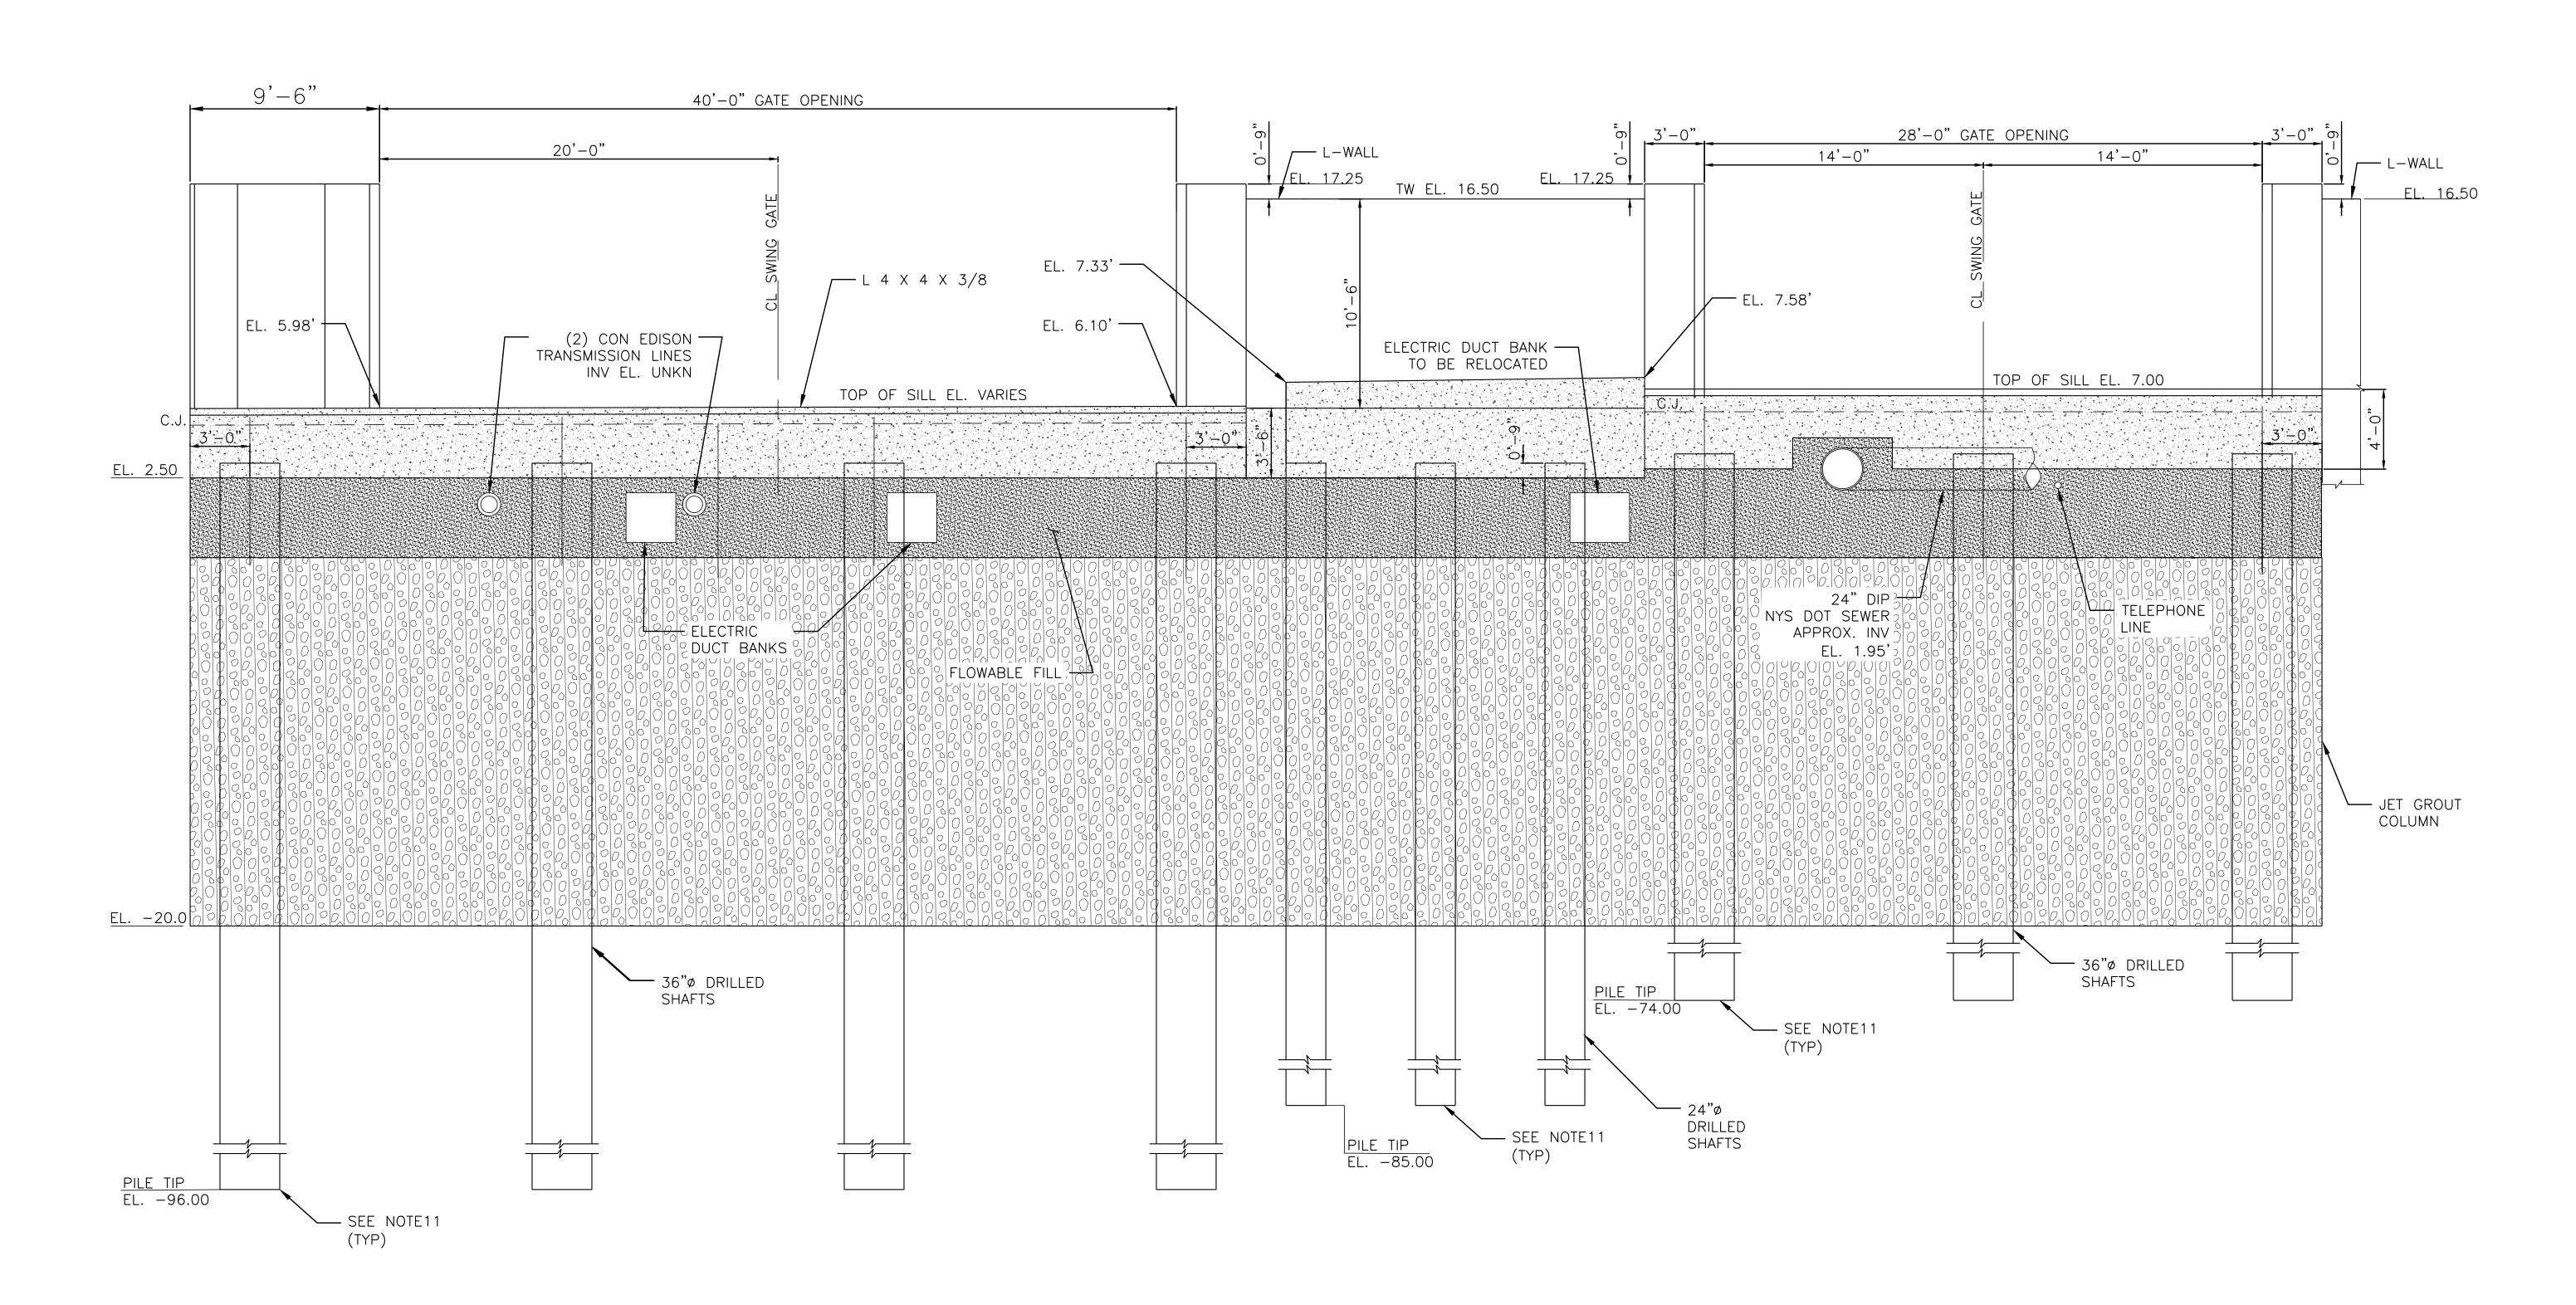

EAST 18TH STREET FDR ON RAMP AND OCME GATE PROTECTED SIDE ELEVATION

SCALE: $\frac{3}{8}$ " = 1'-0"

LEGEND:



FLOWABLE FILL



JET GROUT

NOTES:

- 1. JET GROUTING SHALL BE PERFORMED WITH THE TRIPLE FLUID SYSTEM.
- 2. THE MINIMUM UNCONFINED COMPRESSIVE DESIGN STRENGTH OF THE SOILCRETE SHALL BE 500 PSI AT 3 DAYS AND 750 PSI AT 28 DAYS.
- 3. THE DESIGN PERMEABILITY OF THE SOILCRETE SHALL BE LESS THAN 1.0 X 10⁻⁶ CM/SEC.
- 4. USE VERTICAL AND ANGLED SLEEVE PIPES AS REQUIRED TO PERFORM JET GROUTING AROUND AND BELOW THE UTILITY LINES.
- 5. PRIOR TO PERFORMING JET GROUTING AND DRIVING SHEET PILES AT/NEAR EACH UTILITY LINE CROSSING LOCATION, PRE-TRENCH EXCAVATION TO LOCATE/EXPOSE THE UTILITY LINE (THEN BACKFILLING) AS REQUIRED.
- 6. FOR EXISTING UTILITY LINES LOCATED WITHIN THE LIMITS OF PROPOSED SOIL IMPROVEMENTS, SEE UTILITY CROSSING TYPE A, B, C AND D.
- 7. 14TH STREET CANARSIE L- TUNNEL.
- 8. ALL SPOT ELEVATIONS ARE EXISTING ELEVATIONS IN NAVD88.
- 9. EXCAVATABLE FILL SHALL HAVE A COMPRESSIVE STRENGTH OF 100PSI.
- 10. UTILITIES ARE SHOWN FOR INFORMATION PURPOSES ONLY AND ARE NOT EXACT LOCATIONS.
 CONTRACTOR SHALL EXCAVATE A 4 FT DEEP 10 FT WIDE TRENCH TO IDENTIFY UTILITY TYPE, DEPTH AND DIMENSIONS PRIOR TO BEGINNING SOIL IMPROVEMENT WORK. SUBMIT DETAILS OF ALL SITE OBSERVED UTILITIES TO THE CLIENT BEFORE
- 11. ALL PILES TIP ELEVATION SHOULD BE AT RESPECTIVE LEVEL OR TILL TO THE BED ROCK

BEGINNING WORK.

CLOSURE STRUCTURES MURPHY BROTHERS AND OCME SWING GATE ELEVATION ARCADIS DRAWN BY CLOSURE STRUCTURES INSTALLATION OF EAST SIDE COASTAL RESILIENCY BOROUGH OF MANHATTAN SHEET CAPITAL PROJECT NO. SANDRESM1 1/31/19 SHEET CAPITAL PROJECT NO. SANDRESM1 1/31/19 FG501

CONCEPTUAL

SUBMITTED DATE: 1/31/2019

NO. DATE

DESCRIPTIONS

REVISIONS

INSTALLATION OF
EAST SIDE COASTAL RESILIENCY
BOROUGH OF MANHATTAN

TOPOGRAPHIC SURVEY PREPARED BY: FOR SURVEYOR INFORMATION SEE SURVEY SET SU100 DRAWINGS SERIES




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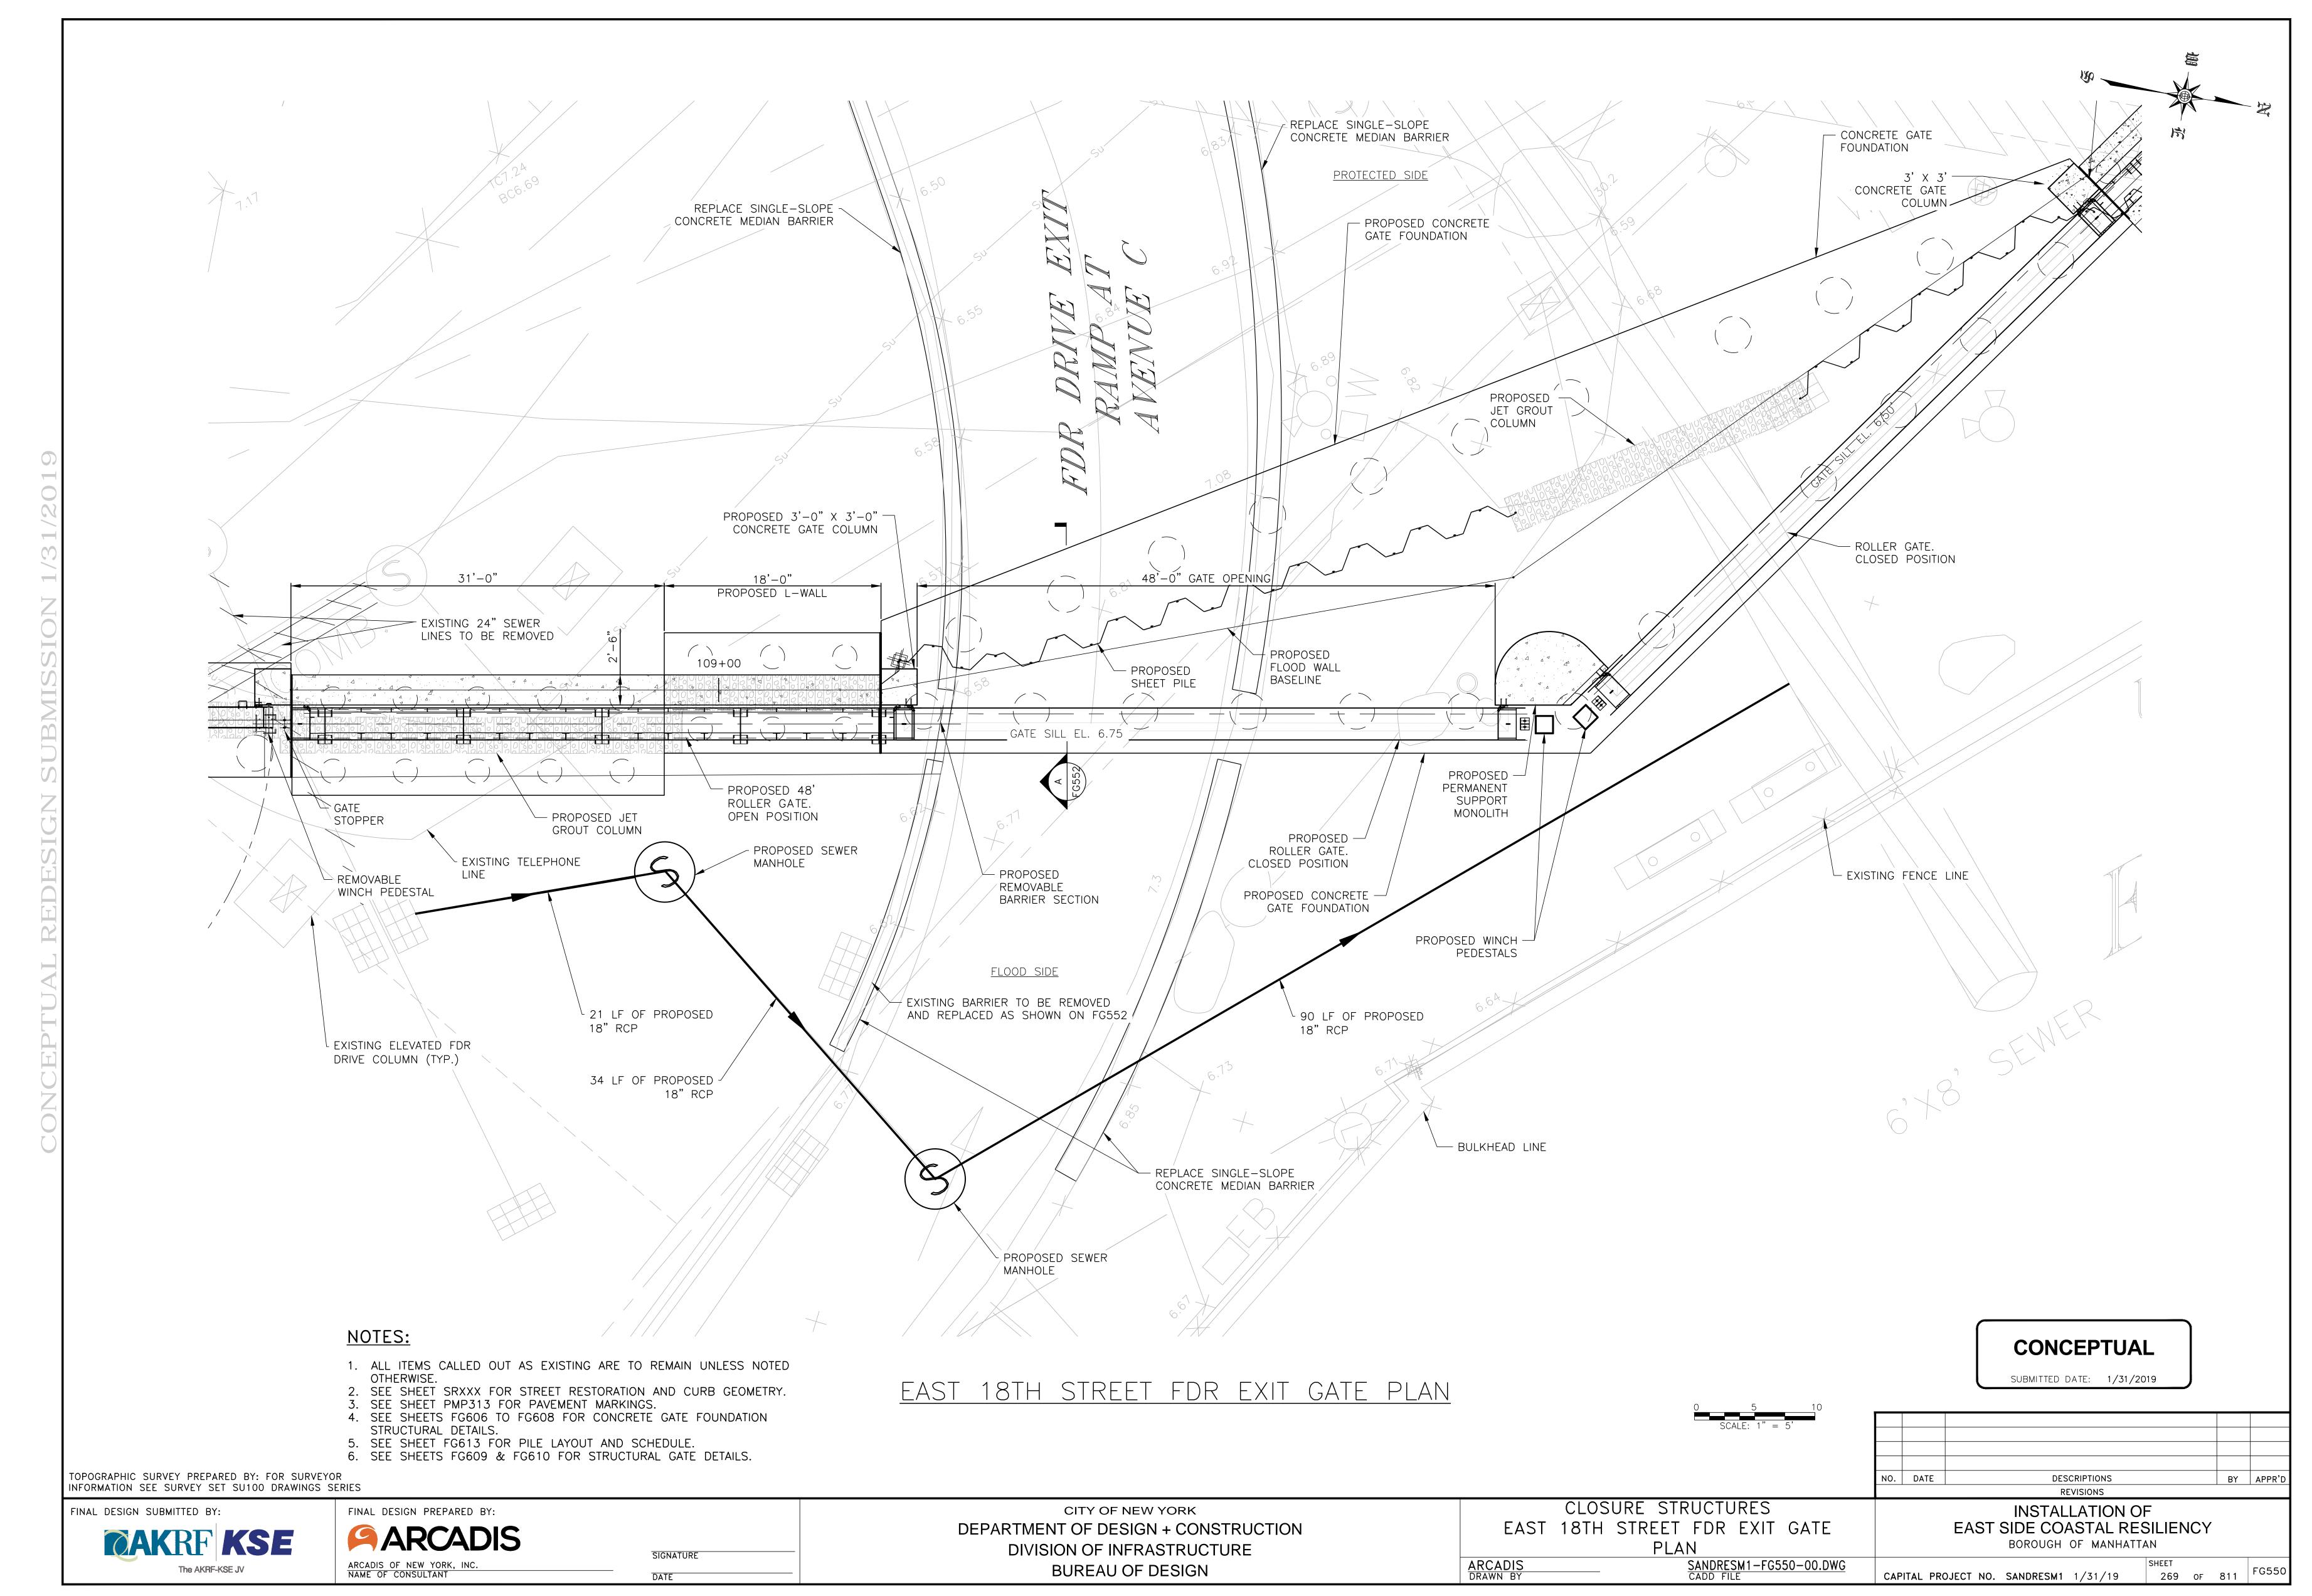
ARCADIS OF NEW YORK, INC.


NAME OF CONSULTANT

SIGNATURE DATE

DEPARTMENT OF DESIGN + CONSTRUCTION
DIVISION OF INFRASTRUCTURE
BUREAU OF DESIGN



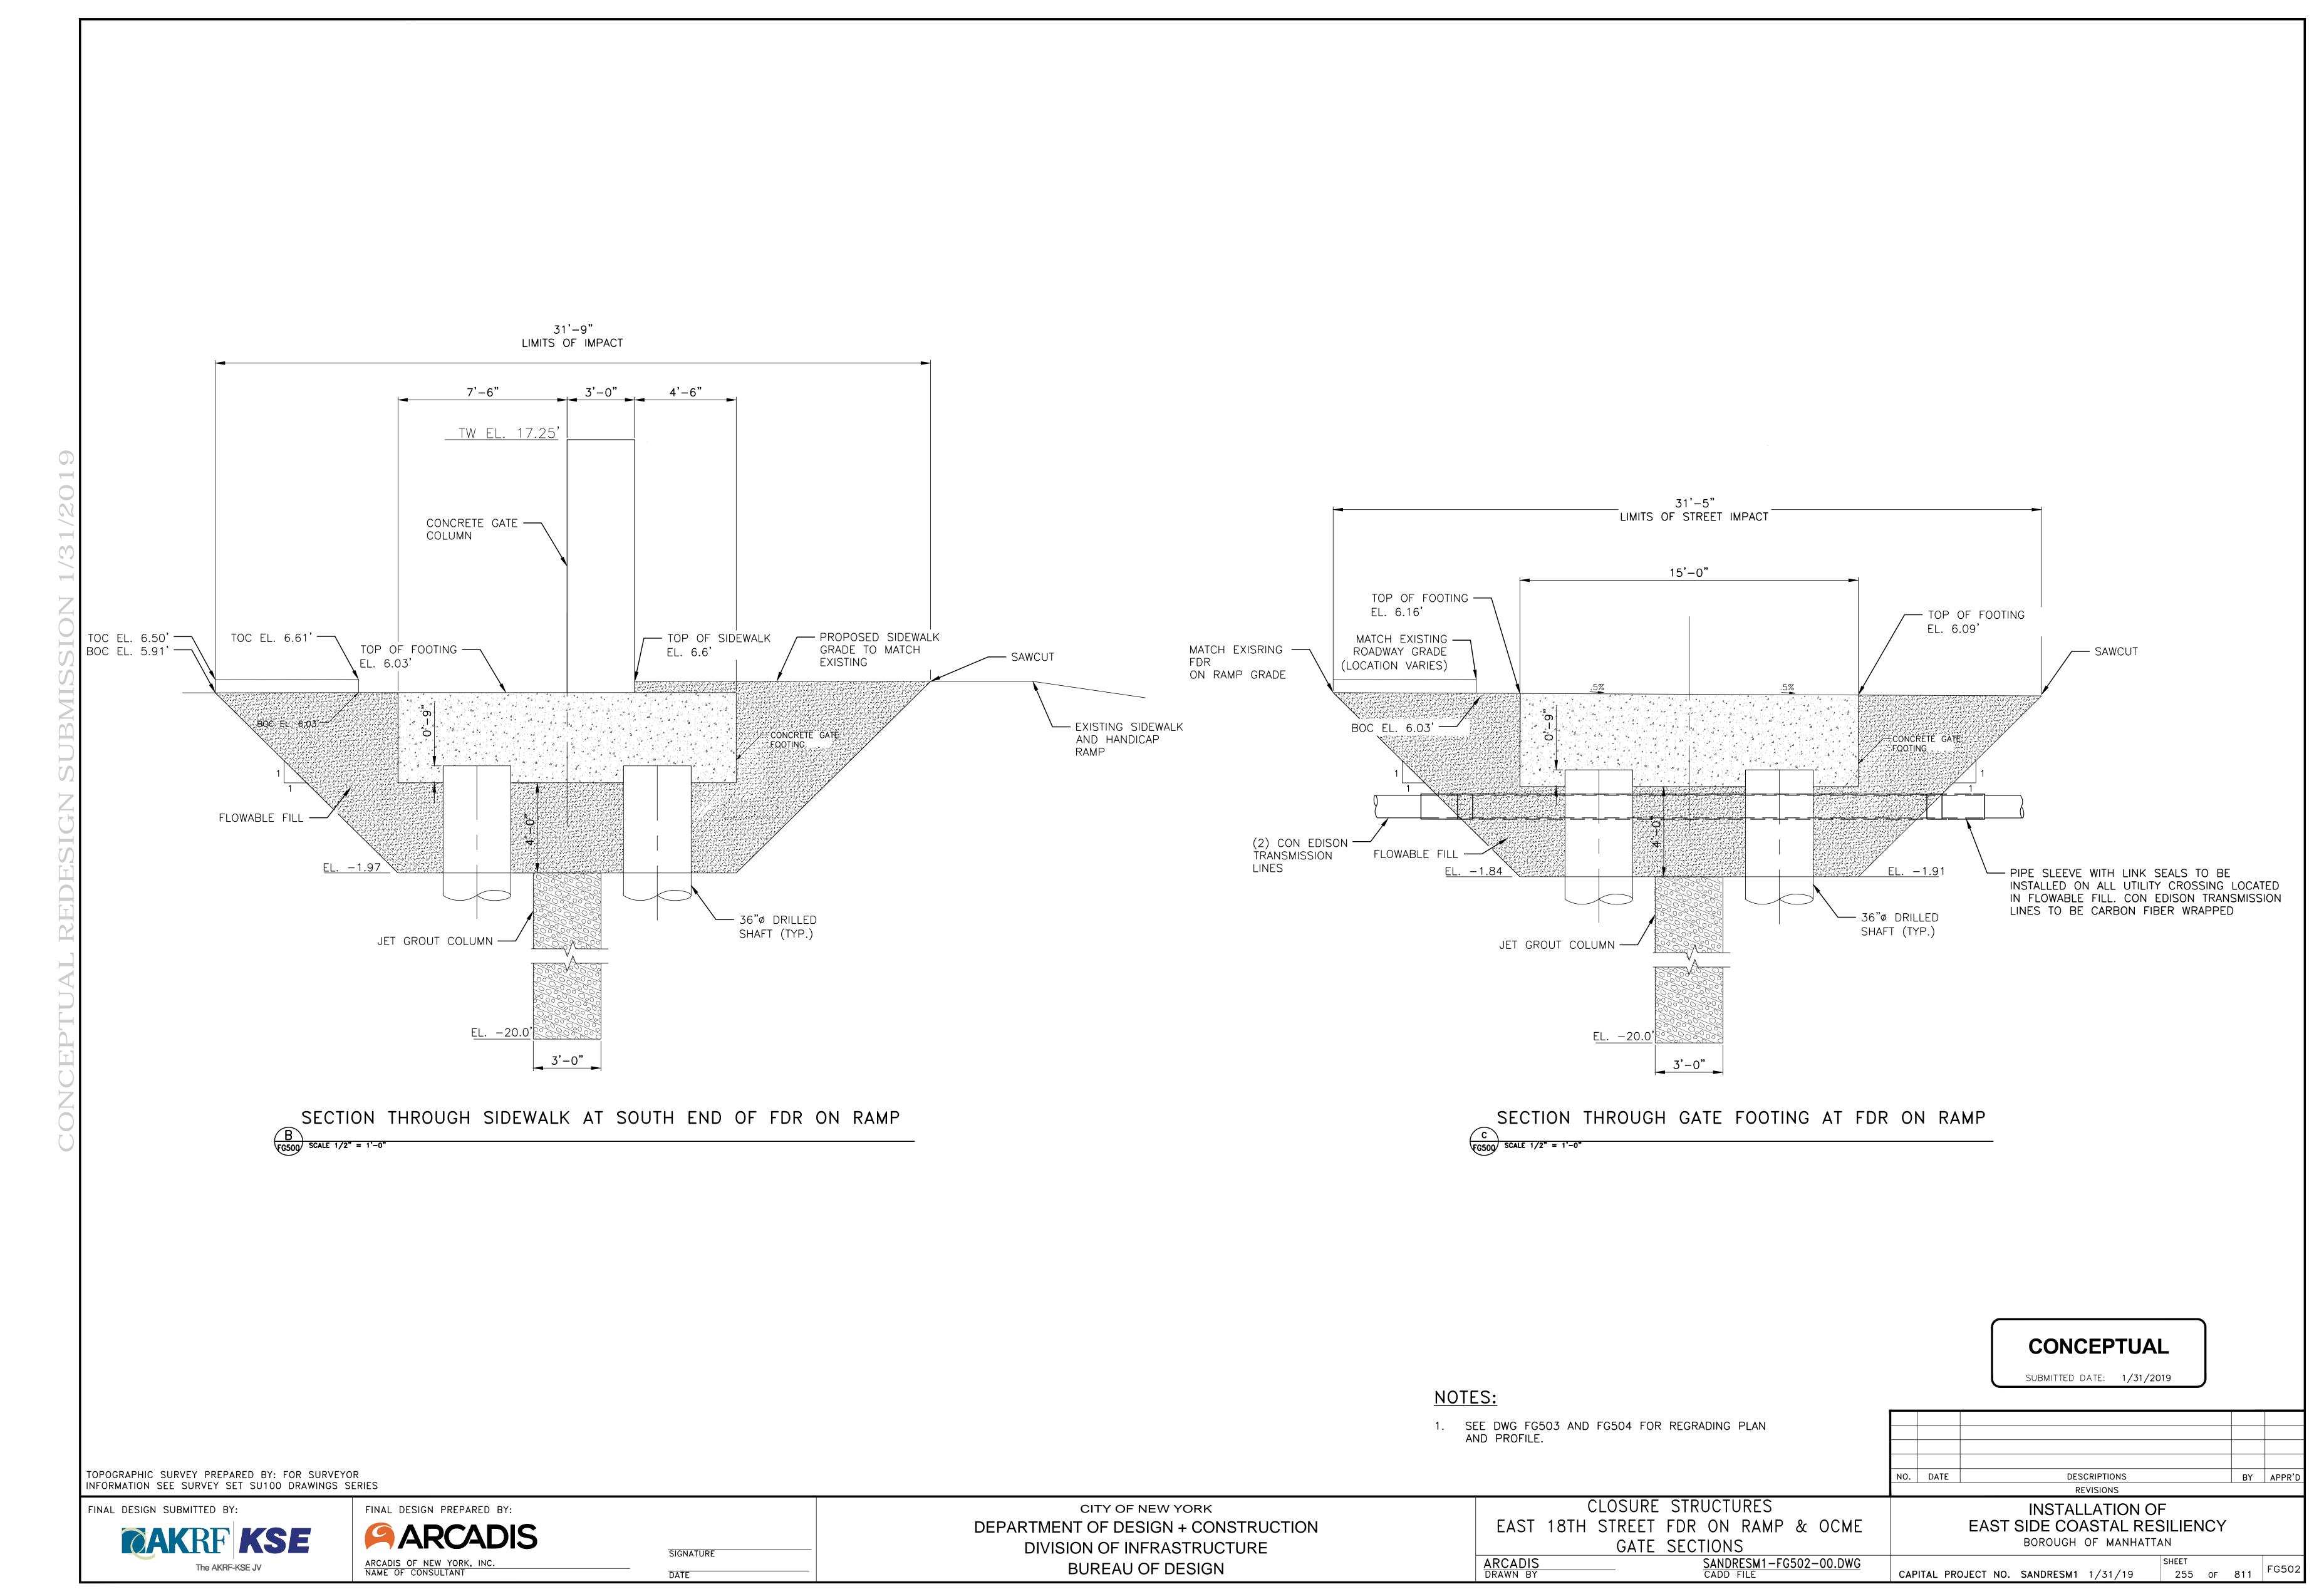

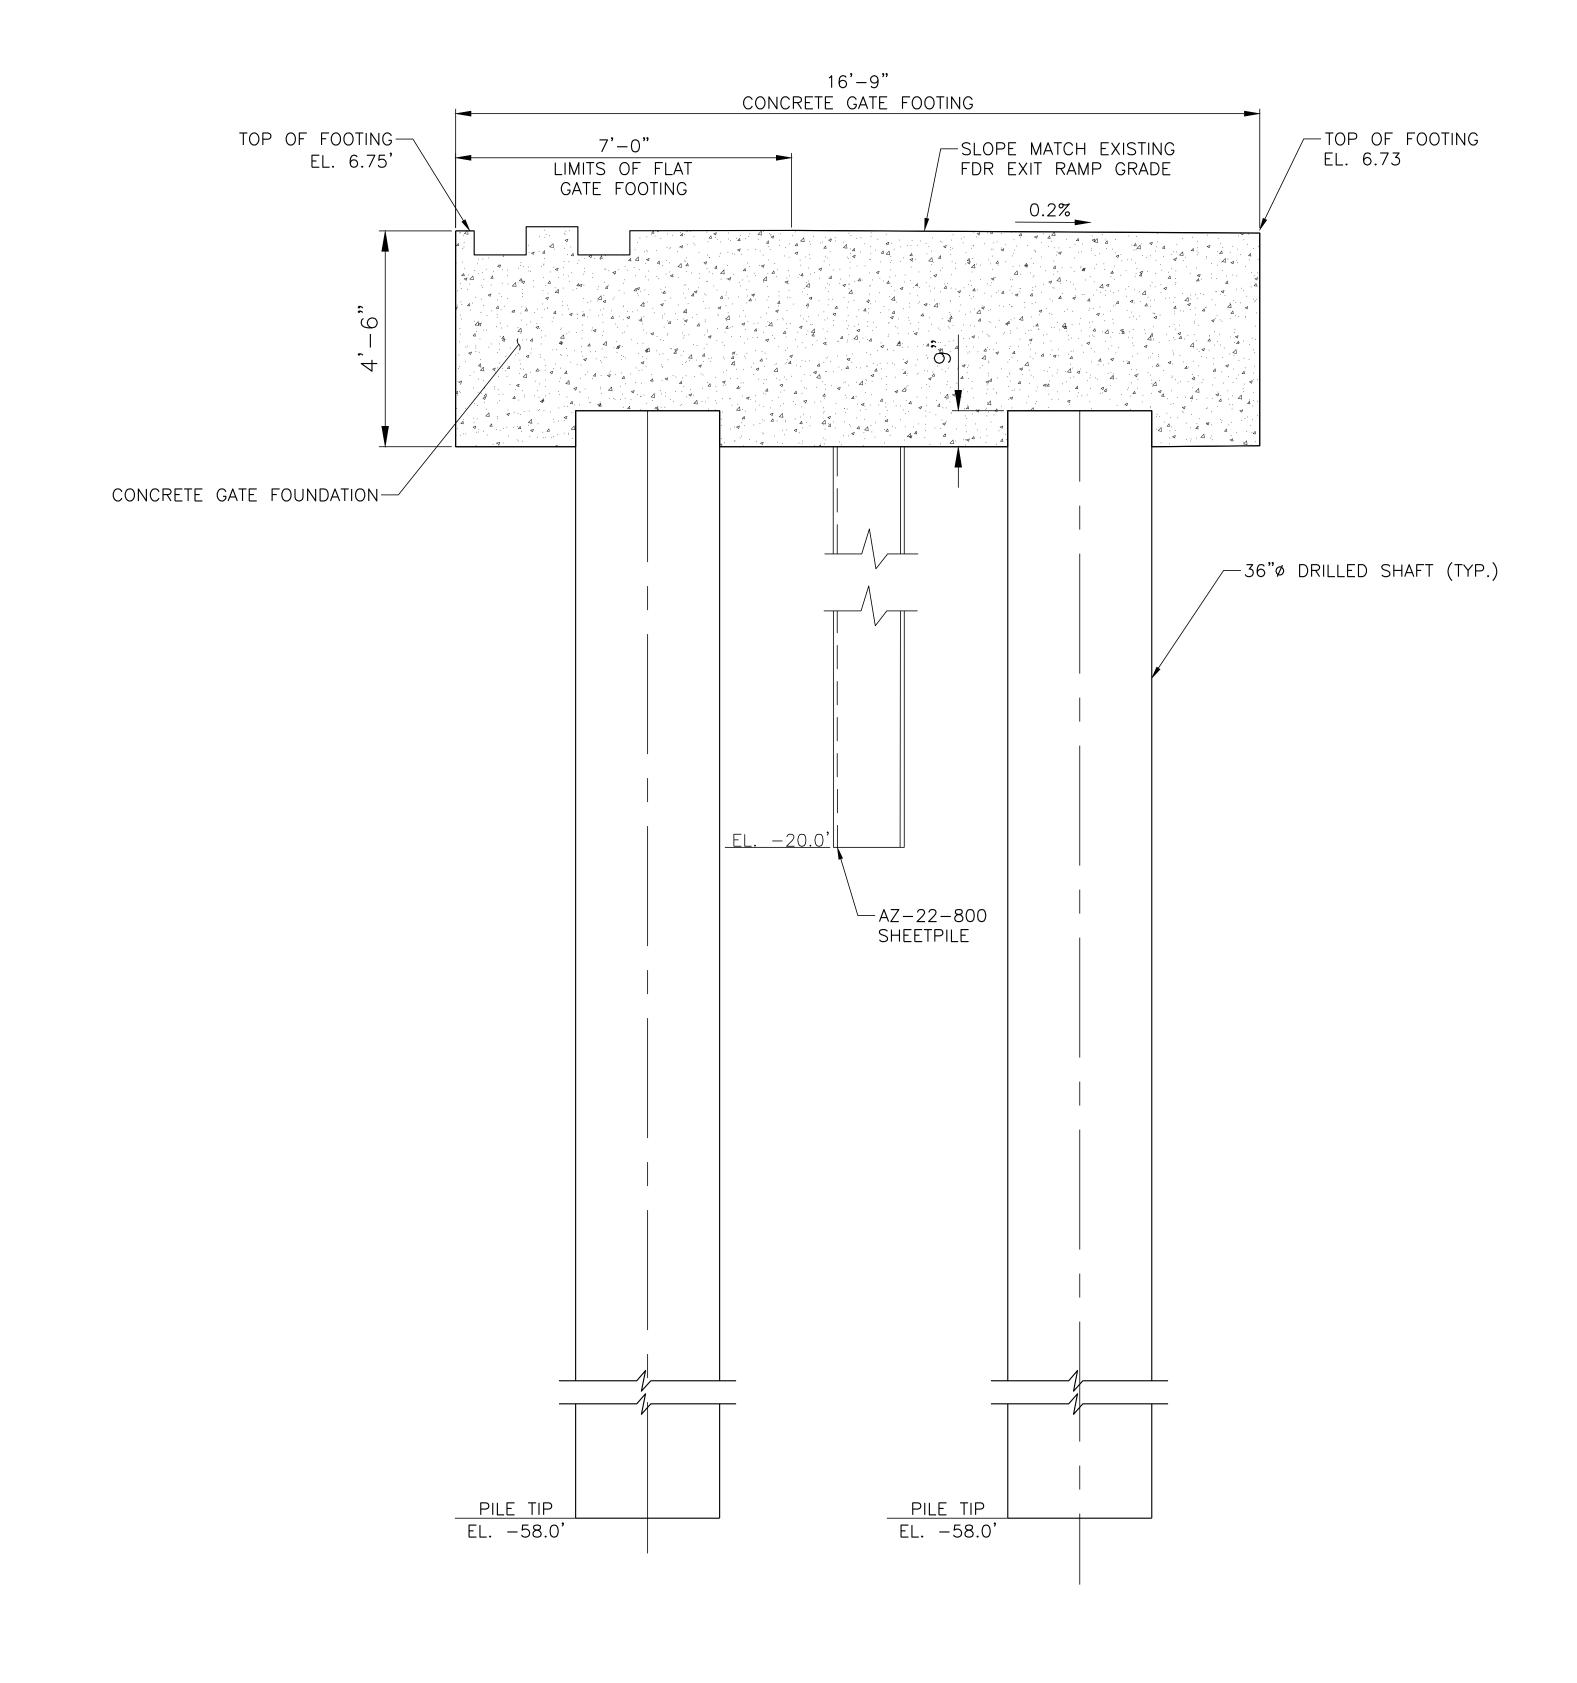

SECTION THROUGH FDR EXIT GATE

FG550 SCALE 1/2" = 1'-0"

CONCEPTUAL

SUBMITTED DATE: 1/31/2019

TOPOGRAPHIC SURVEY PREPARED BY: FOR SURVEYOR INFORMATION SEE SURVEY SET SU100 DRAWINGS SERIES

FINAL DESIGN SUBMITTED BY:

CAKRF KSE

The AKRF-KSE JV

FINAL DESIGN PREPARED BY:

ARCADIS OF NEW YORK, INC.

NAME OF CONSULTANT

SIGNATURE

CITY OF NEW YORK
DEPARTMENT OF DESIGN + CONSTRUCTION
DIVISION OF INFRASTRUCTURE
BUREAU OF DESIGN

CLOSURE STRUCTURES
FDR EXIT GATE
SECTION

ARCADIS
DRAWN BY


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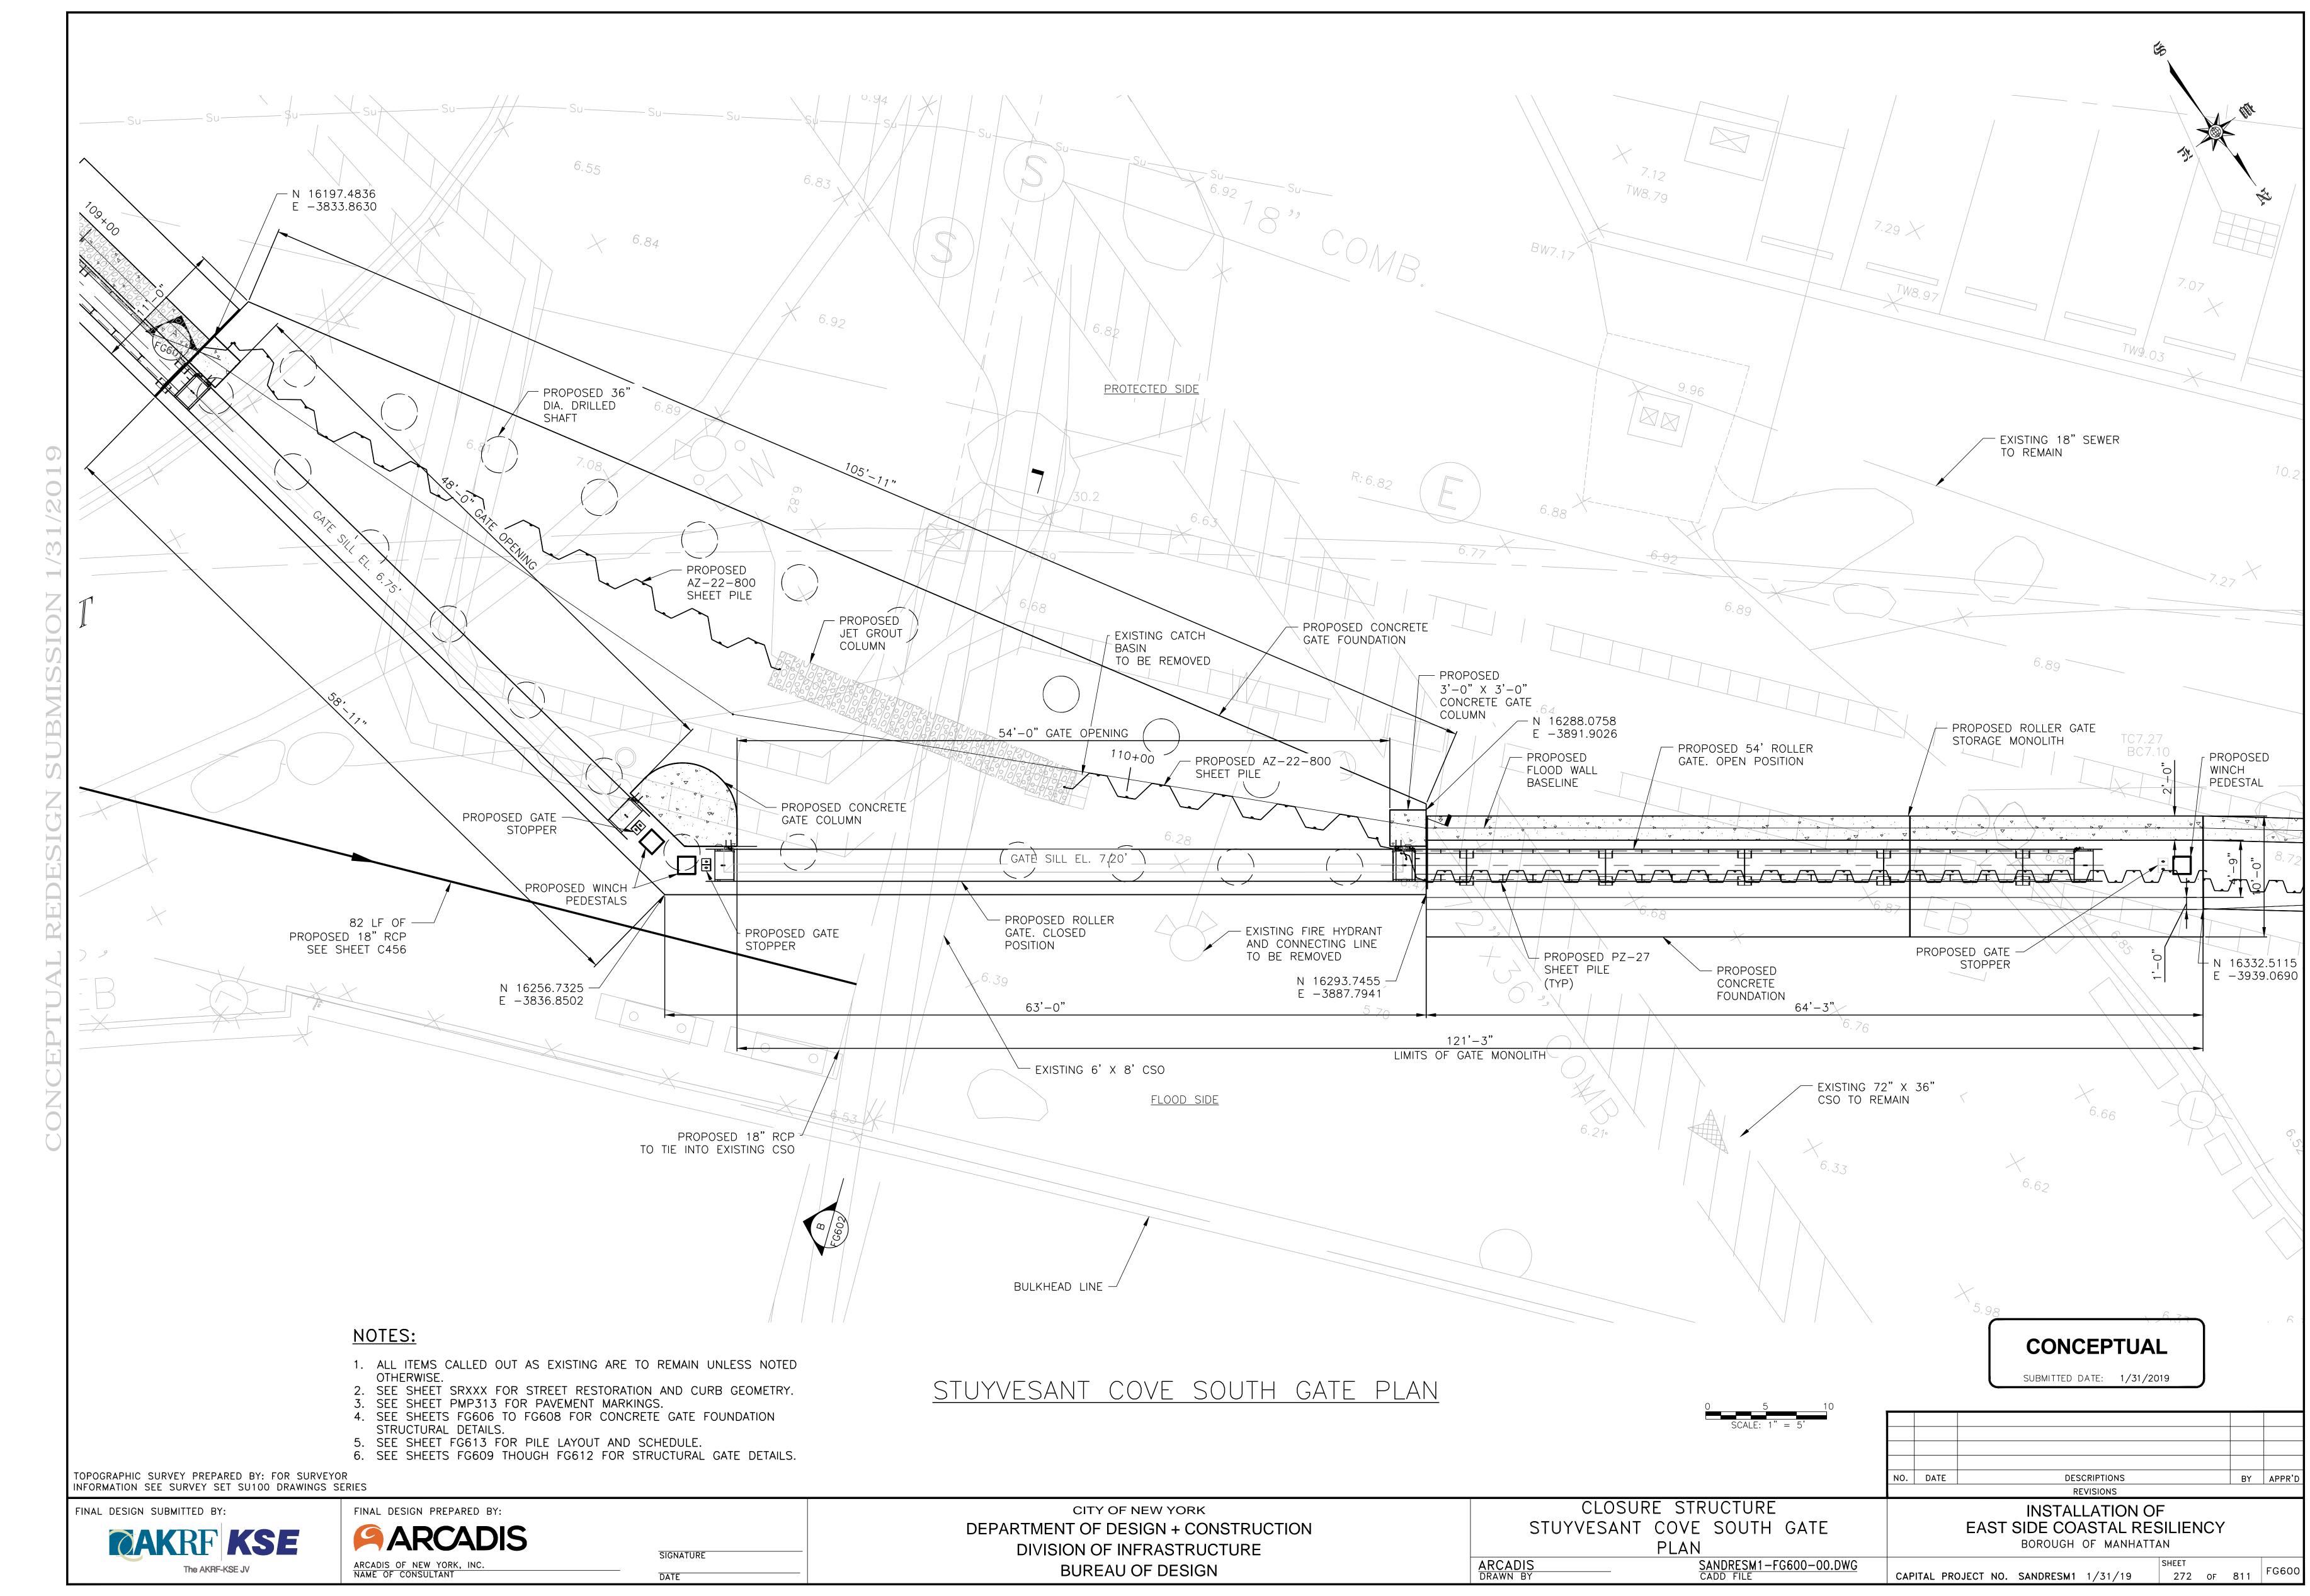
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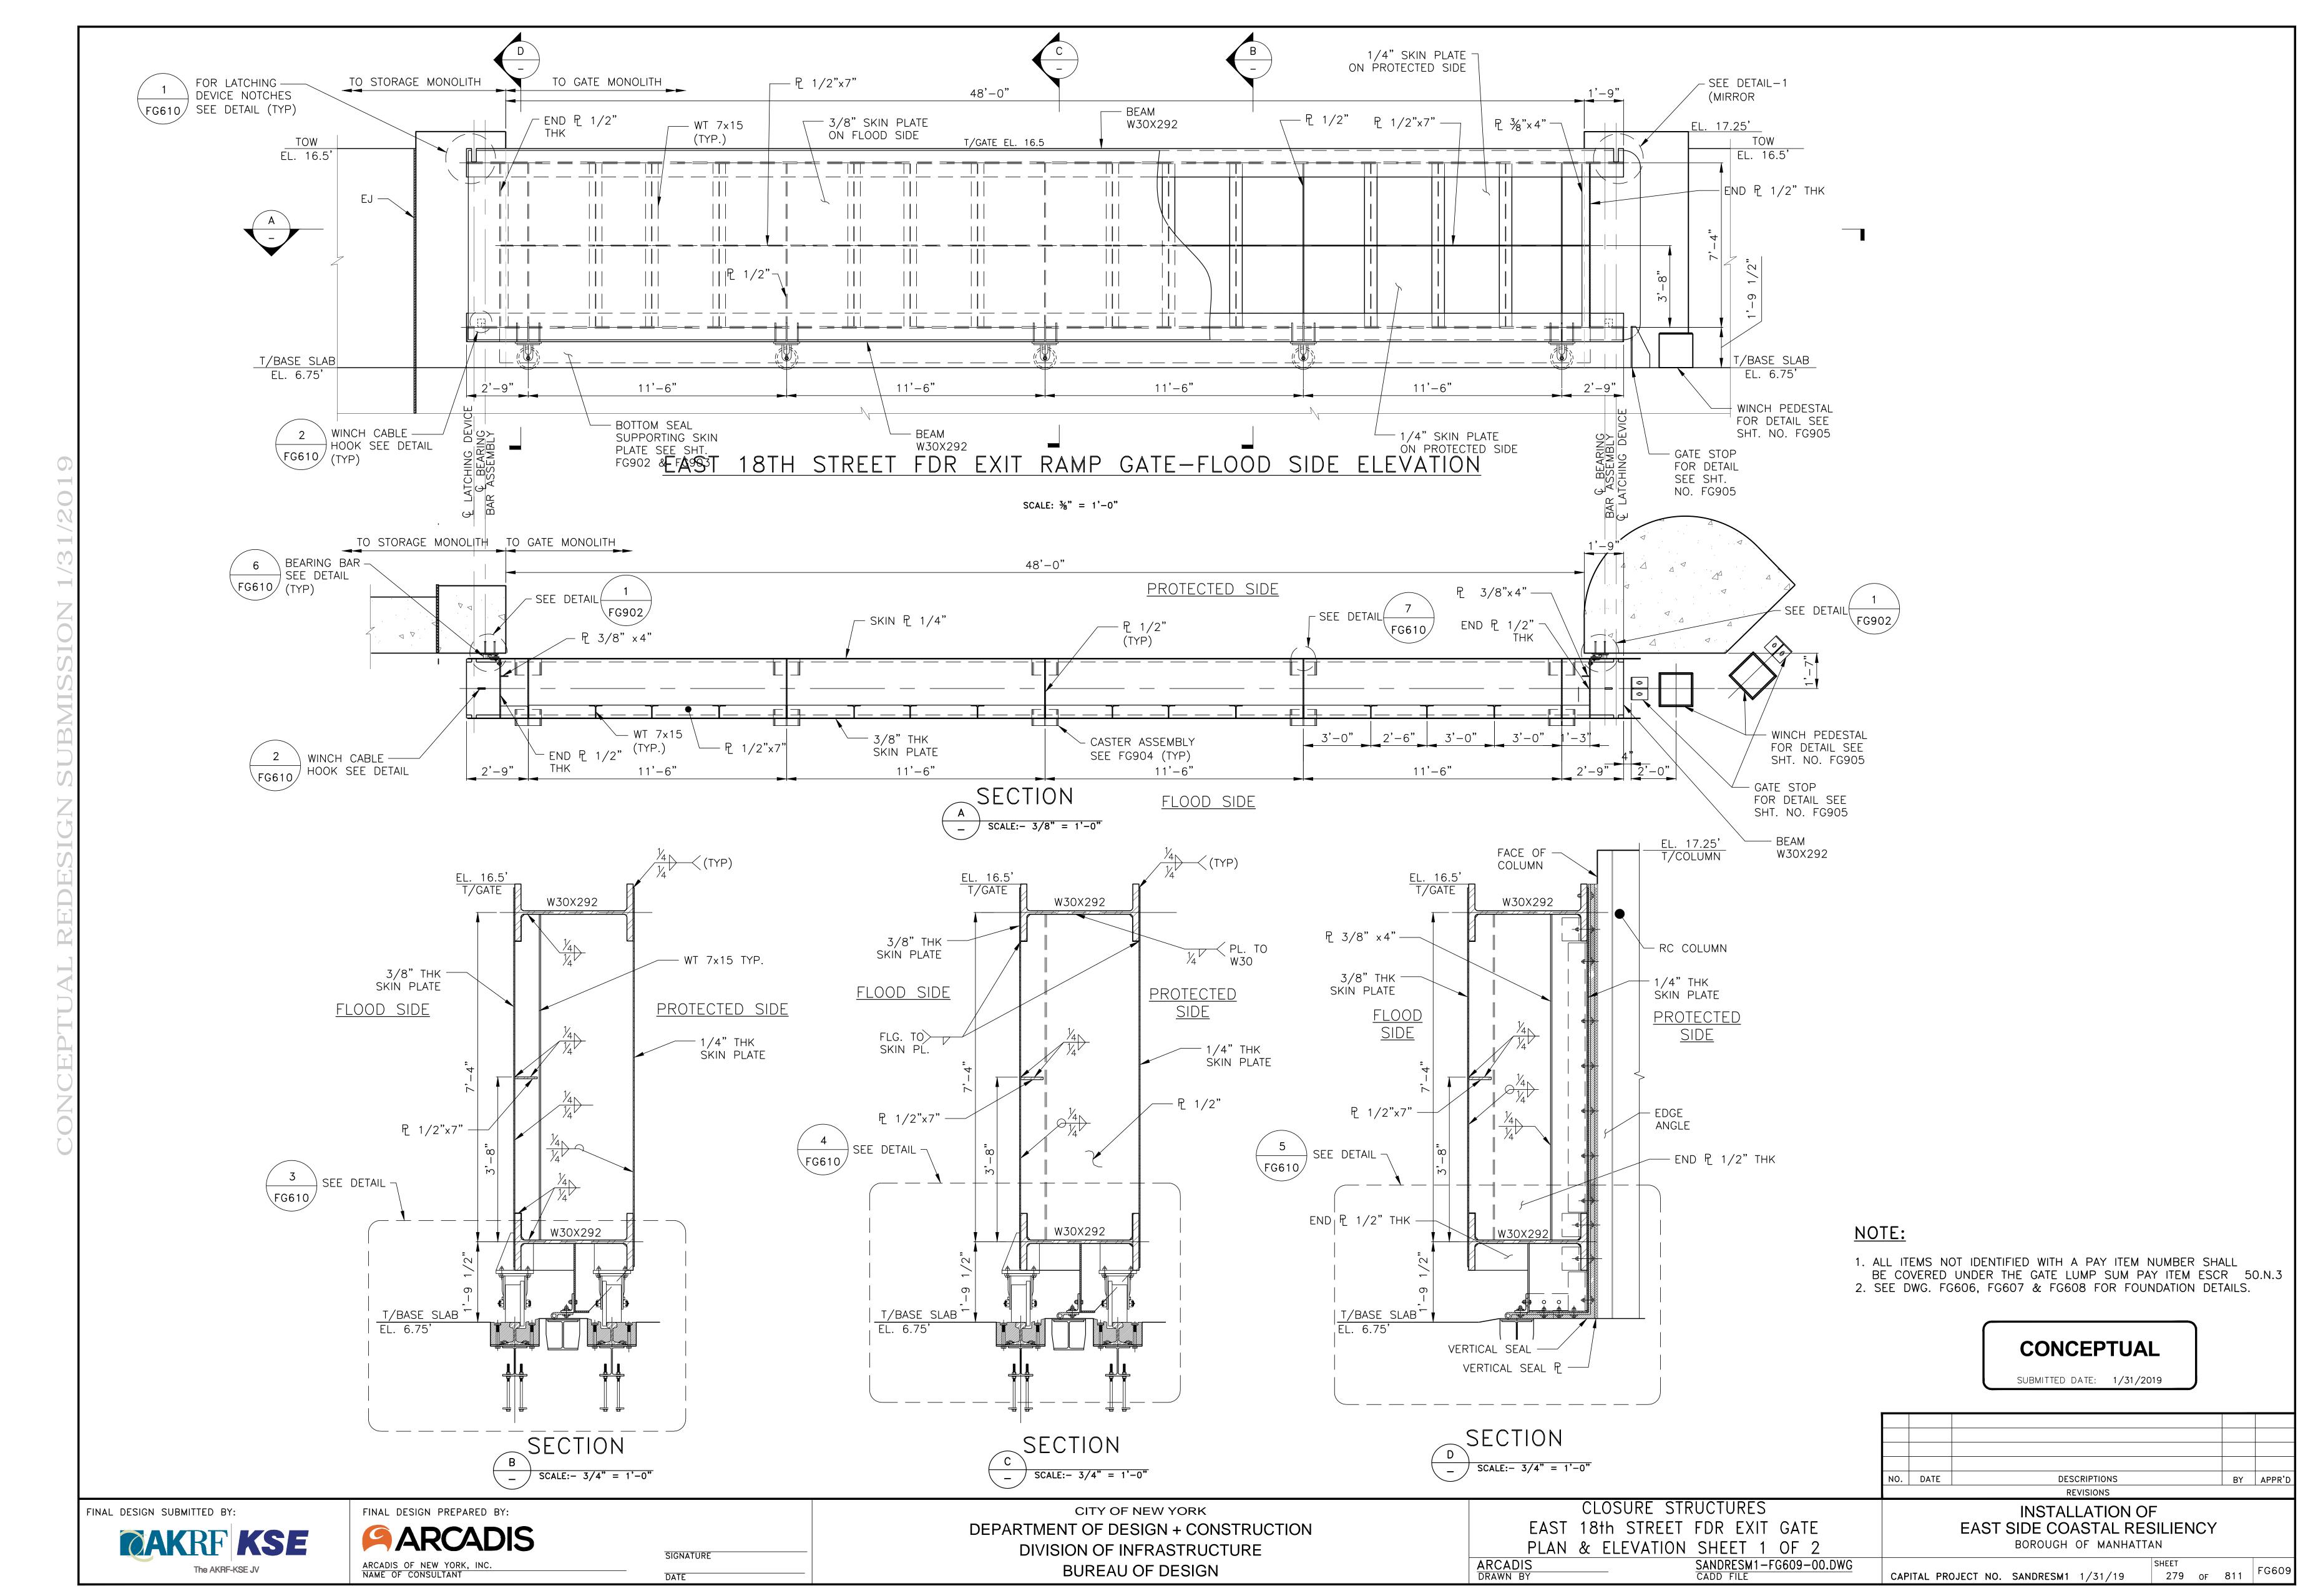
REVISIONS


INSTALLATION OF
EAST SIDE COASTAL RESILIENCY
BOROUGH OF MANHATTAN


CAPITAL PROJECT NO. SANDRESM1 1/31/19







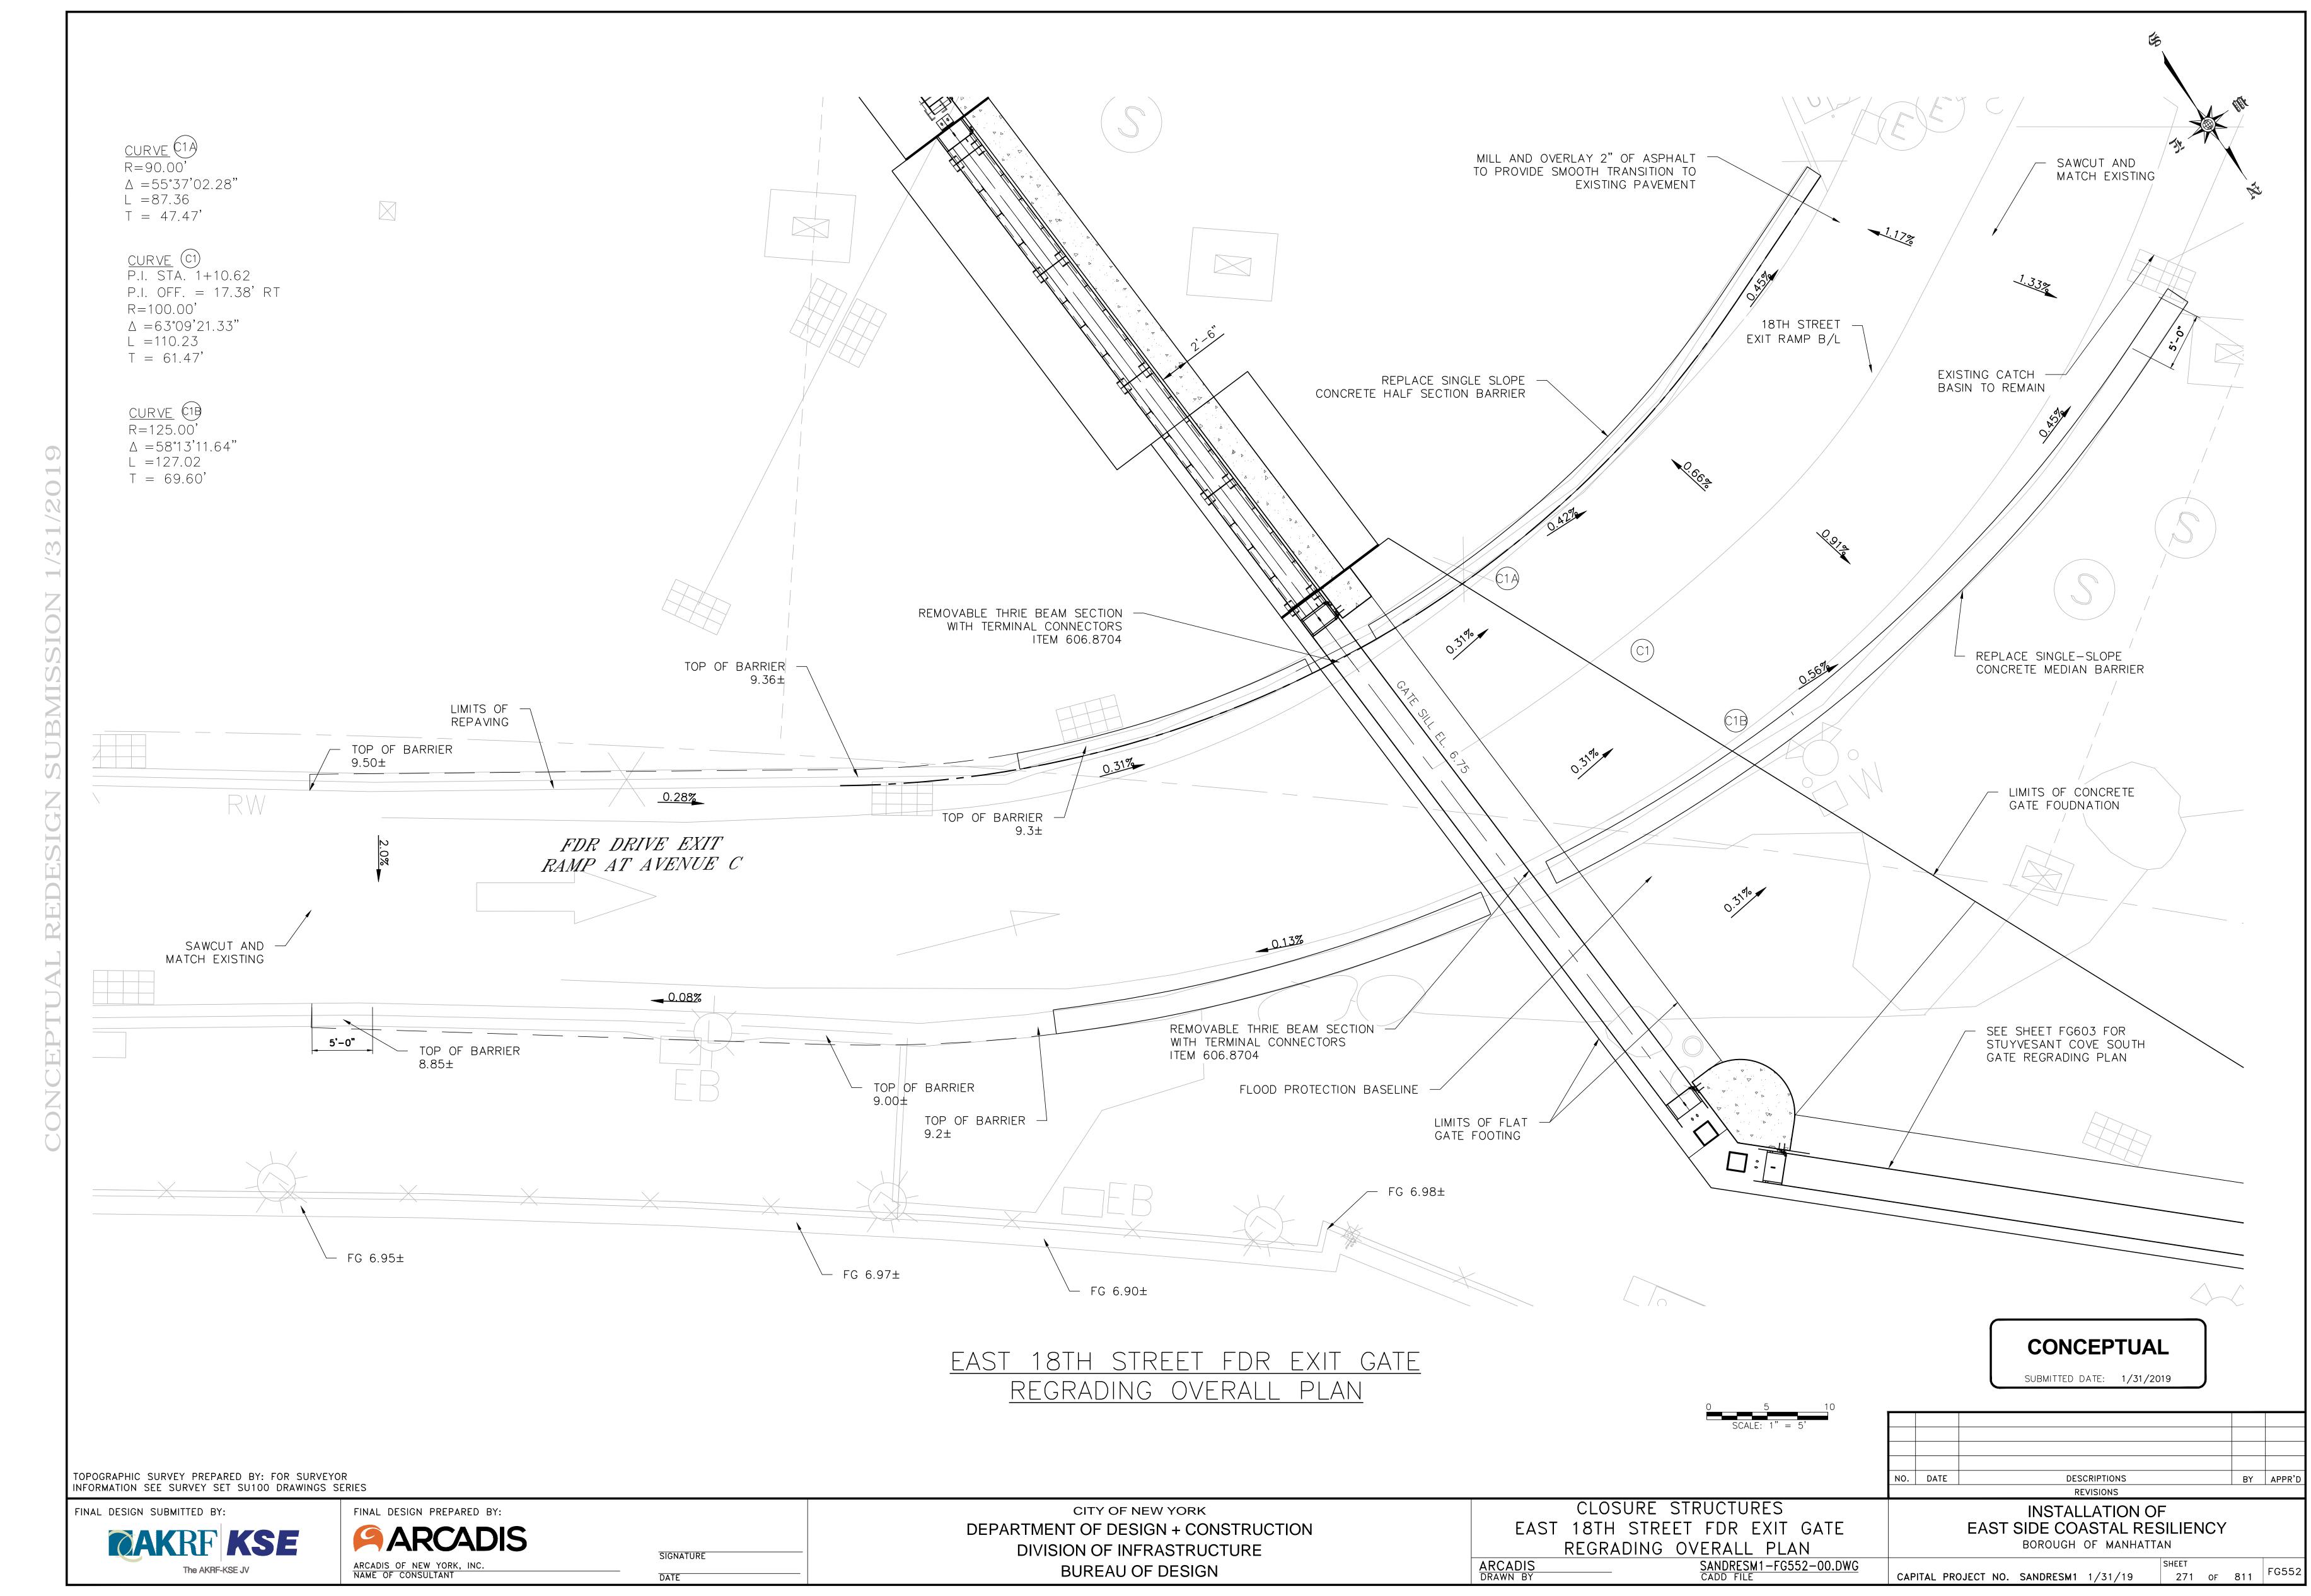

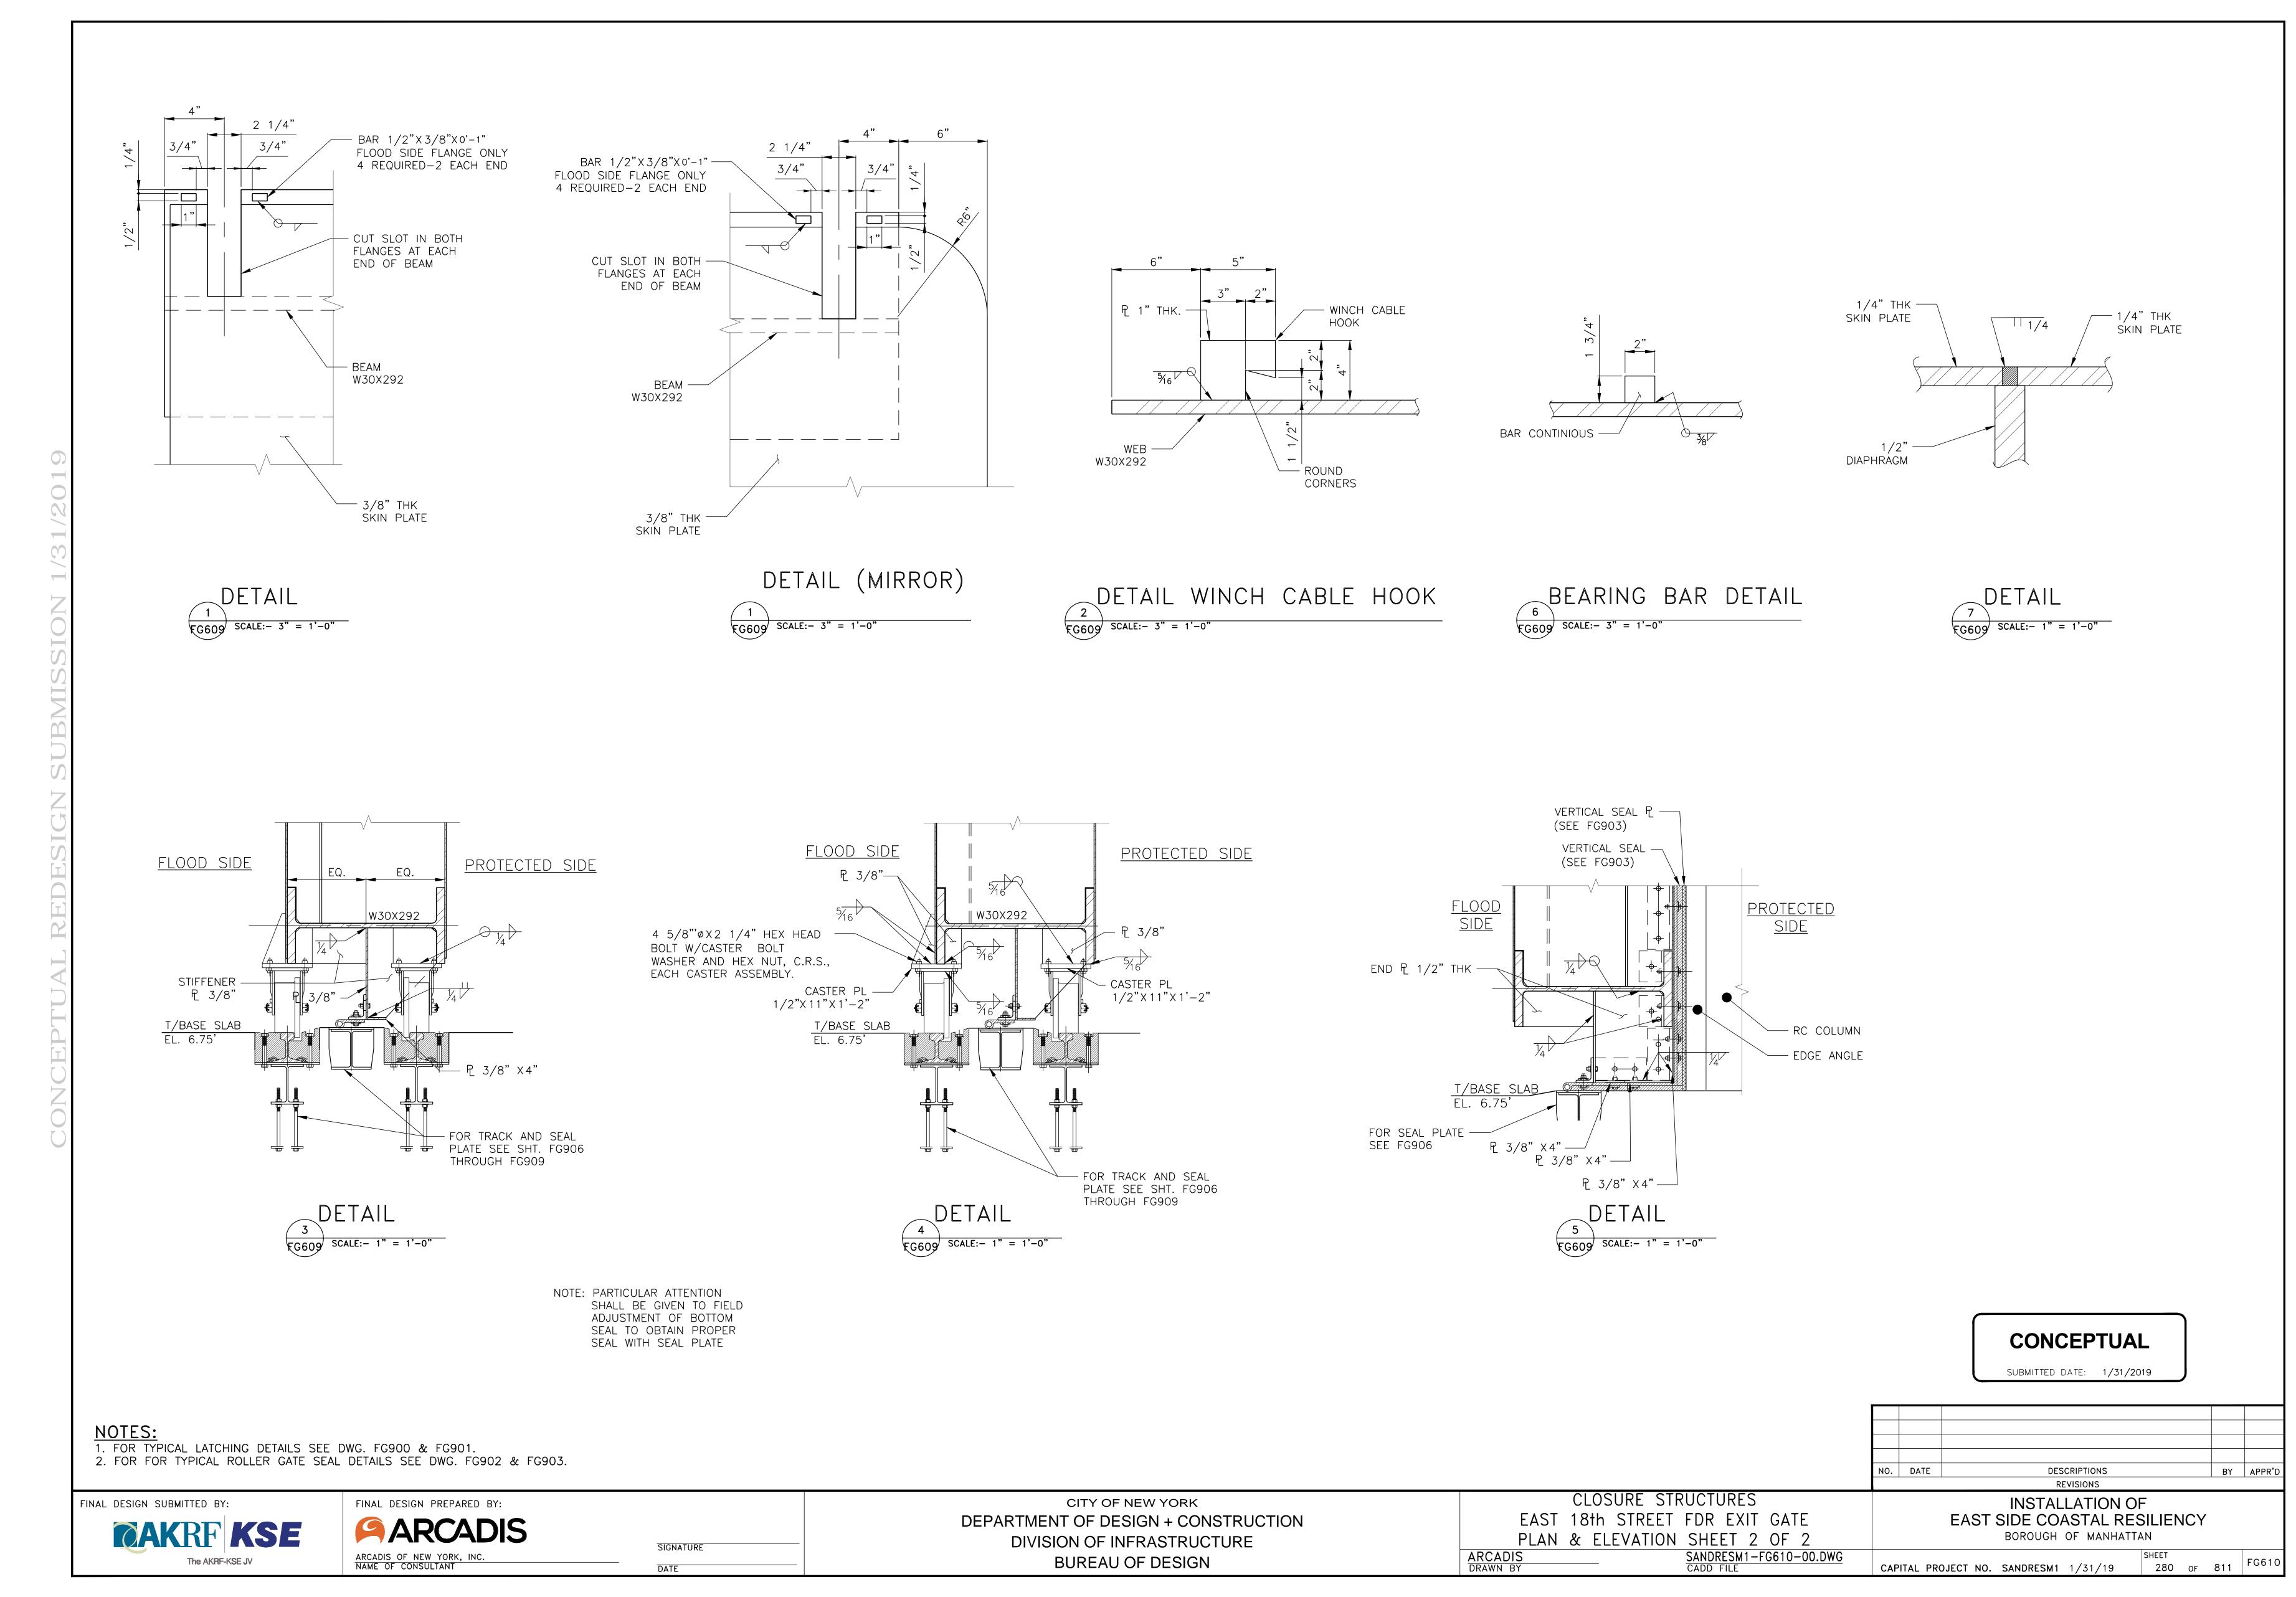

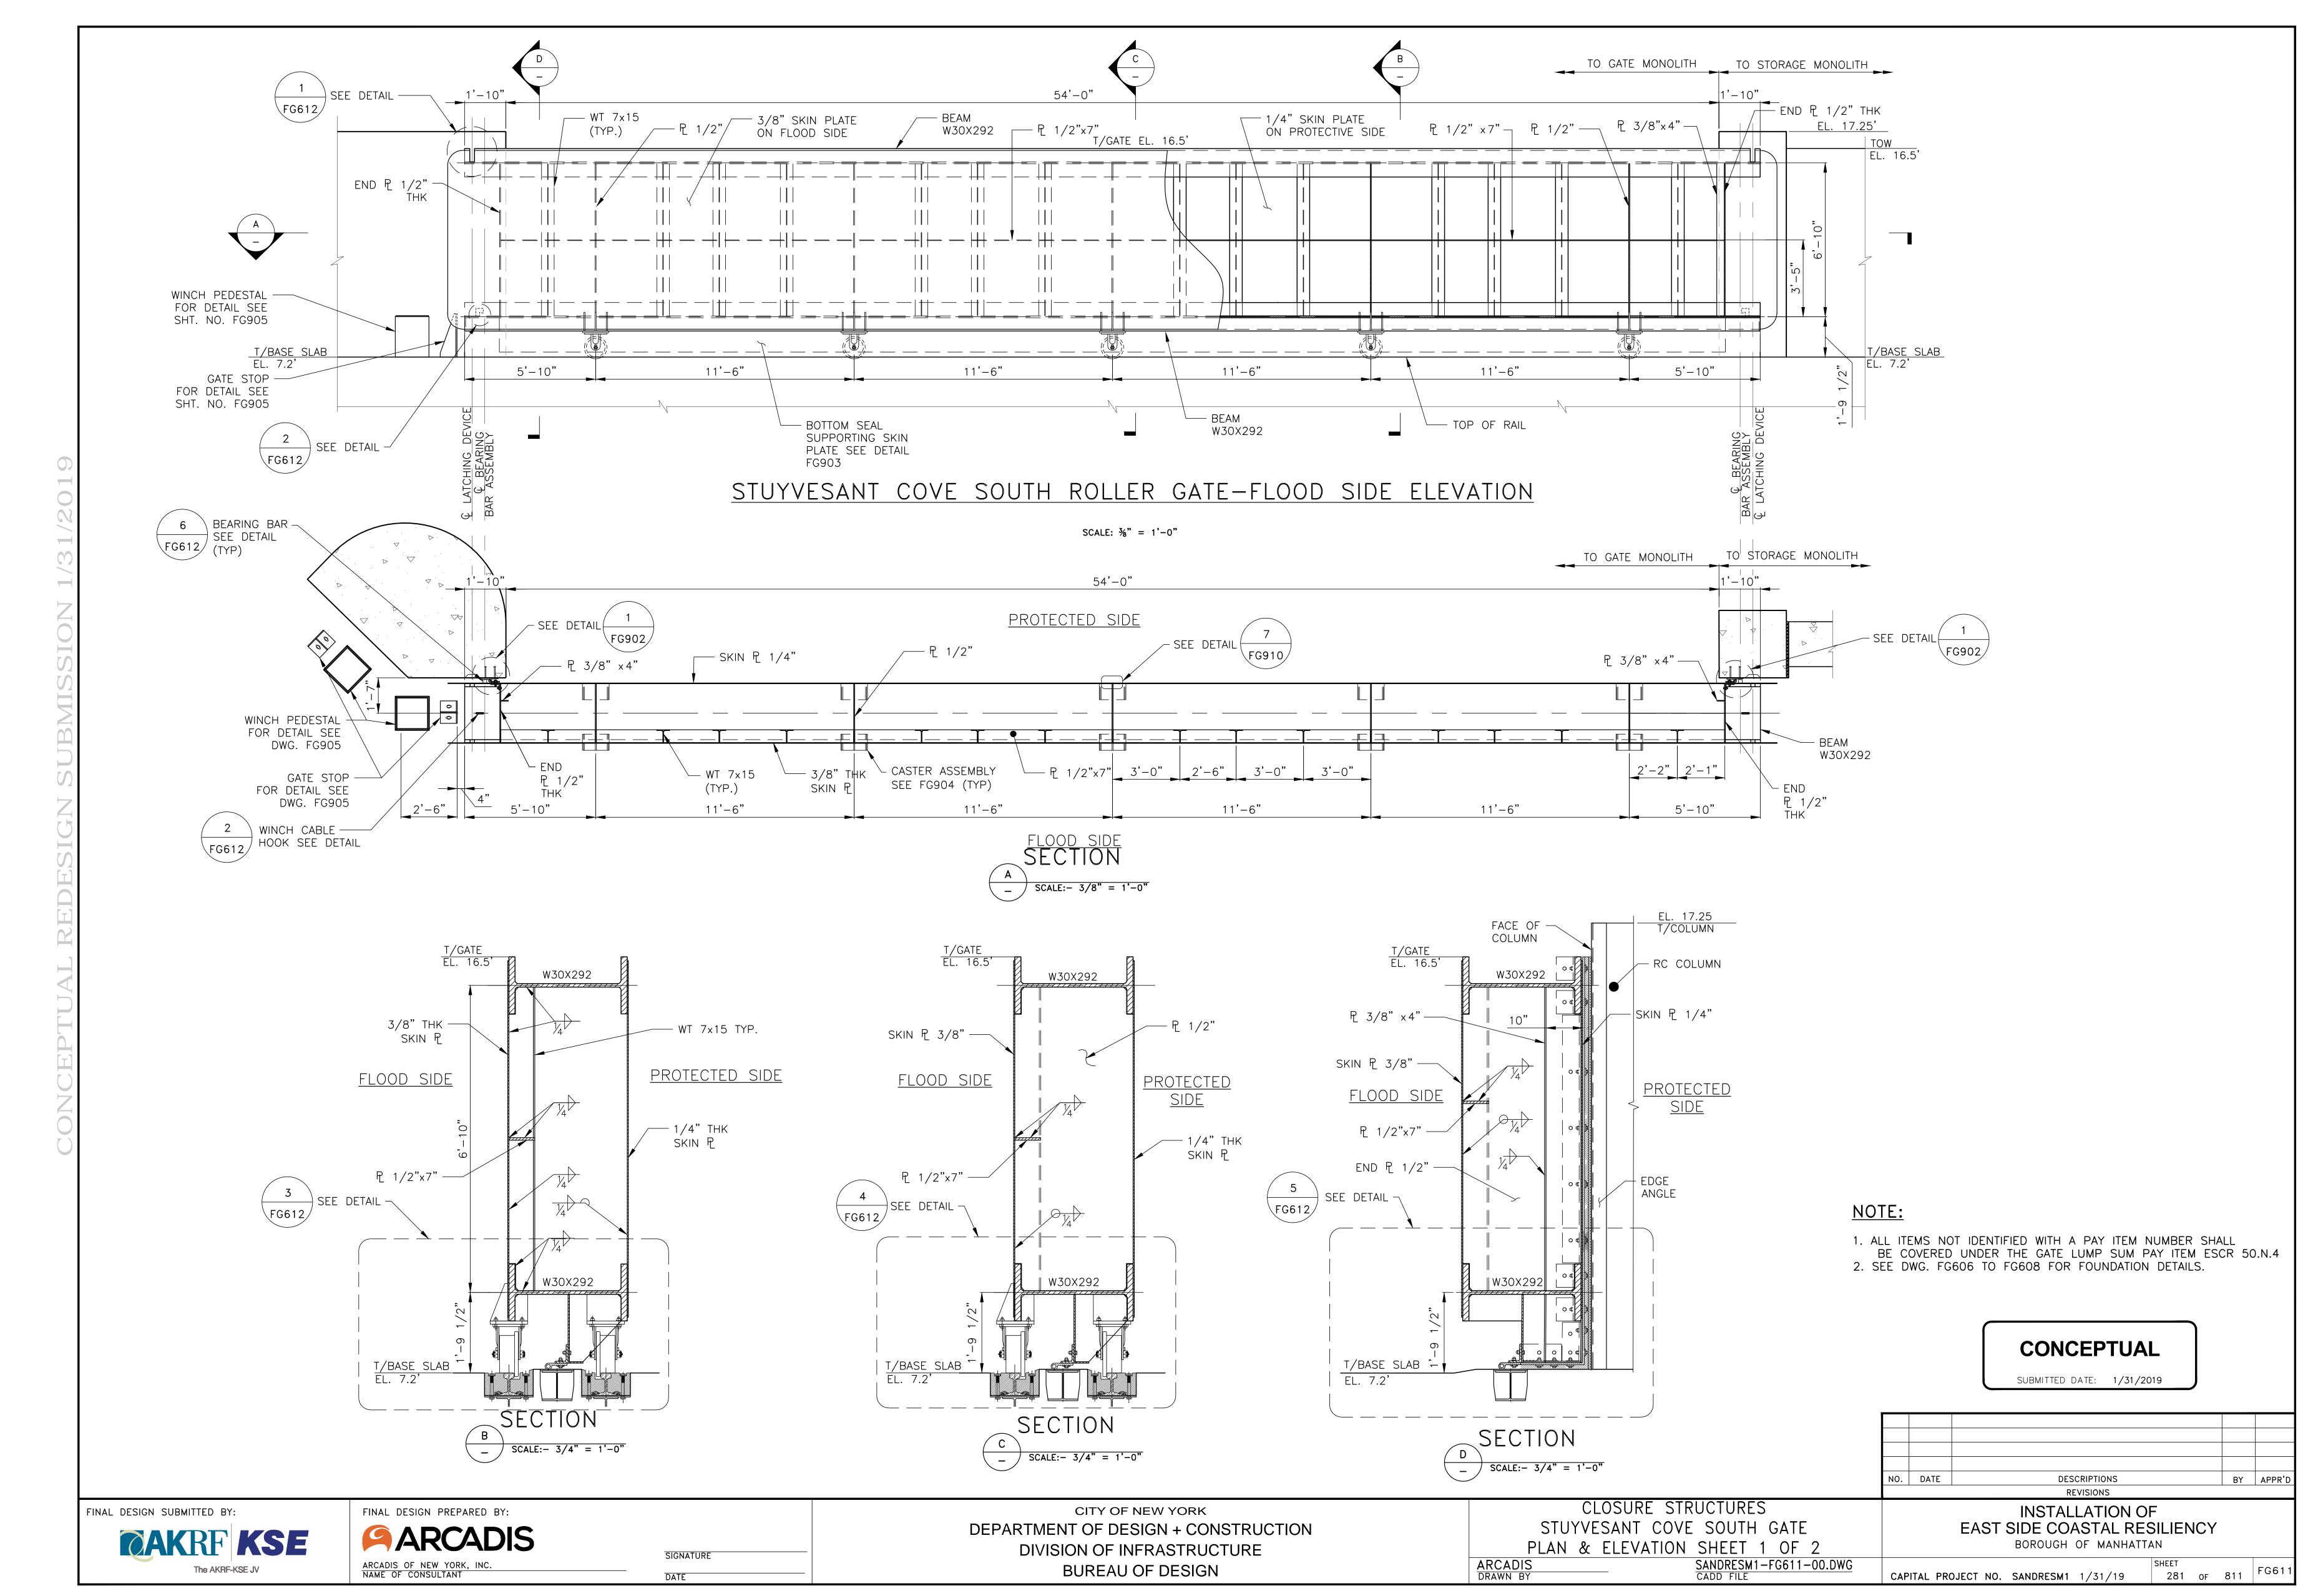

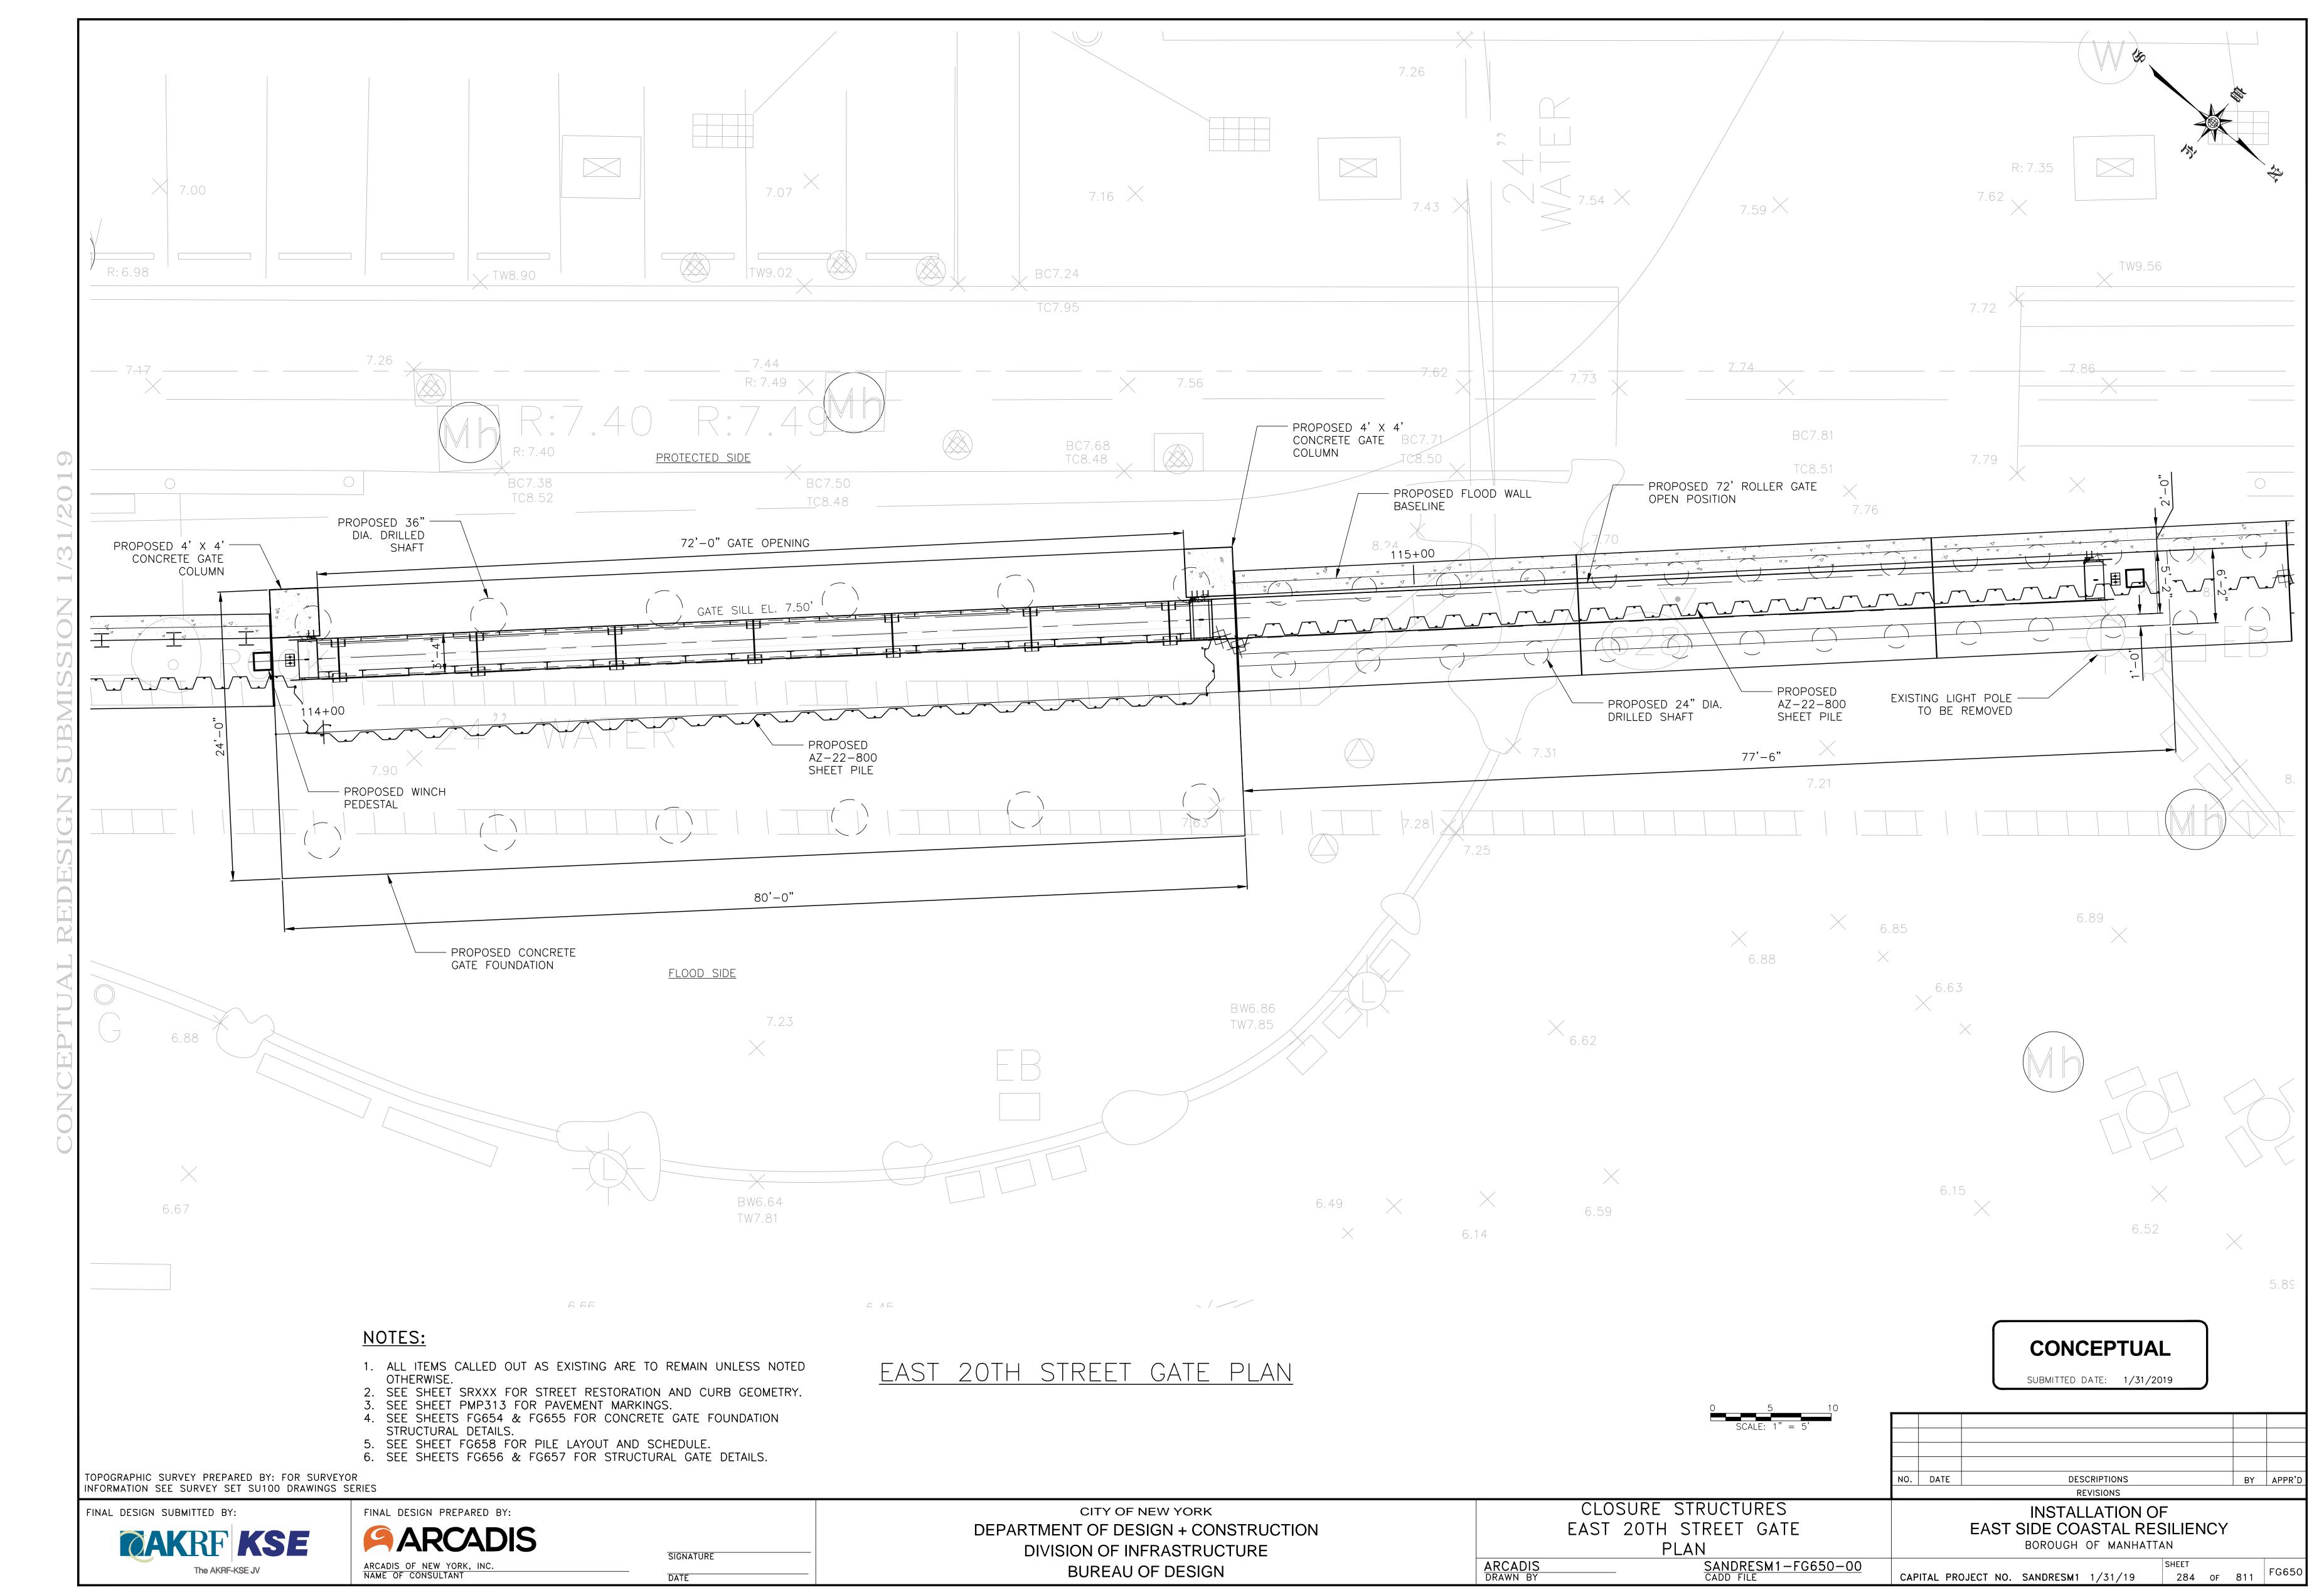

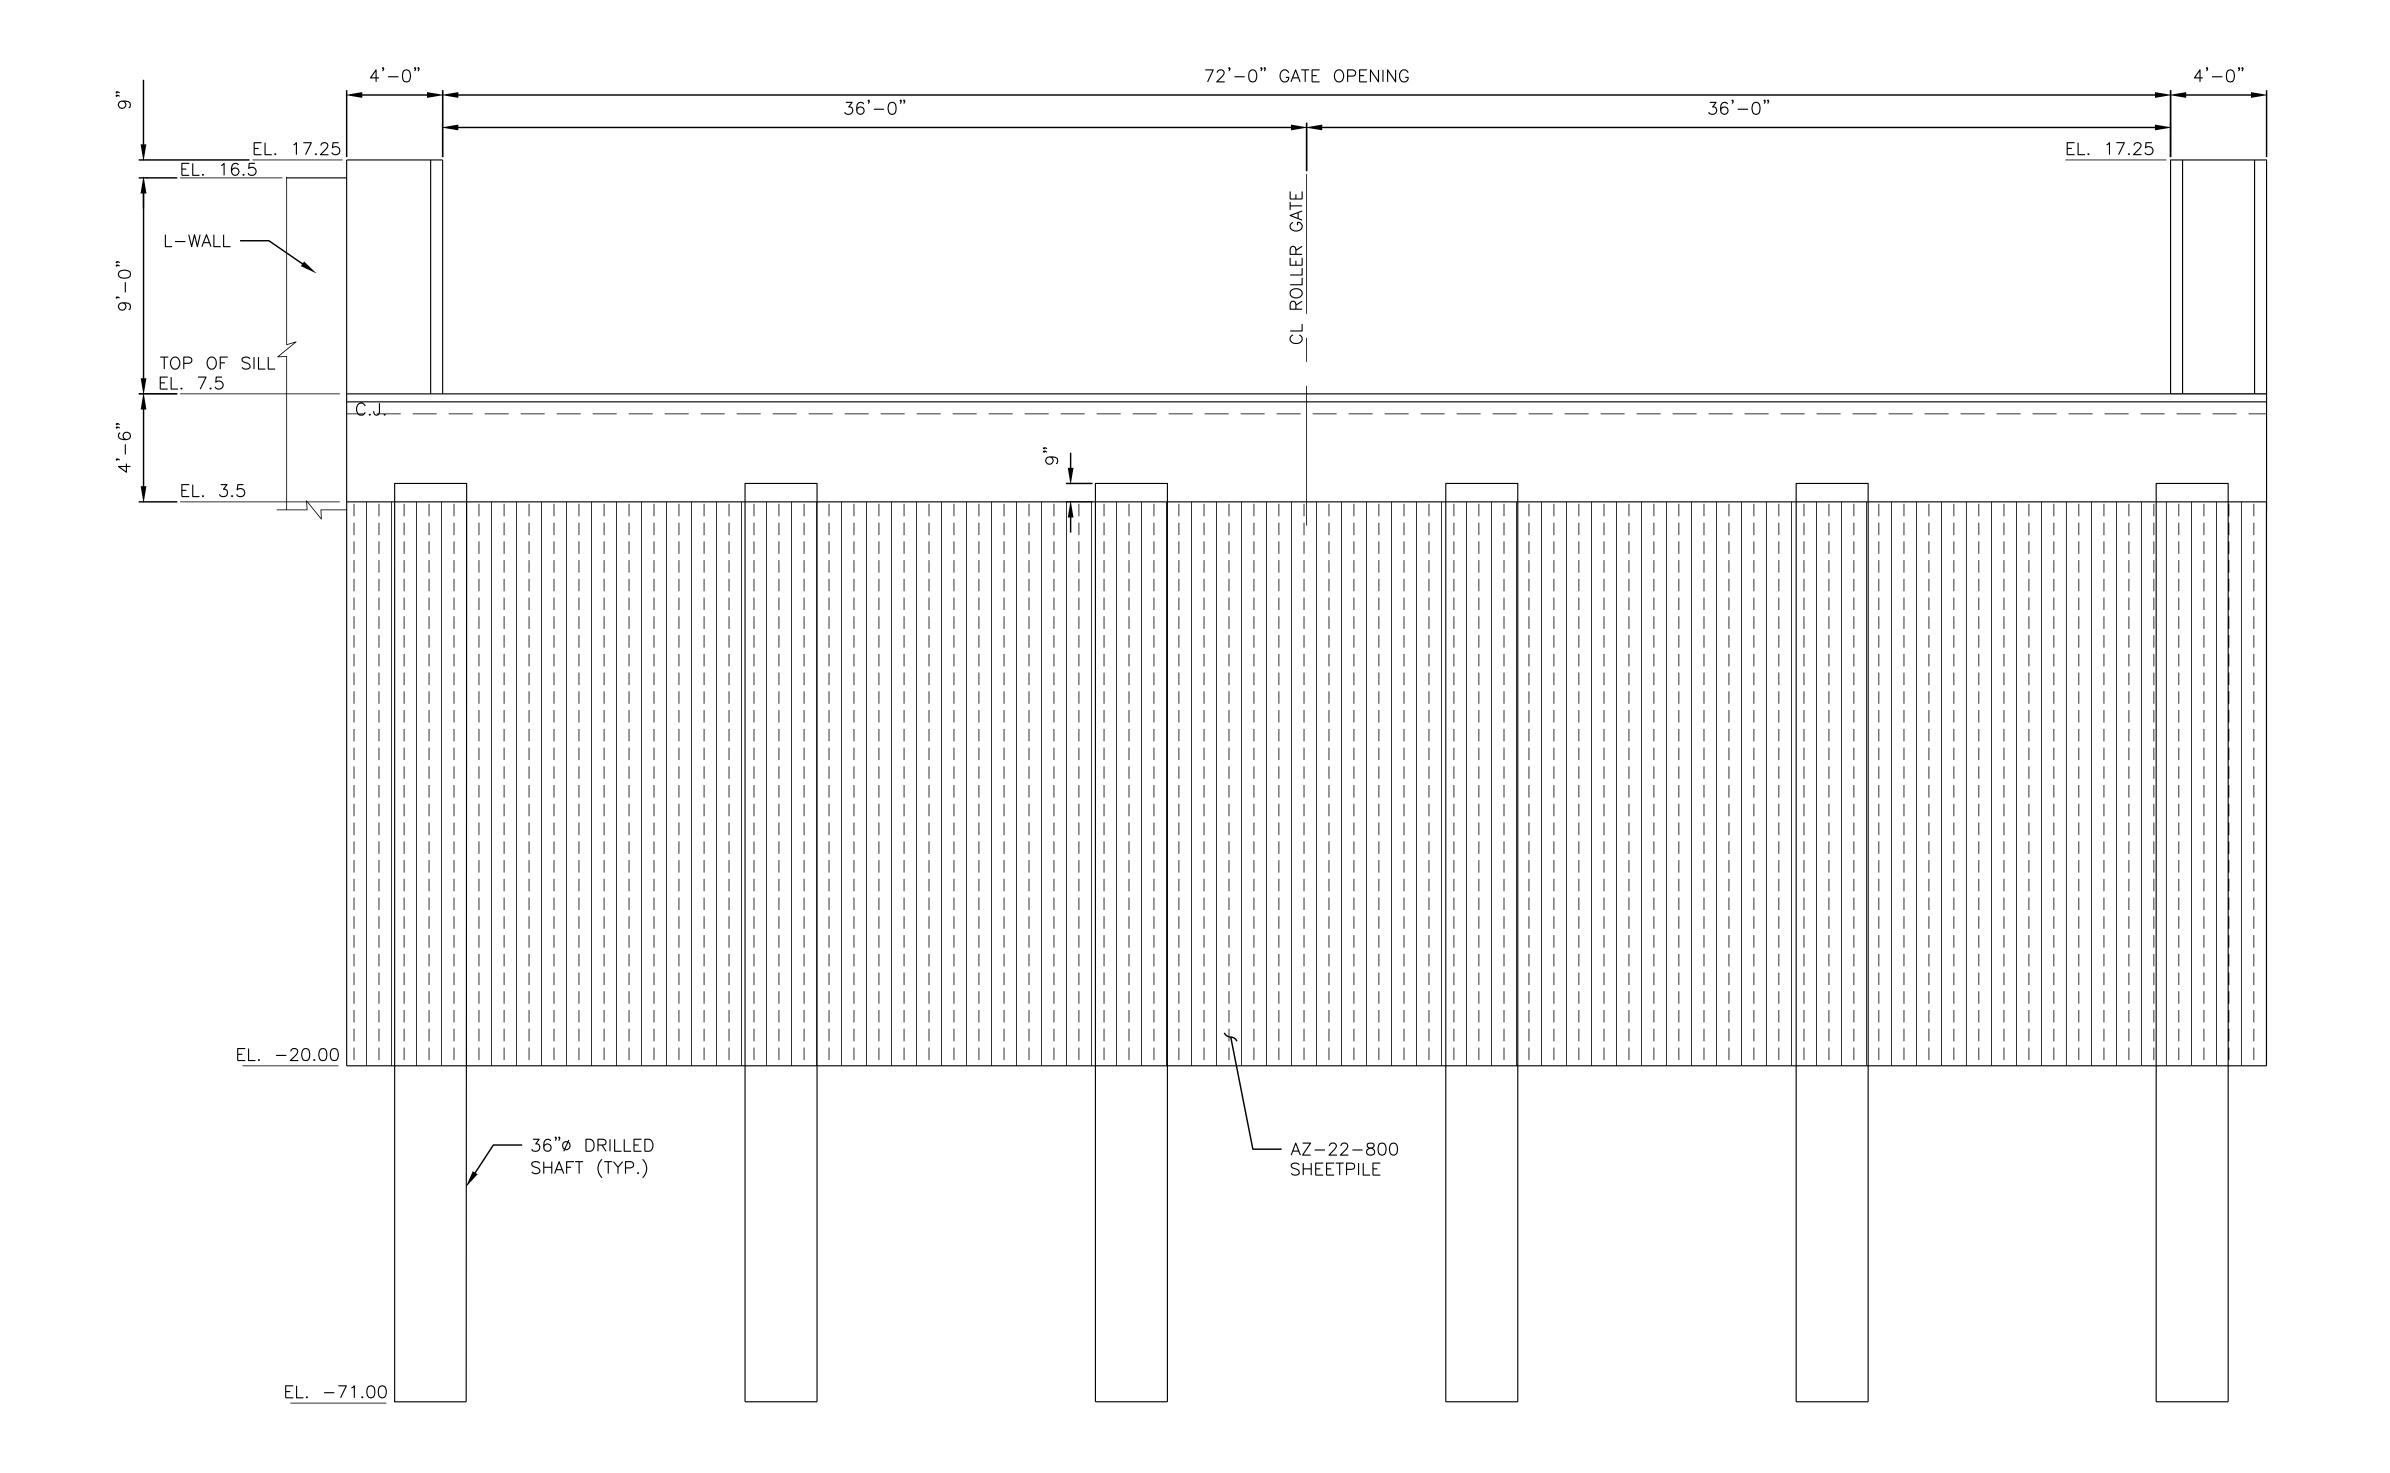

SECTION THROUGH EAST 20TH STREET GATE

FG650 SCALE 1/4" = 1'-0"

CONCEPTUAL

SUBMITTED DATE: 1/31/2019

DESCRIPTIONS

TOPOGRAPHIC SURVEY PREPARED BY: FOR SURVEYOR INFORMATION SEE SURVEY SET SU100 DRAWINGS SERIES FINAL DESIGN SUBMITTED BY:

CAKRF KSE

FINAL DESIGN PREPARED BY: **ARCADIS** ARCADIS OF NEW YORK, INC.
NAME OF CONSULTANT

SIGNATURE DATE

CITY OF NEW YORK DEPARTMENT OF DESIGN + CONSTRUCTION DIVISION OF INFRASTRUCTURE **BUREAU OF DESIGN**

CLOSURE STRUCTURES

ARCADIS EAST 20TH STRUCTURES

CLOSURE STRUCTURES

ARCADIS EAST 20TH STRUCTURES

REVISIONS **INSTALLATION OF** EAST SIDE COASTAL RESILIENCY BOROUGH OF MANHATTAN CAPITAL PROJECT NO. SANDRESM1 1/31/19 285 OF 811 FG651

DATE

ELEVATION

BY APPR'C

