

The current proposal is:

Preservation Department – Item 6, LPC-23-03513

51-53 East 73rd Street – Upper East Side Historic District Borough of Manhattan

To testify virtually, please join Zoom

Webinar ID: 864 9888 2944

Passcode: 903125

By Phone: 1 646-558-8656 US (New

York) 877-853-5257 (Toll free) US

888 475 4499 (Toll free)

Note: If you want to testify virtually on an item, join the Zoom webinar at the agenda's "Be Here by" time (about an hour in advance). When the Chair indicates it's time to testify, "raise your hand" via the Zoom app if you want to speak (*9 on the phone). Those who signed up in advance will be called first.

51-53 E 73RD STREET

Architect of Record: Mike House, AIA


Design: RAAD Studio

Structural: Silman Engineering

SOE: Bilow Engineering


Preservation: Wist Preservation Associates

URBAN CONTEXT

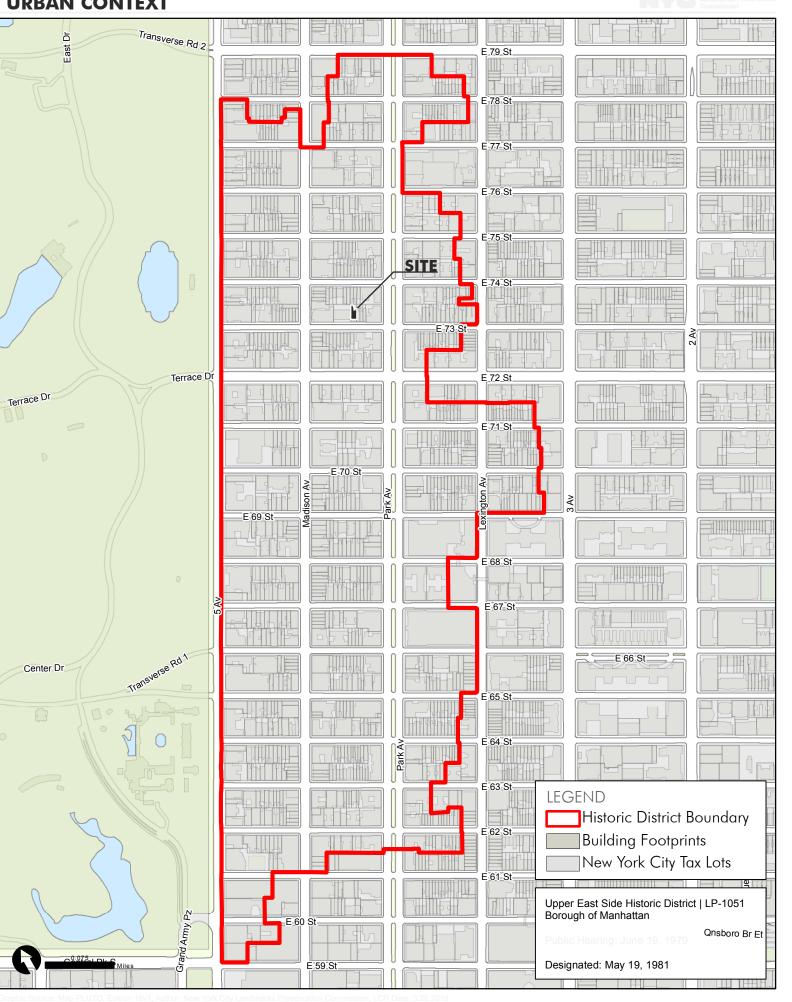






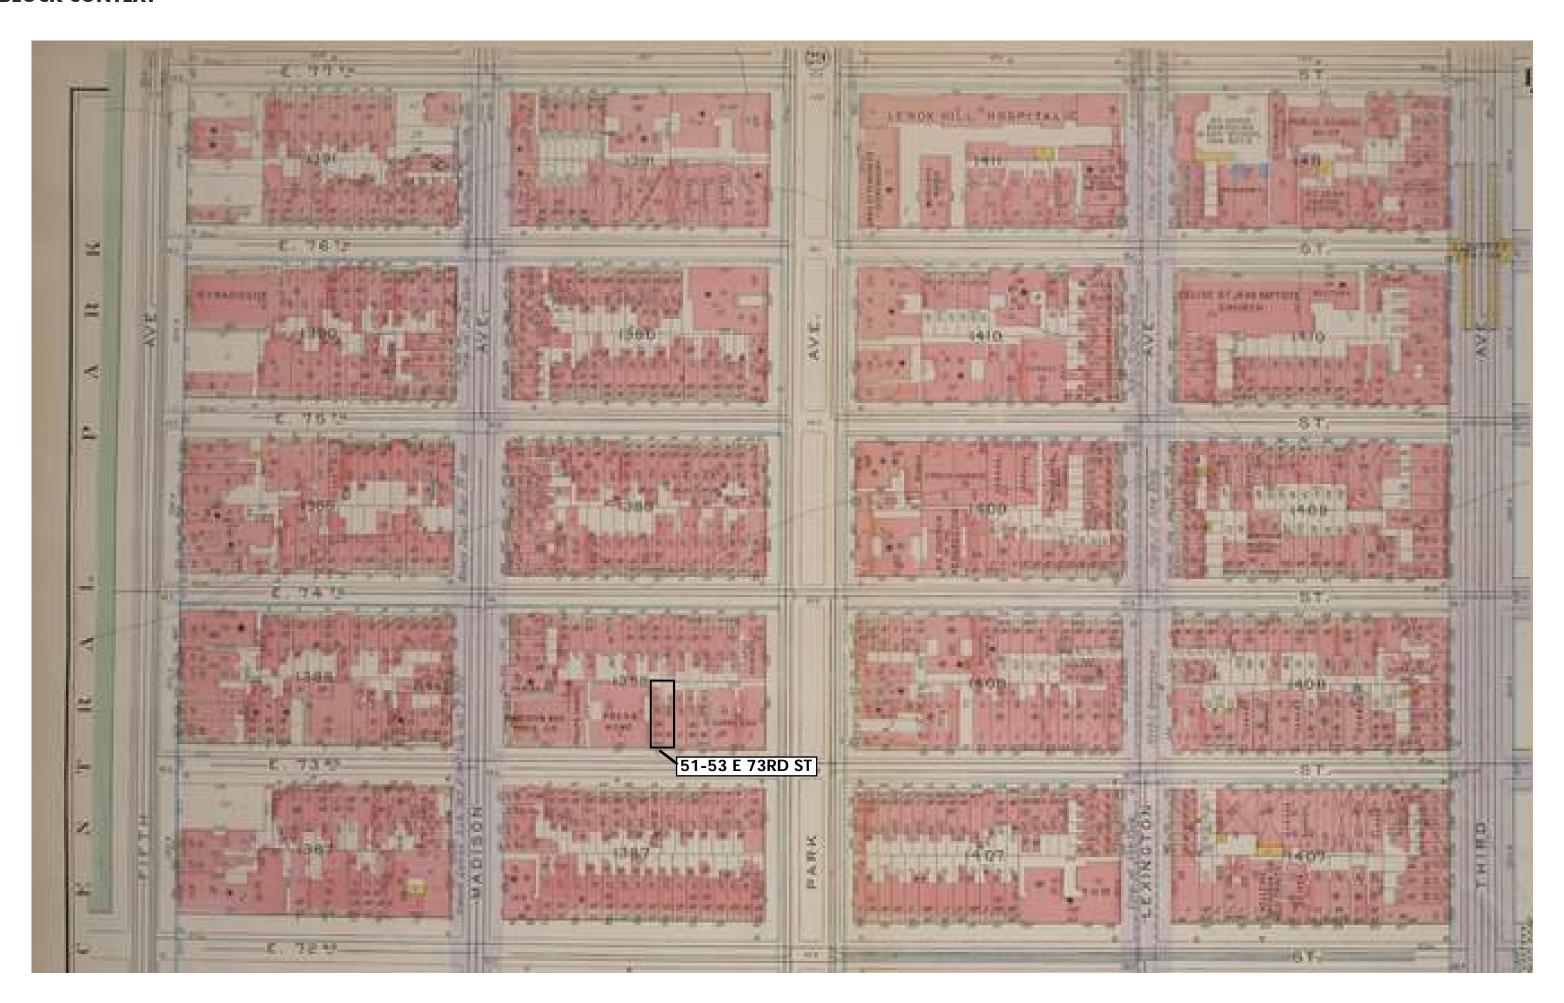


FACADE STYLES

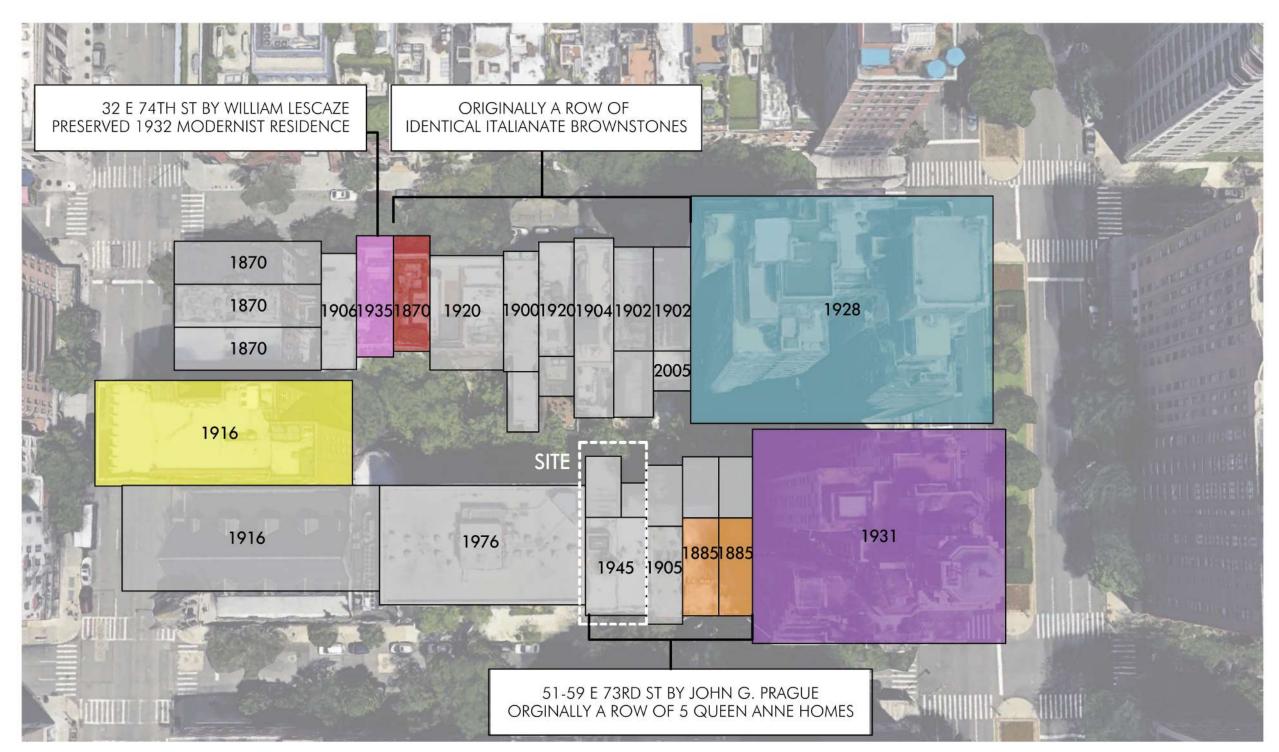


BUILT 1870



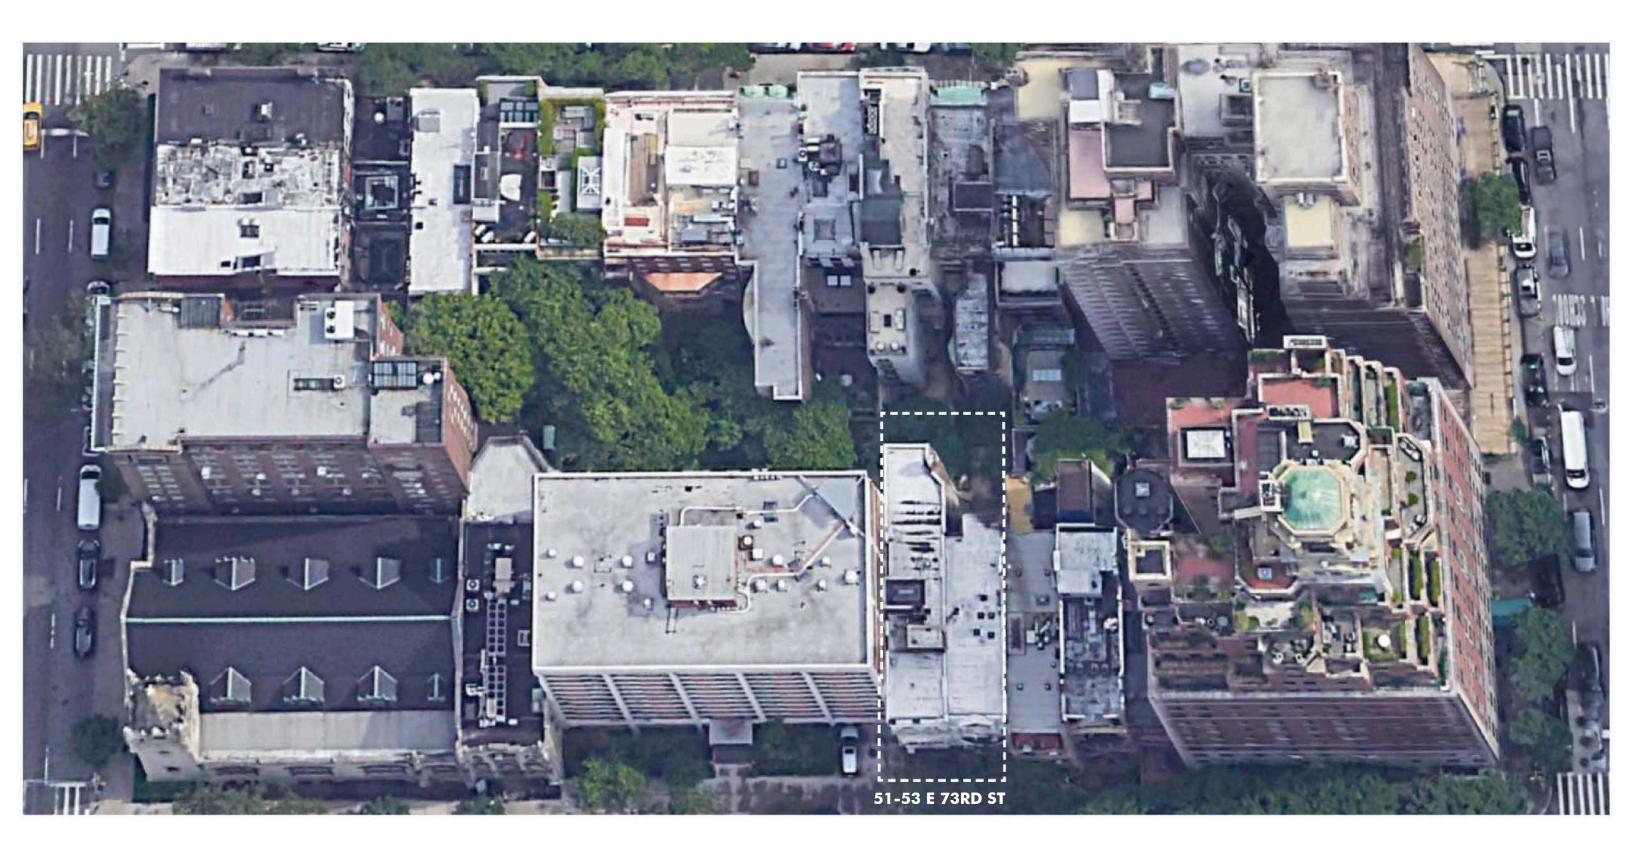

CHRONOLOGICAL CONTEXT




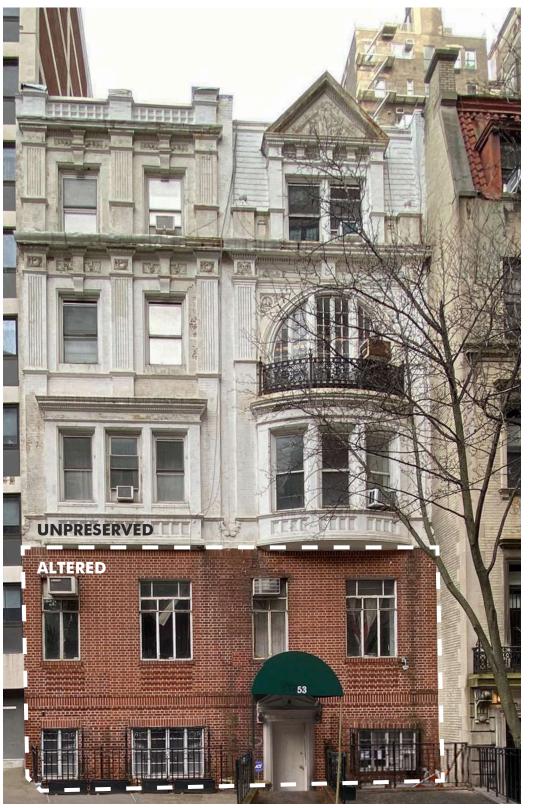



ORIGINAL - 1885 PRESENT PROPOSED

NEARBY TOWNHOME COMBINATIONS

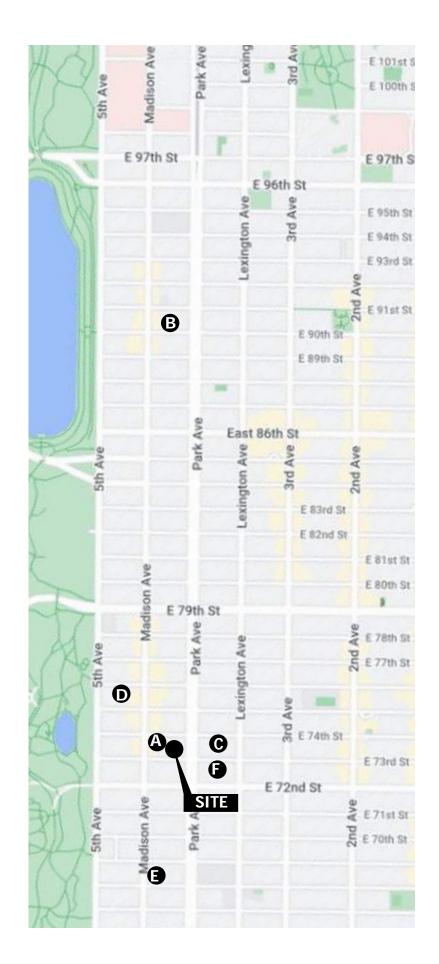



A: 36 - 38 EAST 74TH STREET COMBINED 1920 & 1948



B: 57 - 61 EAST 90TH STREET COMBINATION APPROVED BY LPC



C: 134 - 136 EAST 74TH STREET COMBINED 1930



D: 9 - 13 EAST 75TH STREET COMBINATION APPROVED BY LPC



E: 823 - 825 MADISON AVE COMBINED 1926



F: 128 - 130 EAST 73RD STREET COMBINED 1928

PROPOSED WORK


- I. FACADE RESTORATION INCLUDING THE REMOVAL OF THE 1945 ALTERED BRICK BASE AND THE INSTALLATION OF A HISTORICAL DETAILED MASONRY BASE THAT INCLUDES THE HISTORIC STOOP AT 53 EAST 73RD ST.
- II. RECONFIGURED AND REDESIGNED REAR FACADE WITH LANDSCAPING
- III. ROOFTOP PENTHOUSE ADDITION (NOT VISIBLE FROM ANY PUBLIC WAY)



I. FRONT FACADE

CHRONOLOGICAL CONTEXT



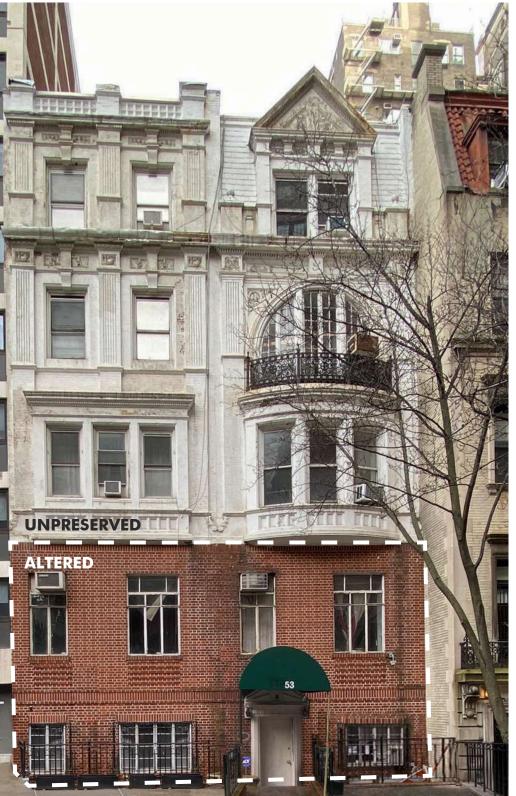



ORIGINAL - 1885 PRESENT PROPOSED

11





1 EXISTING EXTERIOR ELEVATION - FRONT
| SCALE: 1/8" = 1'-0"

2 PROPOSED EXTERIOR ELEVATION - FRONT

SCALE: 1/8" = 1'-0"



DESIGN DETAILS

MATERIALS



Brownstone-Tinted Stucco Base, Painted with Light Paint



Slate Roof




Mahogany Door



Black Accents

FACADE MATERIAL & COLOR ANALYSIS

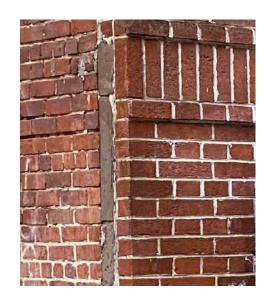

Brownstone Behind Brick at Base



Paint Colors on Front Facade

HISTORICAL FACADE REFERENCE



Wooden Door and Stone Crest



Double Hung Window



Dog-Leg Stoop

MASONRY DETAILS



Circular Stoop Window




Building Intersection




Detail at Windows


ENTRY DETAILS

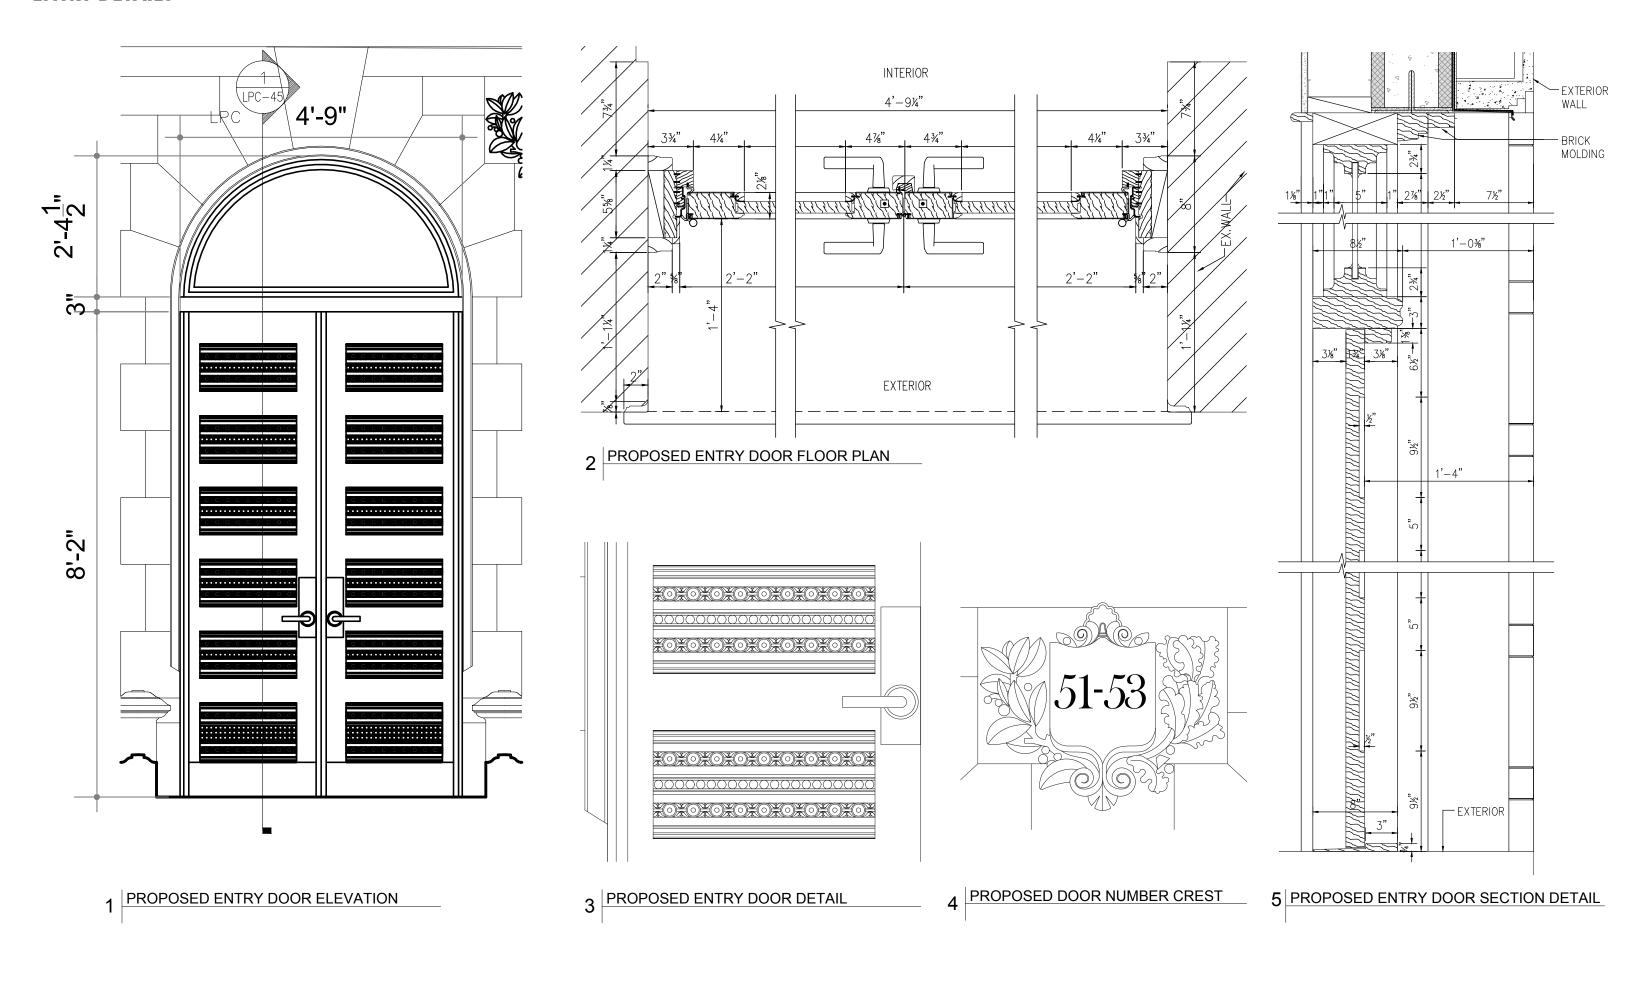

WINDOW DETAILS

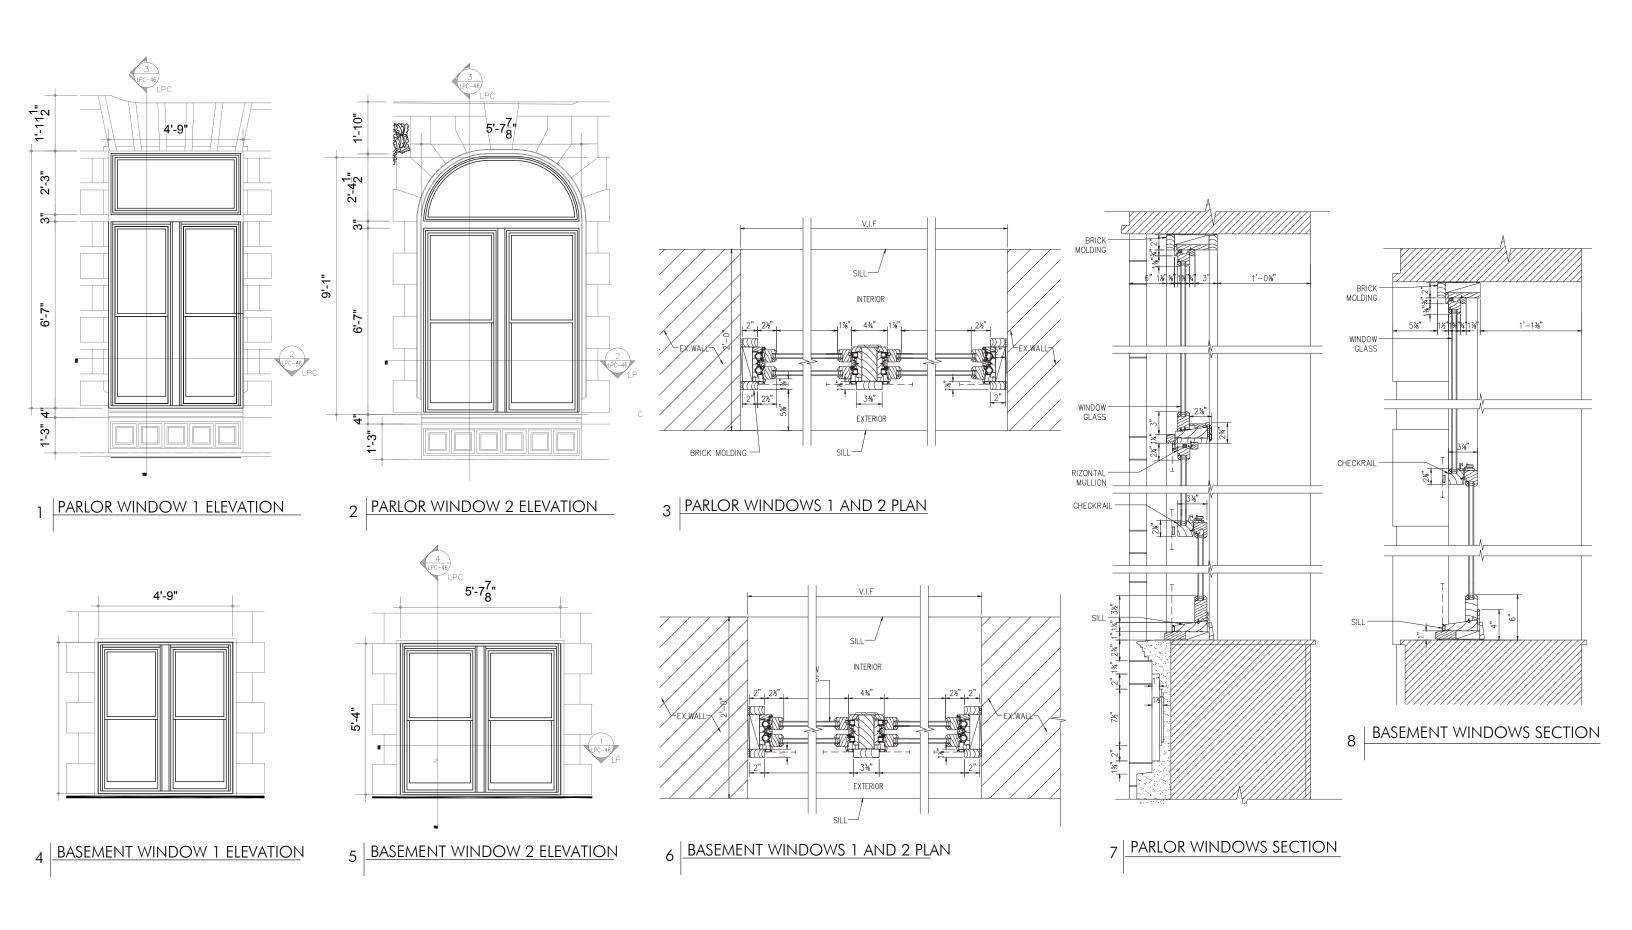

EXISTING CONDITIONS

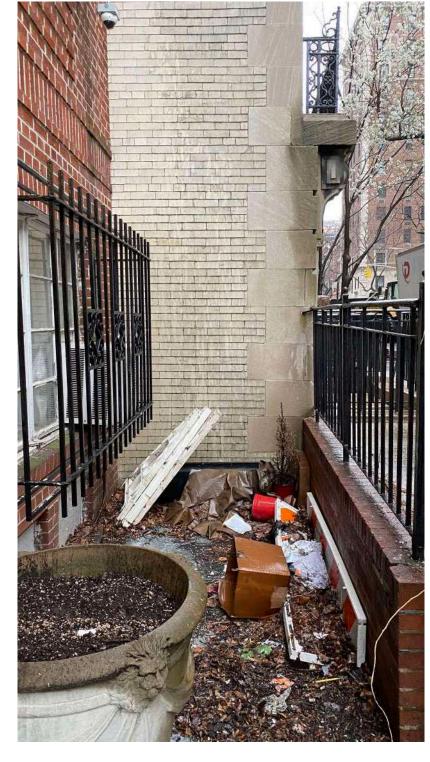


TRASH AND DEBRIS GATHERING AT CURRENT ENTRY




CURRENT ENTRY AND RIGHT OF WAY



REMAINING STUMP IN TREE PIT

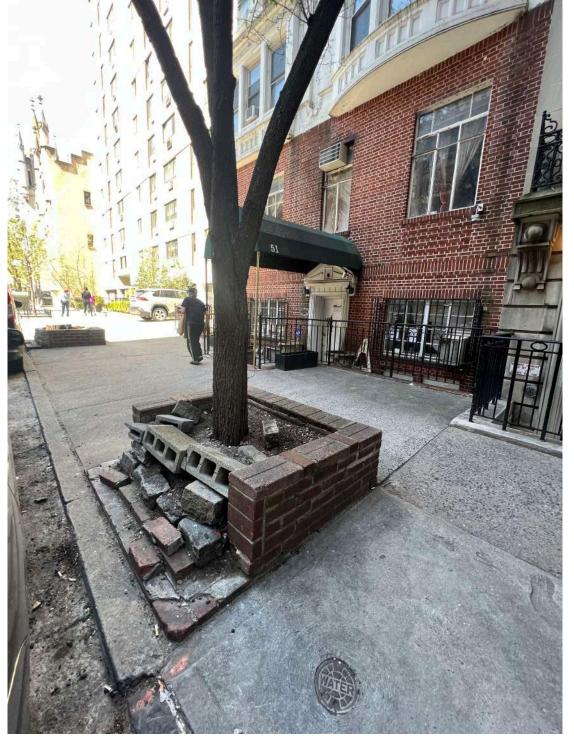

DAMAGED TREE PIT AND TREE

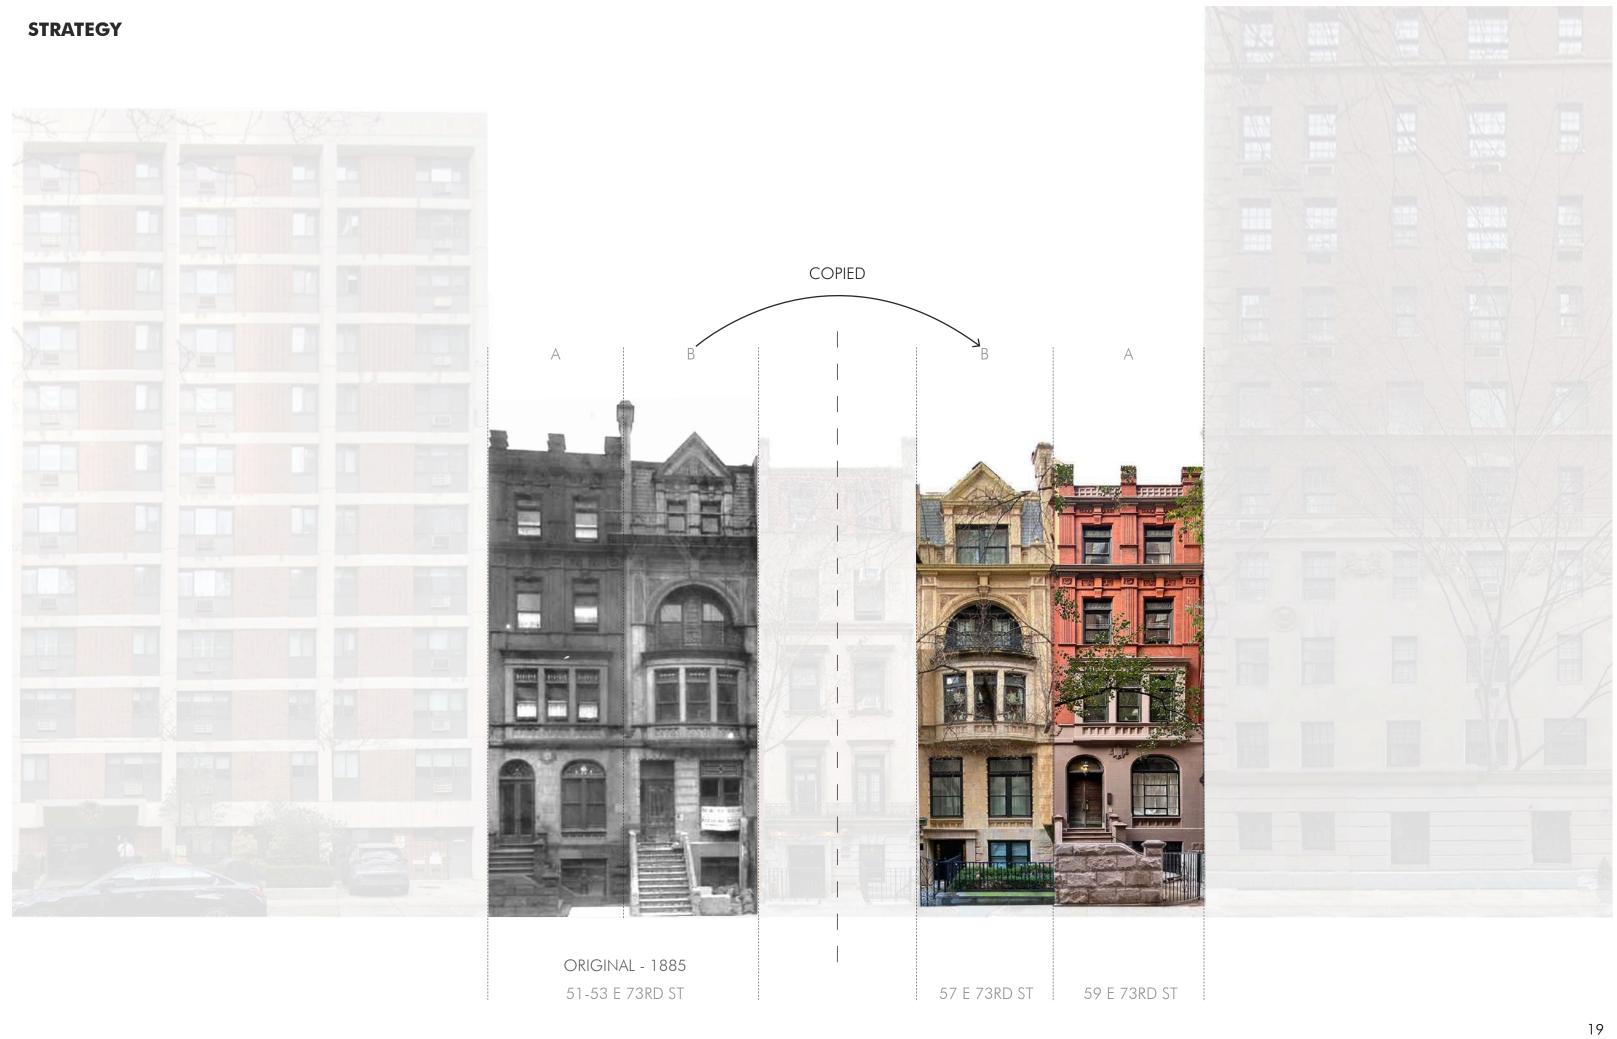




STOOP & ENTRY DESIGN






PROPOSED ENTRY RESTORATION

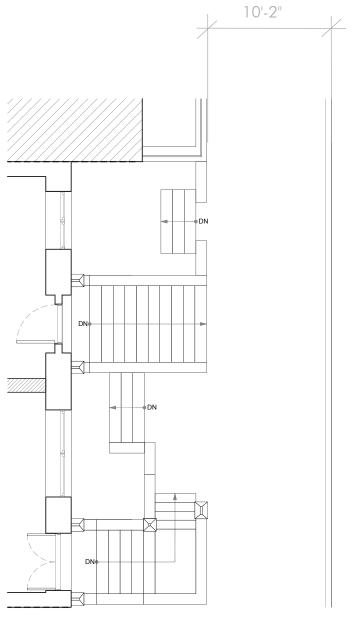

Original Entry 1885

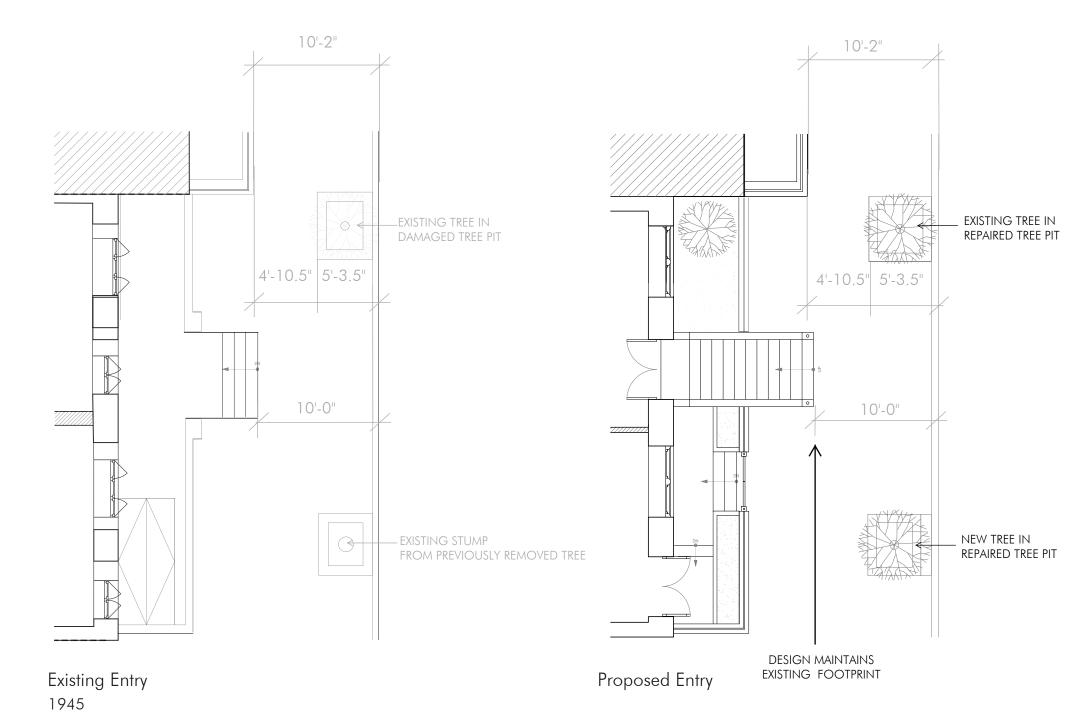

FRONT FACADE DESIGN



II. REAR FACADE


REAR EXISTING CONDITIONS







REAR AREA IMAGES

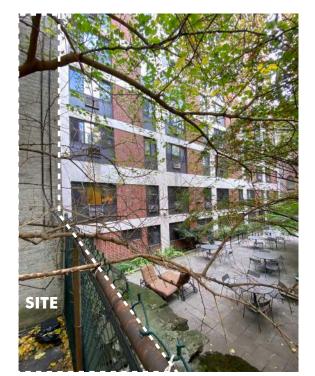






49 E 73RD - YARD DROPS 13'-6" BELOW 55 E 73RD - YARD DROPS 10'-5" BELOW VARIED REAR YARD HEIGHTS AND CONDITIONS WITHIN BLOCK

FACADE STYLES

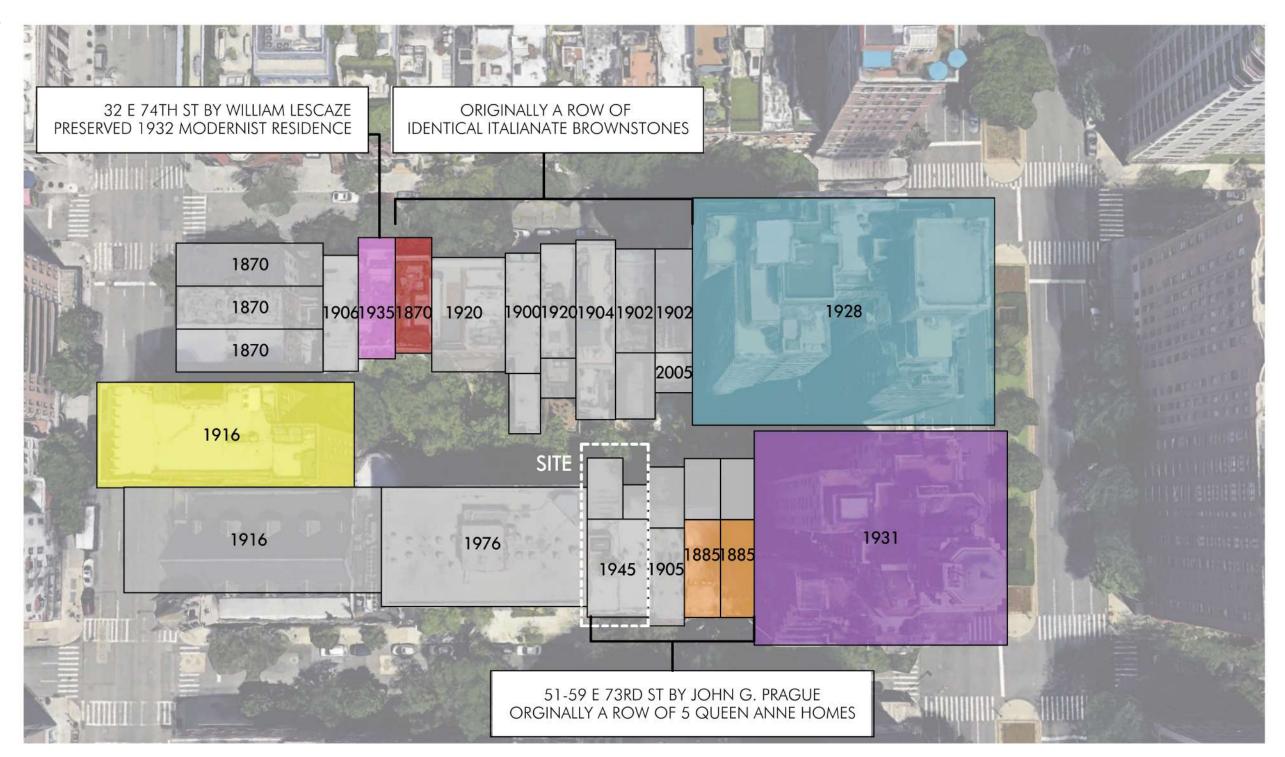

BUILT 1870






32 E 74TH ST BY WILLIAM LESCAZE







"Lescaze hoped to link the aesthetics of the modern movement to a **frank display of new technologies**. In his town house, the new technologies primarily consisted of **load-bearing glass** brick on the exterior and air conditioning on the interior. At the same time, these new technologies were integrated into a building that **retained key features of the historic building type**." - The Society of Architectural Historians on William Lescaze

LANDSCAPE PRECEDENTS

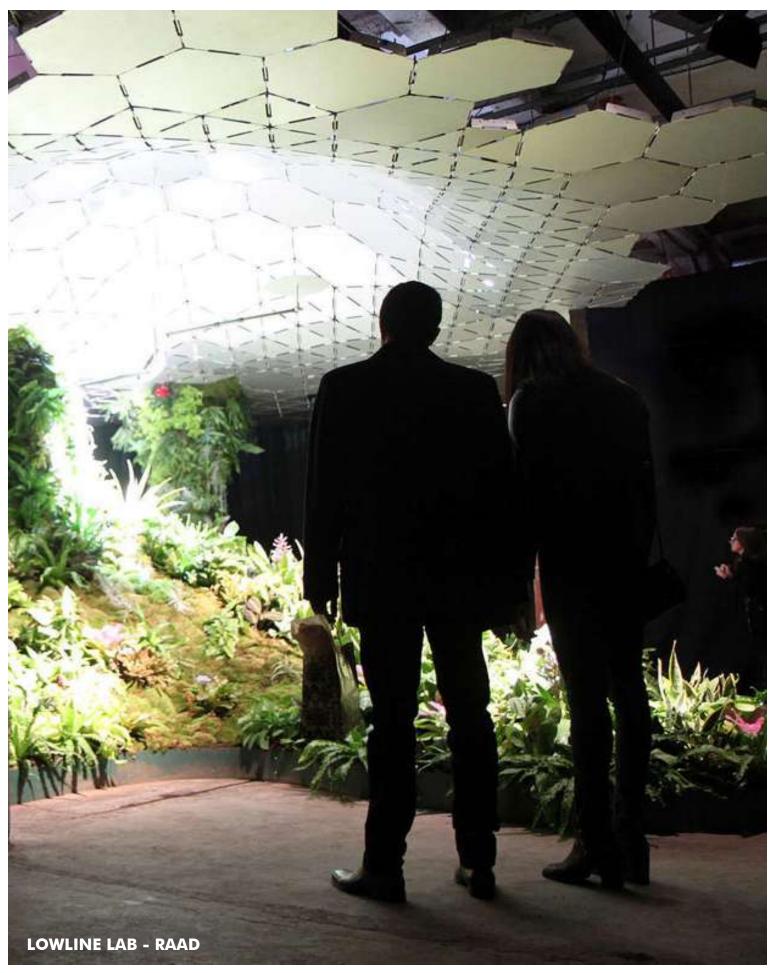

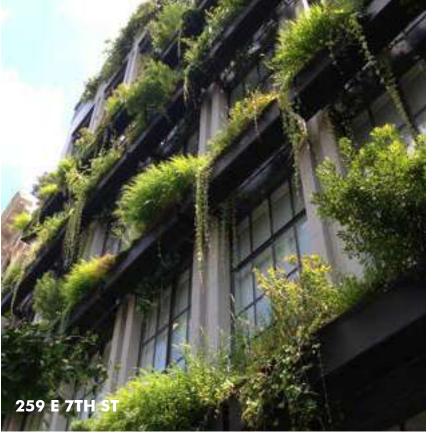


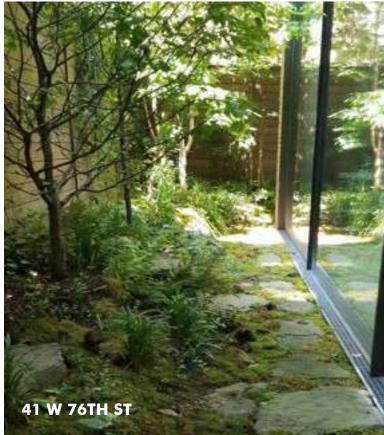



RAAD STUDIO PRECEDENTS




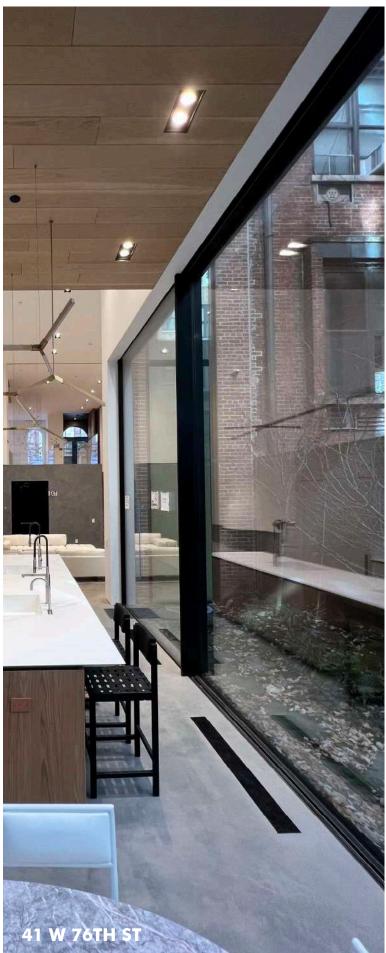






REAR FACADE DESIGN

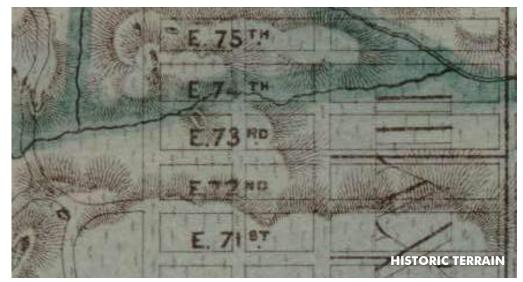

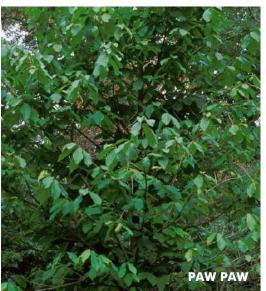










REAR AXONS



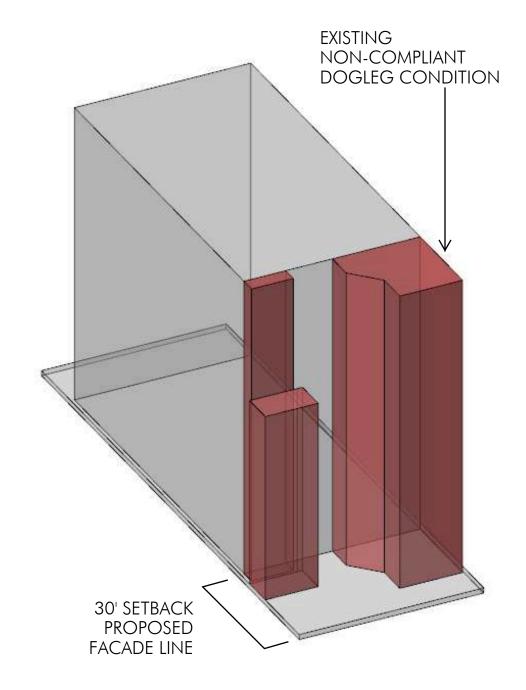


REAR AXON VIEW

MASSING REDUCTION DIAGRAM

REAR FACADE DESIGN



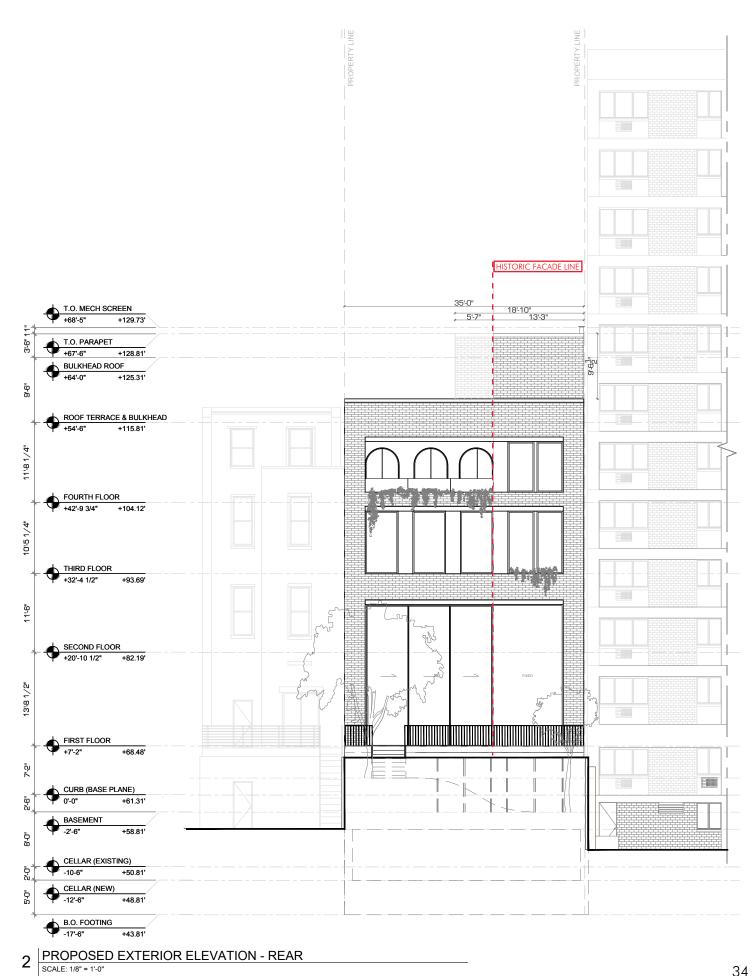



1 EXISTING EXTERIOR ELEVATION - REAR SCALE: 1/8" = 1'-0"




III. PENTHOUSE & ROOFTOP

PROPOSED SECTION & SIGHT LINE DIAGRAM

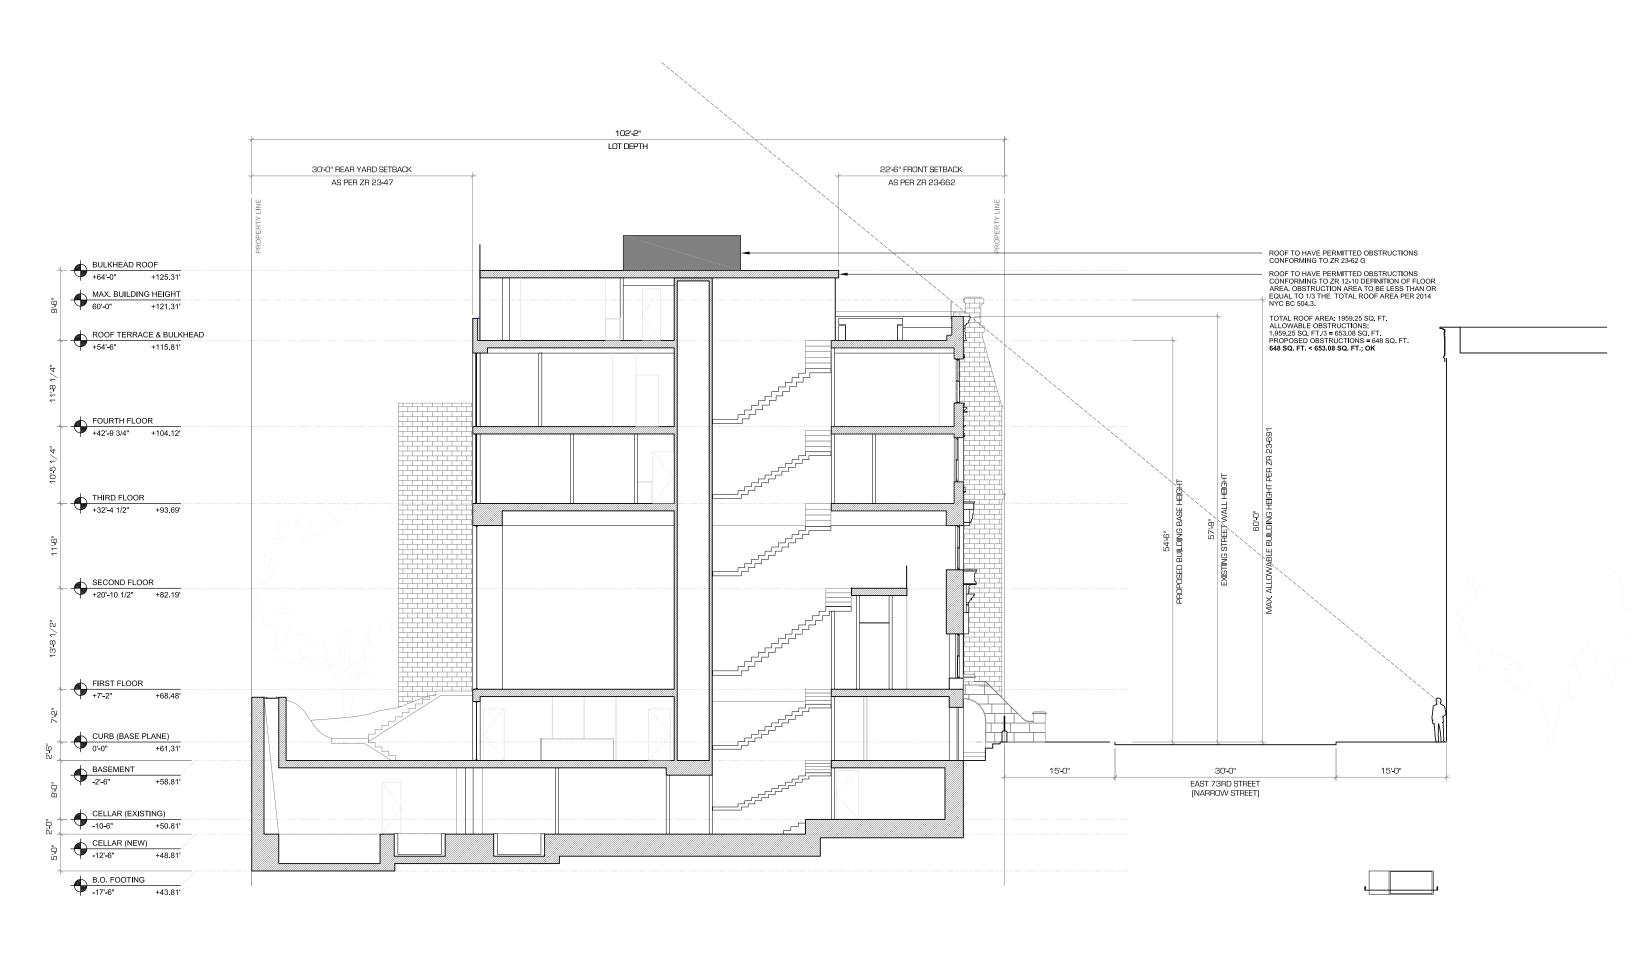


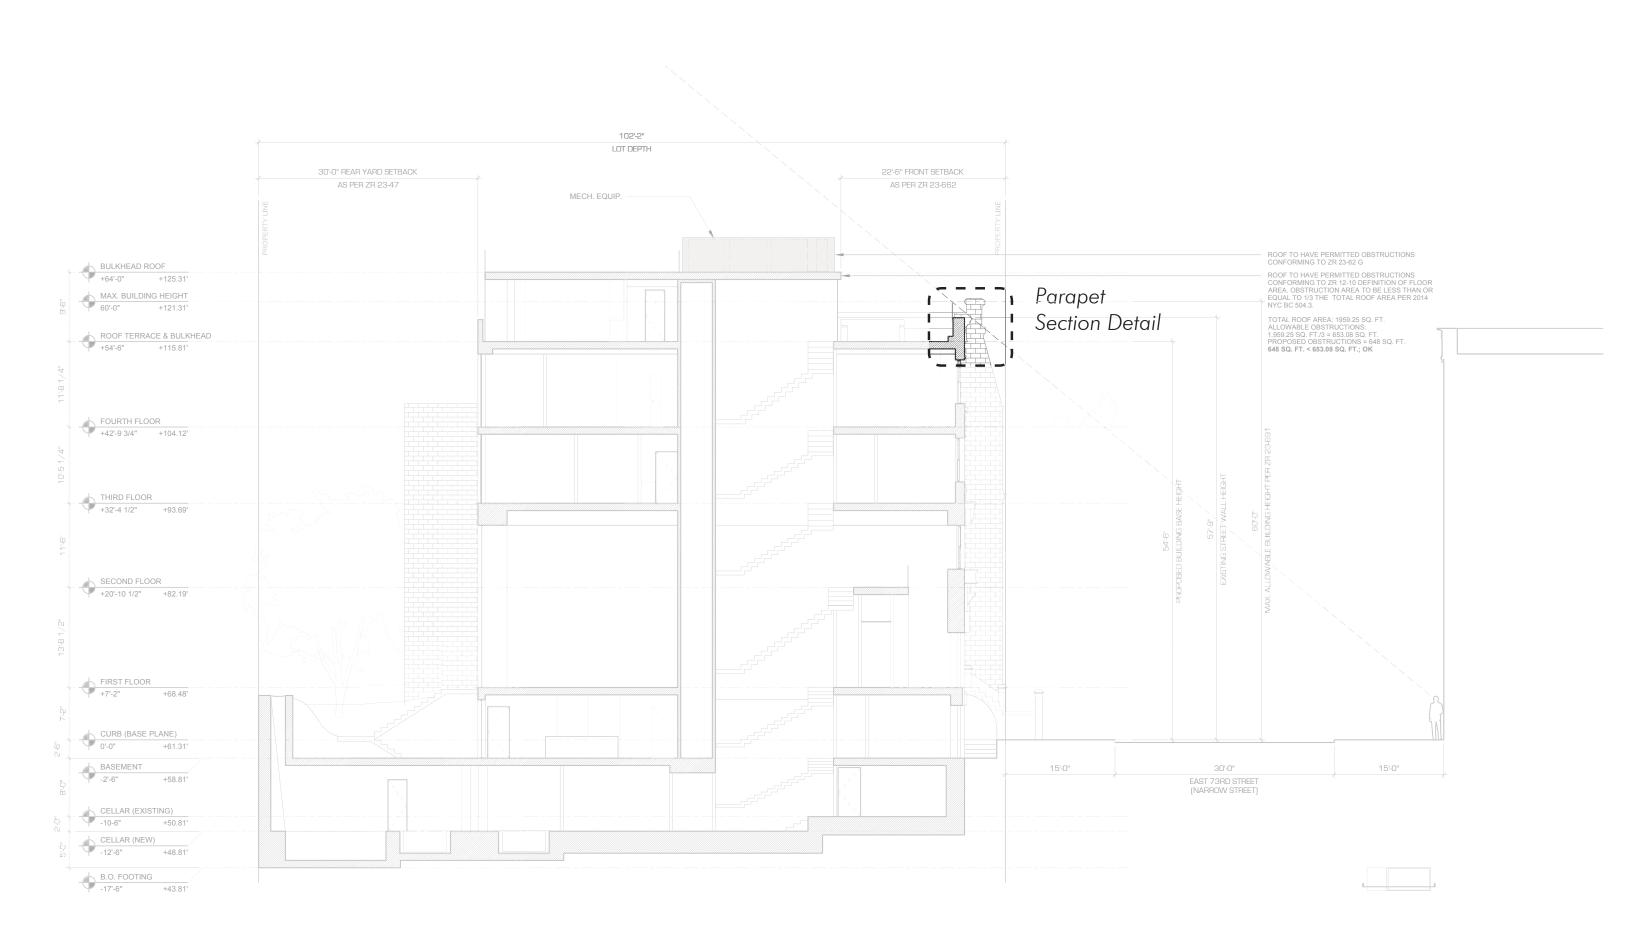

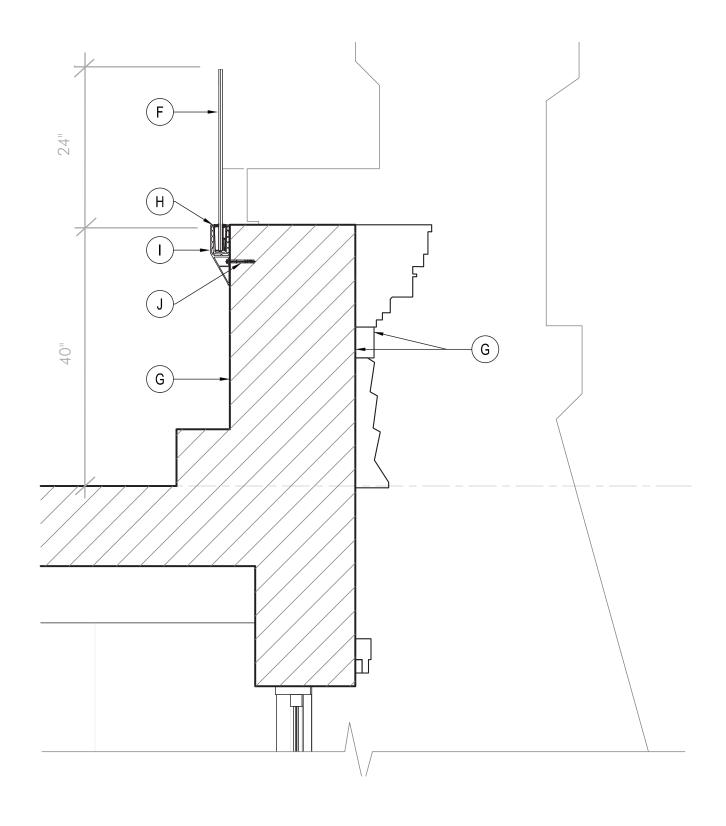


NEW GLASS HANDRAIL ON EXISTING PARAPET


- F NEW ANTI REFLECTING COATING LOW IRON GLASS RAIL
- G EXISTING PARAPET & EXTERIOR WALL TO REMAIN RUBBER-SET,
- (H) BASE, INLAY, DISC, RUBBER
- Y-PROFILE EASY GLASS PRIME
- J ANCHOR

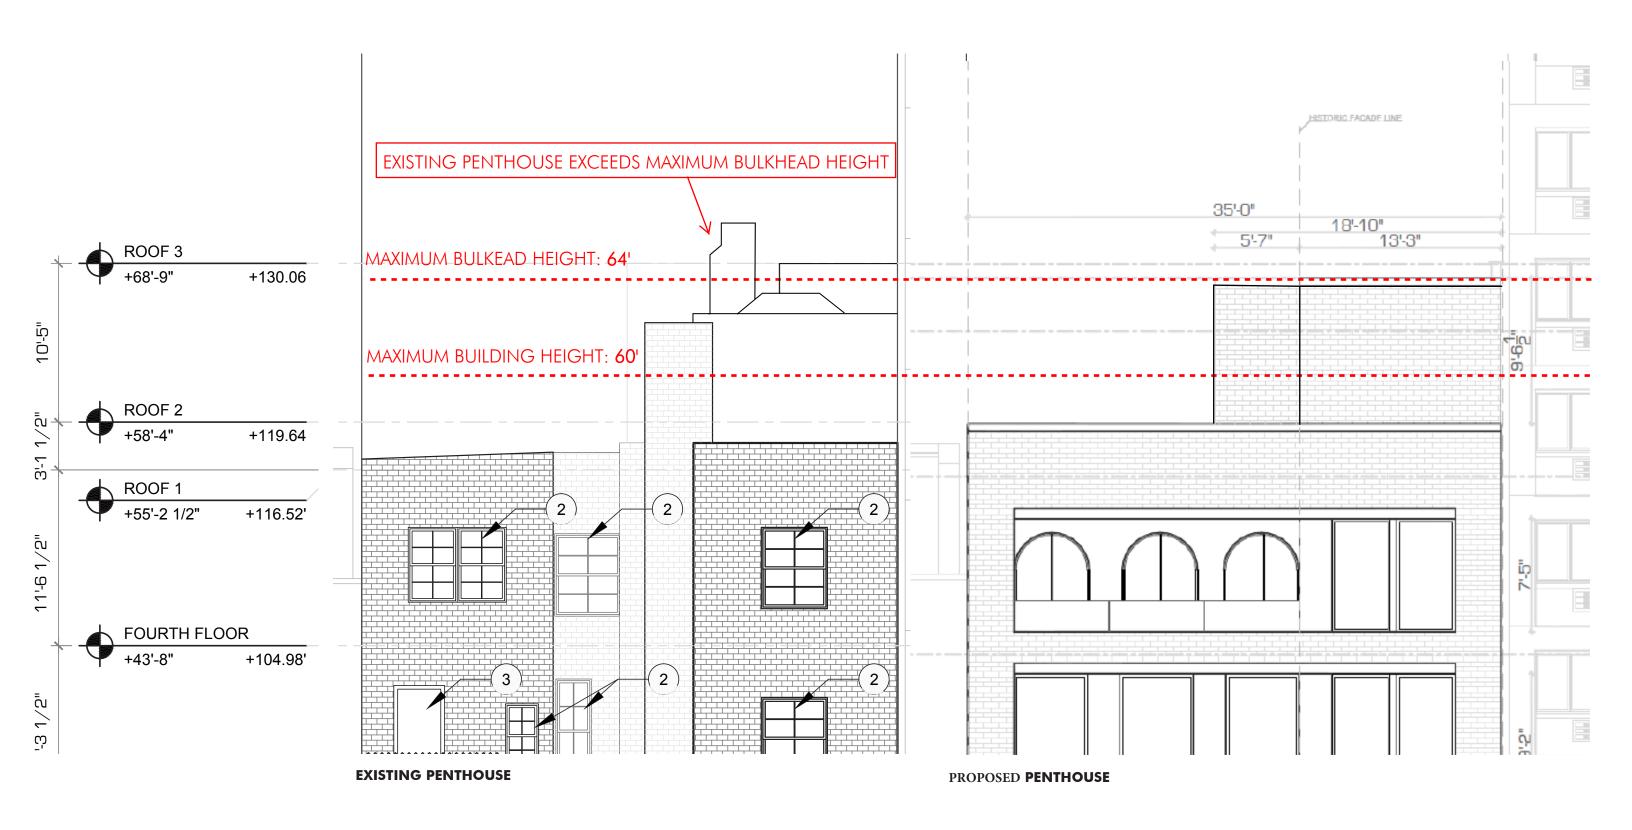

ROOF PLAN - EXISTING VS. PROPOSED

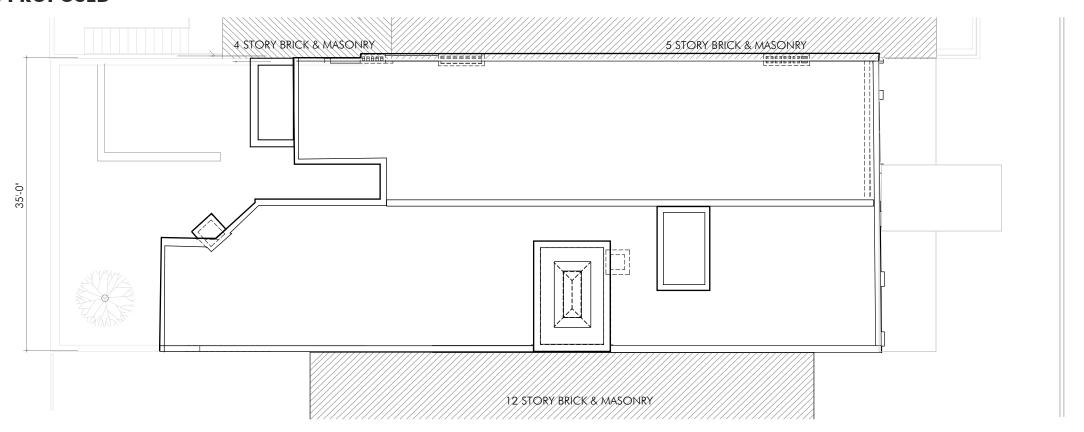

1 EXISTING ROOF PLAN

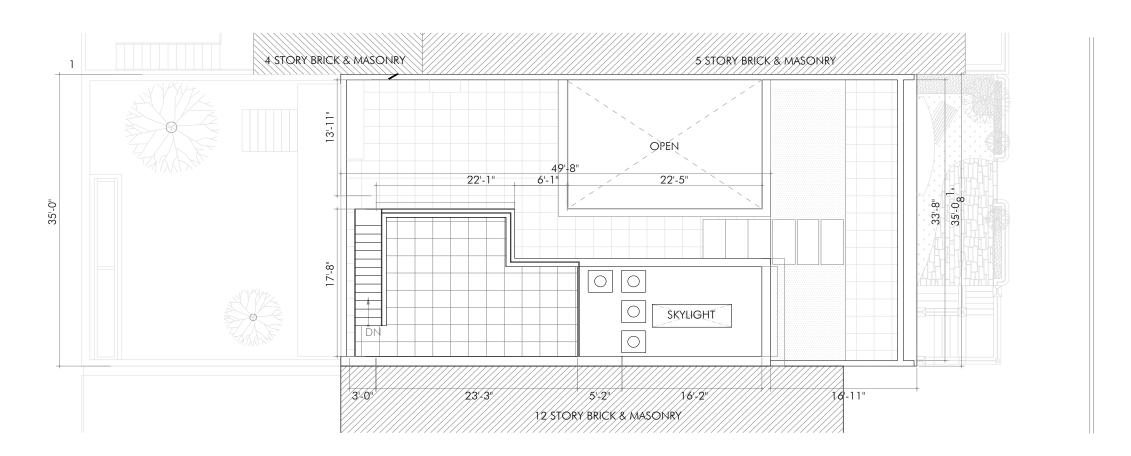

PENTHOUSE MOCK-UP VISIBILITY



VIEW A - NOT VISIBLE Madison Avenue looking Southeast




VIEW C - NOT VISIBLE Madison Avenue looking East




VIEW B - NOT VISIBLE
Park Avenue looking Southwest



VIEW D - NOT VISIBLE Madison Avenue looking West

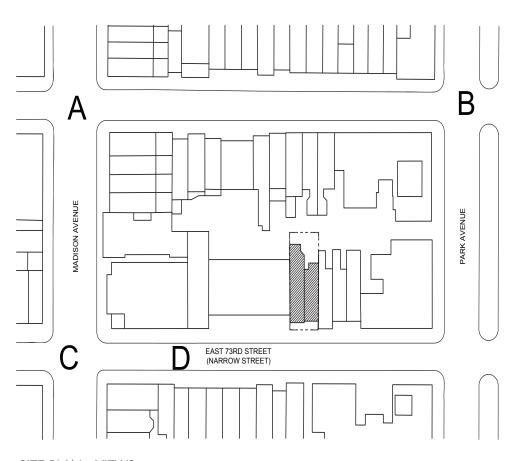


SITE PLAN - VIEWS

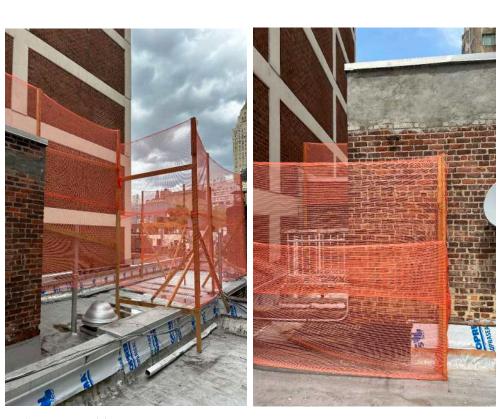

PENTHOUSE MOCK-UP Invisible from Street



APPENDIX

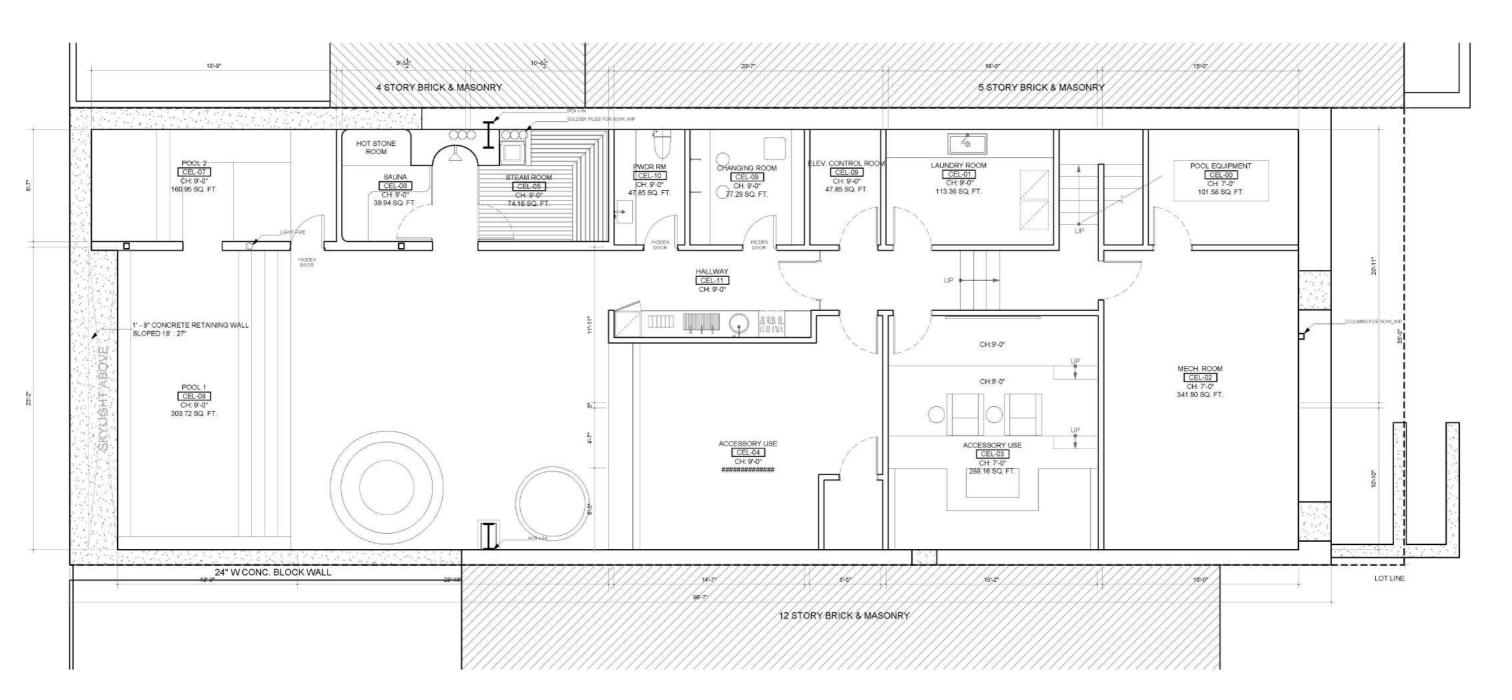

CELLAR FLOOR PLAN

1 PROPOSED CONSTRUCTION FLOOR PLAN - CELLAR SCALE 1/4" = 1'-0"



CONSTRUCTION NOTES:

INSTALL NEW EXTERIOR WALLS PER EXTERIOR ENVELOPE DETAILS

INSTALL NEW WINDOWS PER WINDOW SCHEDULE & DETAILS

INSTALL NEW EXTERIOR DOORS PER DOOR SCHEDULES

INSTALL NEW ELEVATOR PER ELEVATOR MANUFACTURER SPECIFICATION & ELEVATOR DETAILS

INSTALL NEW NON-BEARING PARTITION WALLS PER PARTITION DETAILS

INSTALL NEW CUSTOM BUILT-IN MILLWORK

INSTALL NEW INTERIOR DOORS PER DOOR SCHEDULES

INSTALL NEW CONCRETE PAD ON GRADE TO RECEIVE NEW STAIR

NEW MASONRY OPENING WITH NEW STEEL LINTELS. SEE STRUCTURAL DWGS.

INSTALL NEW HARD-WIRED SMOKE/CARBON MONOXIDE DETECTOR #SC9120LBL, LISTED TO UL 217 & 2034 PER NYC 2014 BC 908.7.1.1.1

NEW CONCRETE SLAB ON GRADE. SEE STRUCTURAL DWGS.

NEW WD. FIN. STAIR W/ STEEL STRINGER. SEE A-XXX.00 & STRUCTURAL DWGS, FOR DTLS.

INSTALL NEW UTILITY SERVICE

INSTALL NEW 1-HR FIRE RATED ACCESS DOOR



EXISTING EXTERIOR WALL/PARTY WALL

CONSTRUCTION NOTE

CONSTRUCTION LEGEND:

SMOKE/ CARBON MONOXIDE DETECTOR, MOUNTED ON CEILING


SMOKE/ CARBON MONOXIDE DETECTOR, MOUNTED ON WALL

EXISTING EXTERIOR WALL, BEARING WALL OR PARTY WALL TO REMAIN

NEW NON-BEARING PARTITION WALL

NEW EXTERIOR WALL

NEW BEARING WALL (CMU WALL OR CAST-IN-PLACE CONCRETE WALL)

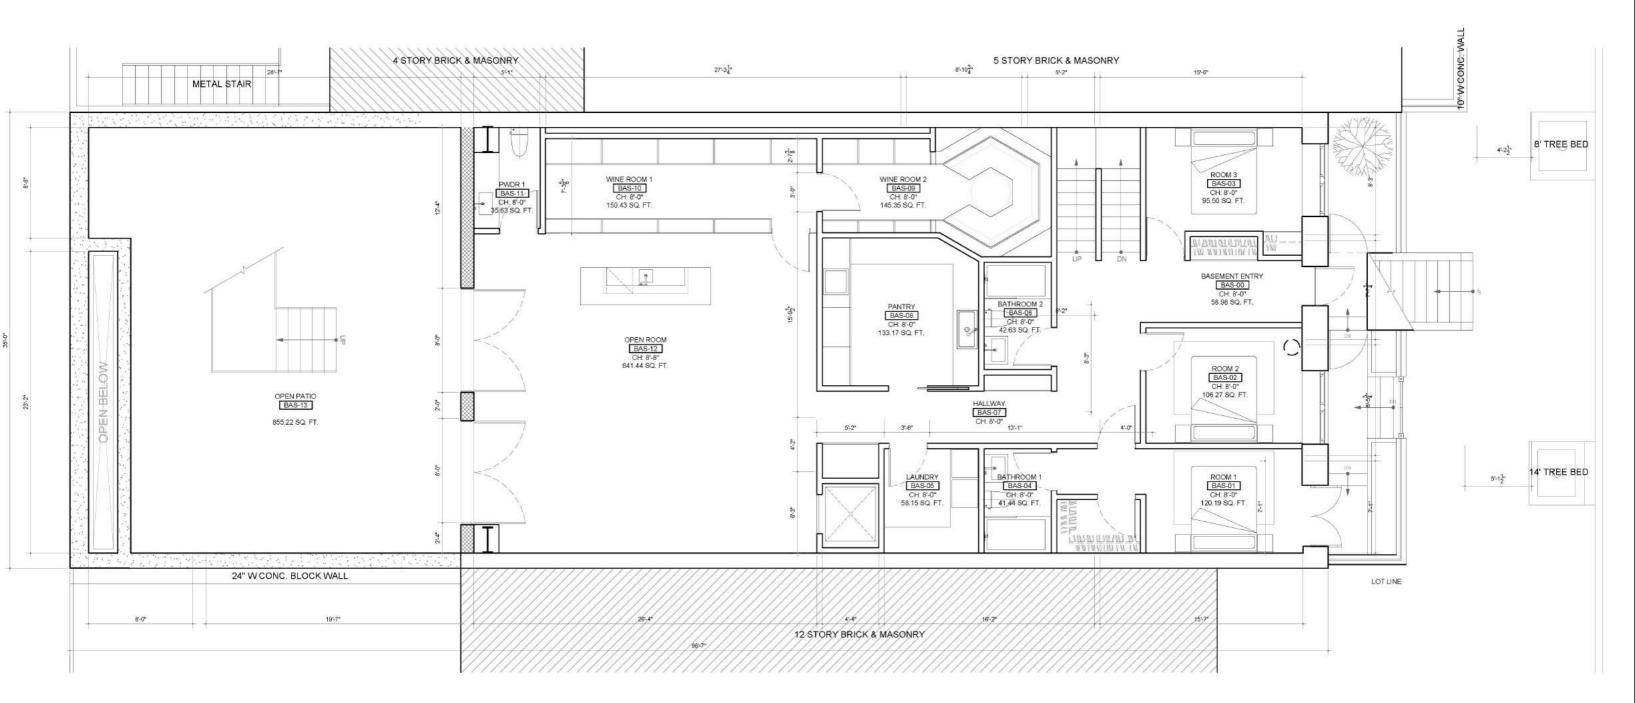

BASEMENT FLOOR PLAN

1 PROPOSED CONSTRUCTION FLOOR PLAN - BASEMENT SCALE: 1/4" = 1"-0"



CONSTRUCTION NOTES:

INSTALL NEW EXTERIOR WALLS PER EXTERIOR ENVELOPE DETAILS

INSTALL NEW WINDOWS PER WINDOW SCHEDULE & DETAILS

INSTALL NEW EXTERIOR DOORS PER DOOR SCHEDULES

INSTALL NEW ELEVATOR PER ELEVATOR MANUFACTURER SPECIFICATION & ELEVATOR DETAILS

INSTALL NEW NON-BEARING PARTITION WALLS PER PARTITION DETAILS

INSTALL NEW CUSTOM BUILT-IN MILLWORK

INSTALL NEW INTERIOR DOORS PER DOOR SCHEDULES

INSTALL NEW WOOD FLOOR FINISH @ DRY AREAS & STONE/TILEFINISH @ WET AREAS WITH WATERPROOF MEMBRANE

INSTALL NEW PLUMBING FIXTURES PER PLUMBING DWGS.

INSTALL NEW HARD-WIRED SMOKE/CARBON MONOXIDE DETECTOR #SC9120LBL, LISTED TO UL 217 & 2034 PER NYC 2014 BC 908.7.1.1.1

NEW CONCRETE SLAB ON GRADE. SEE STRUCTURAL DWGS.

NEW WD. FIN. STAIR W/ STEEL STRINGER. SEE A-XXX & STRUCTURAL DWGS, FOR DTLS.


INSTALL NEW UTILITY SERVICE

INSTALL NEW 1-HR FIRE RATED ACCESS DOOR

CONSTRUCTION LEGEND



SMOKE/ CARBON MONOXIDE DETECTOR, MOUNTED ON CEILING SMOKE/ CARBON MONOXIDE DETECTOR, MOUNTED ON WALL

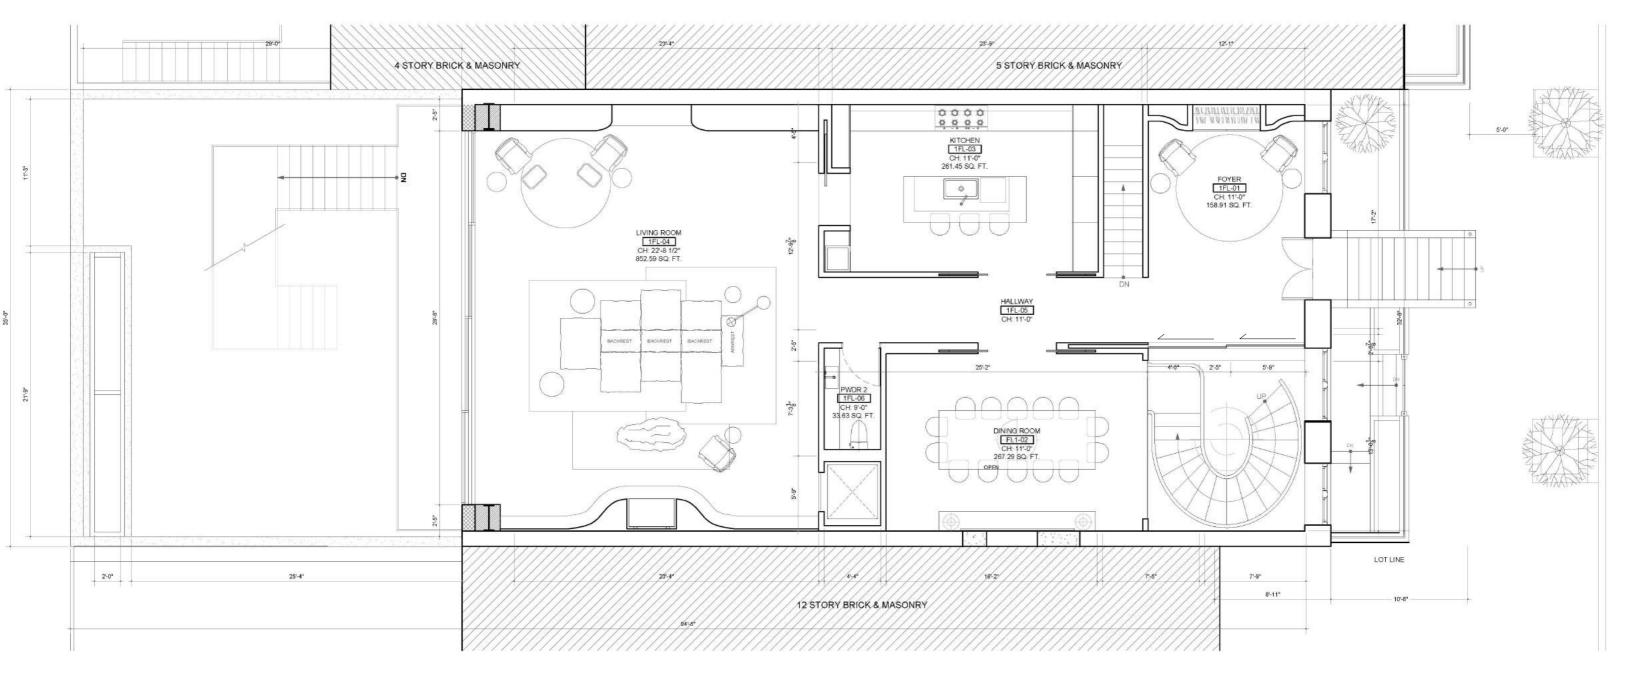

FLOOR 1 PLAN

1 PROPOSED CONSTRUCTION FLOOR PLAN - FLOOR 1



CONSTRUCTION NOTES:

INSTALL NEW EXTERIOR WALLS PER EXTERIOR ENVELOPE DETAILS INSTALL NEW WINDOWS PER WINDOW SCHEDULE & DETAILS

INSTALL APPLIANCES AS PER SCHEDULE

INSTALL NEW ELEVATOR PER ELEVATOR MANUFACTURER SPECIFICATION & ELEVATOR DETAILS

INSTALL NEW NON-BEARING PARTITION WALLS PER PARTITION DETAILS INSTALL NEW CUSTOM BUILT-IN MILLWORK

INSTALL NEW INTERIOR DOORS PER DOOR SCHEDULES


INSTALL NEW WOOD FLOOR FINISH @ DRY AREAS & STONE/TILE FINISH @ WET AREAS WITH WATERPROOF MEMBRANE


INSTALL NEW PLUMBING FIXTURES PER PLUMBING DWGS.


INSTALL NEW HARD-WIRED SMOKE/CARBON MONOXIDE DETECTOR #SC9120LBL, LISTED TO UL 217 & 2034 PER NYC 2014 BC 908.7.1.1.1 #INSTALL BLEED TO ULZ TV & 2003 PEN NY 2 2014 BE 50367.T.1.

INSTALL NEW DECORATIVE GAS APPLIANCE W NEW FIREBOX AS BELOW OR EQUIVALENT: DAVINCI 72'x12" SINGLE SIDE, COMPLYING W ANSI 2223 1 & NFPA 54(88) PER MECHANICAL AND PLUMBING DRAWINGS. INSTALL PER MANUF. SPECS.

NEW WD. FIN STAIR W STEEL STRINGER, SEE A-XXX.00-AXXX.00 & STRUCT. DWGS. FOR DTLS.

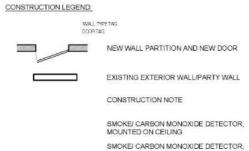

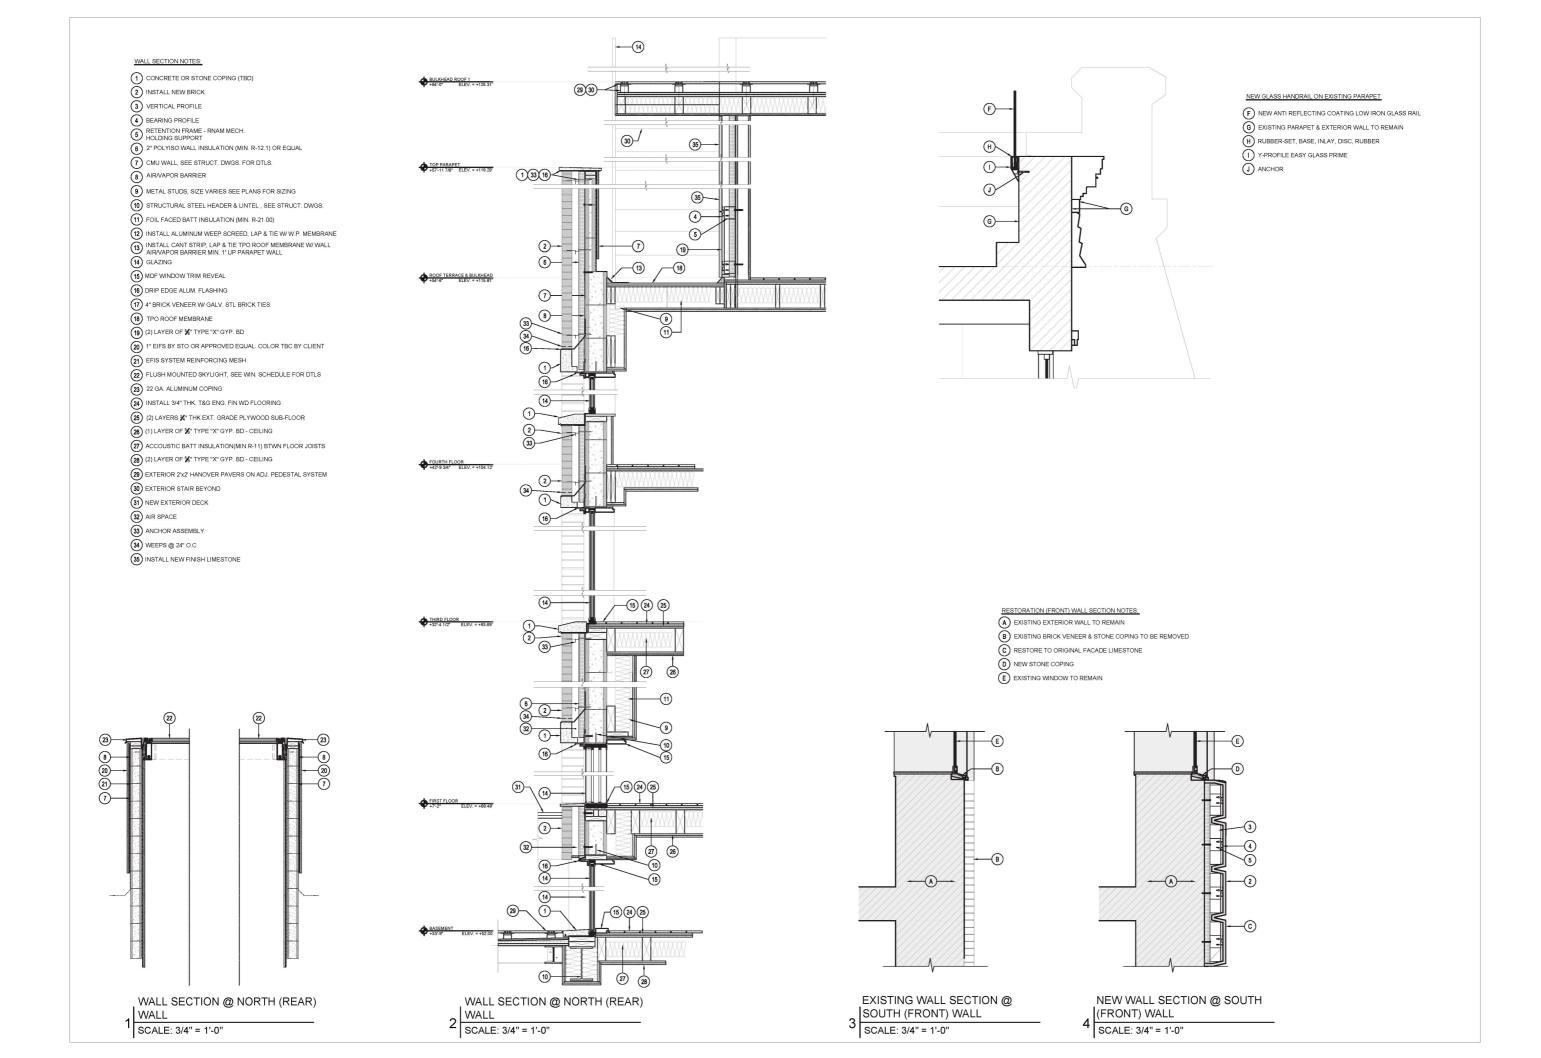

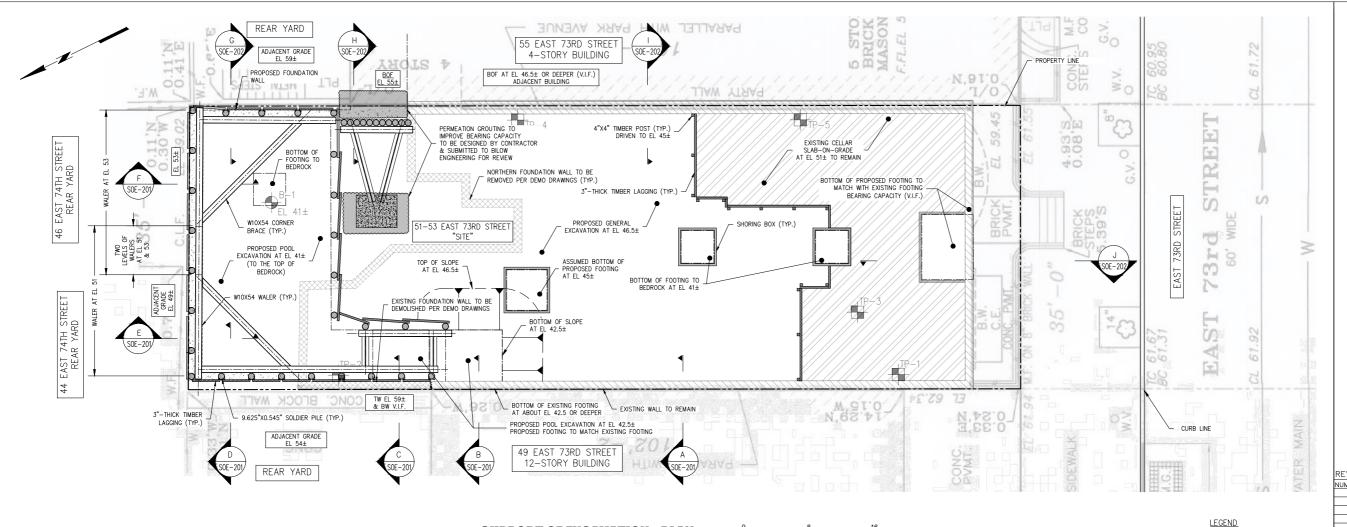

NOTES:

- A. NEIGHBORING AGREEMENT IS REQUIRED FOR THE INSTALLATION OF PERMEATION GROUTING, SOLDIER PILES, OPTICAL MONITORING POINTS AND SEISMOGRAPHS.
- B. A CLEAR DISTANCE OF 1.5' IS REQUIRED FOR ALL THE SOLDIER PILES FROM ANY EXISTING BUILDINGS/WALLS/FOOTINGS.

SEQUENCE OF OPERATIONS: SHORING

- INSTALL MONITORING CONTROL POINTS AND SEISMOGRAPHS AS SHOWN ON MONITORING PLAN AND OBTAIN BASELINE DATA PRIOR TO THE START OF DEMOLITION.
- SAW-CUT AND DEMOLISH PORTIONS OF FOUNDATION WALL PER DEMO DRAWINGS.
- INSTALL PERMEATION GROUTING.
- 4. INSTALL SOLDIER PILES PER THE SOE PLAN.
- EXCAVATE TO THE FINAL SUBGRADE EXCAVATION BY INSTALLING LAGGING & BRACING AND MAINTAINING SOIL SLOPING AS SHOWN.

TO NOTE:

- A DOB/DOT PERMIT IS REQUIRED TO CLOSE THE SIDEWALK IMMEDIATELY IN FRONT OF THE SITE.
- ANY FIELD CHANGES TO THIS DESIGN MUST BE REVIEWED AND APPROVED BY THE ENGINEER. PRIOR TO PROCEEDING WITH RESPECTIVE WORK.

GENERAL NOTES:

 LOCATIONS AND ELEVATIONS OF ALL STRUCTURAL BUILDING ELEMENTS SHOWN ON THIS DRAWING MAY BE APPROXIMATE AND SHALL BE SUPERSEDED BY FOUNDATION, STRUCTURAL AND ARCHITECTURAL DRAWINGS.

SCALE: 3/16"=1'-0"

SUPPORT OF EXCAVATION - PLAN

- 2. CONTRACTOR TO CHECK AND VERIFY ALL CONDITIONS AT SITE.
- 3. DIMENSIONS ARE NOT TO BE DETERMINED BY SCALING.
- THESE DRAWINGS DO NOT ADDRESS SAFETY ISSUES RELATED TO THE EXCAVATION AND SHORING WORK. OTHERS SHALL BE RESPONSIBLE FOR SITE SAFETY AND PROVIDE A SAFETY PLAN CONFORMING TO OSHA AND ALL APPLICABLE LAWS.
- BARRIERS AND FENCING AROUND SITE MUST BE PROVIDED BY CONTRACTOR IN ACCORDANCE WITH NEW YORK CITY DEPARTMENT OF BUILDINGS AND ALL APPLICABLE 1 AME
- IF THE CONDITIONS OBSERVED AS THE EXCAVATION ADVANCES ARE DIFFERENT THAN THE CONDITIONS SHOWN ON THE DESIGN DRAWINGS, THE CONTRACTOR SHALL STOP WORK AND NOTIFY THE CONSTRUCTION MANAGER AND ENGINEER TO ADDRESS FIELD CONDITIONS.
- OBSERVED MOVEMENTS OF THE SUPPORT OF EXCAVATION OR EXISTING STRUCTURES SHALL BE BROUGHT TO THE ATTENTION OF THE CONSTRUCTION MANAGER AND ENGINEER. REFER TO SURVEY AND MONITORING REQUIREMENTS.
- 8. LOOSE AREAS OF FOUNDATION WALL OR FOOTINGS THAT ARE DAMAGED OR LOOSE SHOULD BE BROUGHT TO THE ATTENTION OF THE ENGINEER FOR EVALUATION AND REMEDIAL MEASURES BY THIS OFFICE OR AT DIRECTION OF FIELD PROFESSIONAL ENGINEER
- 9. ALL WELDING SHALL BE PERFORMED IN ACCORDANCE WITH AWS D1.1 USING E-70 ELECTRODES.
- 10. THE PLAN IS APPROVED ONLY FOR THE WORK INDICATED ON THE APPLICATION SPECIFICATION SHEET. ALL OTHER MATTERS SHOWN ARE NOT TO BE RELIED UPON OR CONSIDERED AS EITHER BEING APPROVED OR IN ACCORDANCE WITH APPLICABLE CODES.
- 11. EXISTING BOTTOM OF PROPOSED FOOTING ELEVATIONS ARE BASED ON FOUNDATION DRAWINGS PREPARED BY MADSEN CONSULTING ENGINEERING DATED FEBRUARY 18, 2022. ANY DISCREPANCIES TO BE REPORTED TO THE ENGINEER.
- 12. THE DESIGNS ON THESE DRAWINGS ARE INTENDED FOR THE TEMPORARY SUPPORT OF EXCAVATION ONLY.
- NOTIFY DOB 24 TO 48 HOURS PRIOR TO EXCAVATION (RULE 52). OWNER IS RESPONSIBLE FOR ALL ADJACENT PROPERTY AGREEMENTS AND NOTIFICATIONS UNDER DOB CODE REQUIREMENTS.

DRAINAGE (SURFACE WATER CONTROL):

- CONTROL SURFACE WATER AT THE PERIMETER OF THE EXCAVATION TO PREVENT WATER FROM COLLECTING AND PONDING ON EXPOSED SUBGRADES AND BACKFILL SURFACES.
- GRADE ADJACENT AREAS TO PREVENT SURFACE WATER RUNOFF FROM ENTERING EXCAVATION. INSTALL SILT FENCES, IF REQUIRED.
- DESIGN AND PLACE TRENCHES, SUMPS, AND PUMPS TO PREVENT SURFACE WATER FROM RUNNING ONTO PREPARED FOOTING SUBGRADES AND FLOOR SUBGRADES.
- ALL SIDES OR SLOPES OF EXCAVATIONS OR EMBANKMENTS SHALL BE INSPECTOR AFTER RAINSTORMS, OR ANY OTHER HAZARD-INCREASING EVENT, AND SAFE CONDITIONS SHALL BE RESTORED.
- ANY WATER IN THE SITE TO BE PUMPED TO THE APPROVED LOCATIONS TO PREVENT THE ACCUMULATION OF WATER AND THUS NOT CREATE ANY WATER DAMAGE TO FOUNDATIONS ON THE PREMISES OR TO THE ADJOINING PROPERTY.
- ALL EXCAVATIONS SHALL BE DRAINED, AND DRAINAGE SHALL BE MAINTAINED AS LONG AS THE EXCAVATION CONTINUES OR REMAINS.

NICED 3303.19

NO CONDITION SHALL BE CREATED AS A RESULT OF CONSTRUCTION OR DEMOLITION OPERATIONS THAT WILL INTERFERE WITH NATURAL SURFACE DRAINAGE.WATER COURSES, DRAINAGE DITCHES, ETC., SHALL NOT BE OBSTRUCTED BY REFUSE, WASTE BUILDING MATERIALS, EARTH, STONES, TREE STUMPS, BRANCHES, OR OTHER DEBRIS THAT MAY INTERFERE WITH SURFACE DRAINAGE OR CAUSE THE MPOUNDMENT OF SURFACE WATERS.



99 FRANKLIN TURNPIKE ALLENDALE NEW JERSEY 07401

REVISIO	DNS:	
NUMBER	REVISION	DATE
	SUBMISSION#1	11/11/202
		•

DOB NOW BUILD#

OWNER

BORING LOCATION

TEST PIT LOCATION

SOLDIER PILE

SOIL SLOPING

0

PROJECT:

51 EAST 73RD STREET

PROJECT ADDRESS:

NEW YORK, NY 10021

DRAWING TITLE:


SUPPORT OF EXCAVATION PLAN


SEAL & SIGNATURE


JONATHAN BILOW,
PROFESSIONAL ENGINEER

N.Y.P.E License No. 077650-1 DATE: 11/11/2022
PROJECT NO.: 22132
DRAWN BY: SB
CHECKED BY: JB
DWG. NO.

SOE-102.00

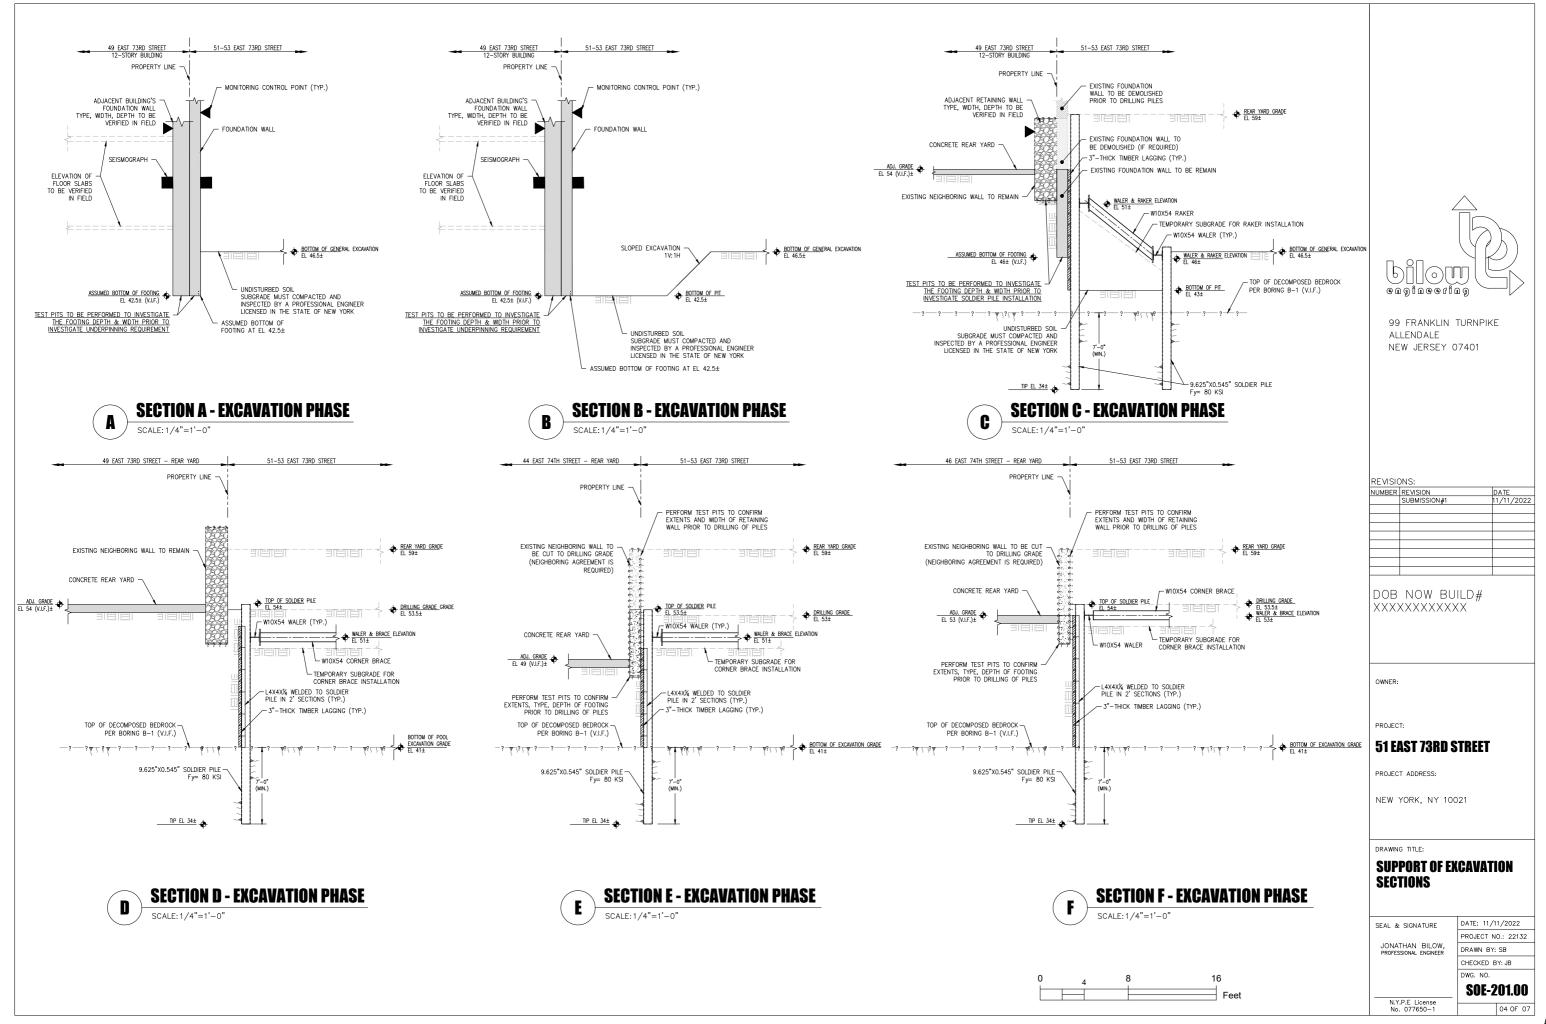


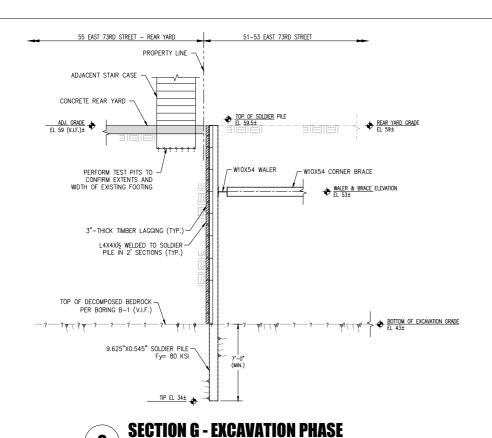

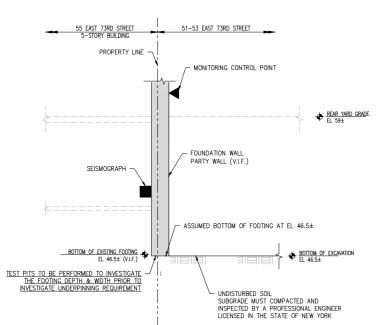


SCALE: 1/4"=1'-0"



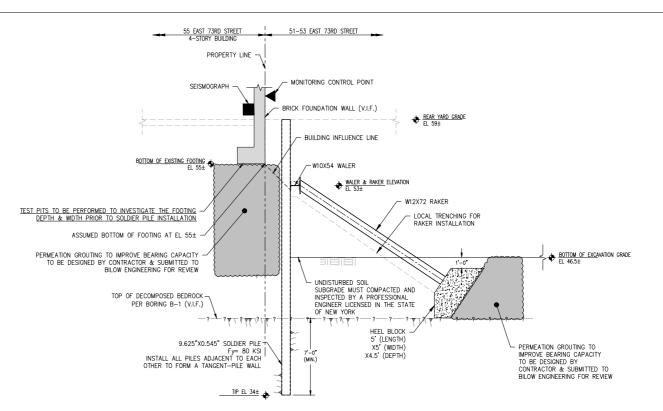


SECTION H - EXCAVATION PHASE SCALE: 1/4"=1'-0"

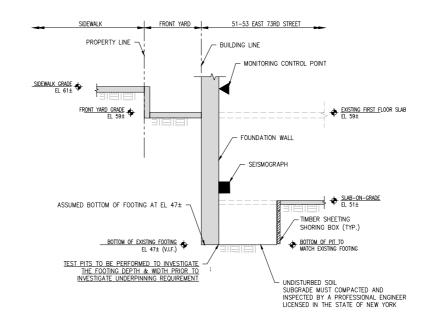





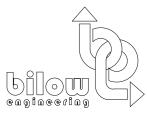

99 FRANKLIN TURNPIKE ALLENDALE NEW JERSEY 07401

REVISIONS:				
NUMBER		DATE		
	SUBMISSION#1	11/11/2022		

DOB NOW BUILD# XXXXXXXXXXXX

OWNER:

PROJECT:

51 EAST 73RD STREET

PROJECT ADDRESS:

NEW YORK, NY 10021

DRAWING TITLE:

SUPPORT OF EXCAVATION SECTIONS


DATE: 11/11/2022 SEAL & SIGNATURE PROJECT NO.: 22132 JONATHAN BILOW, PROFESSIONAL ENGINEER DRAWN BY: SB

CHECKED BY: JB DWG. NO.

SOE-202.00 05 OF 07

PREVIOUS DESIGN - DOGLEG STOOP RESTORATION



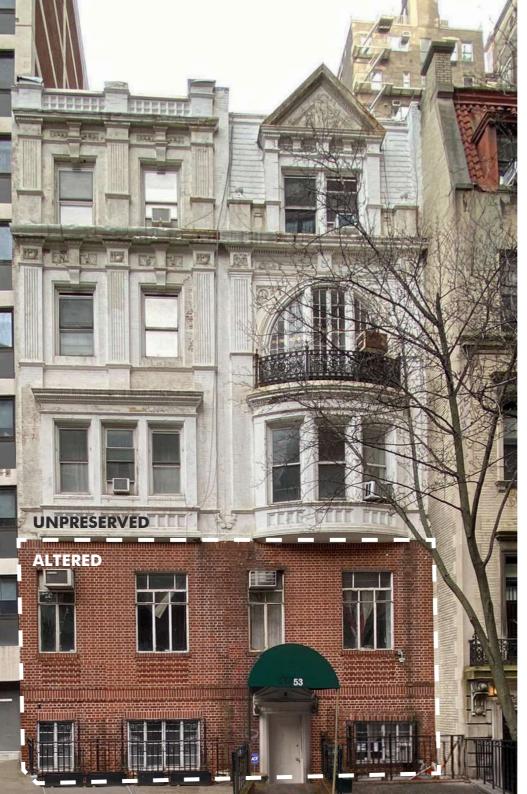




ORIGINAL - 1885 PRESENT PROPOSED

PREVIOUS DESIGN - DOGLEG STOOP RESTORATION



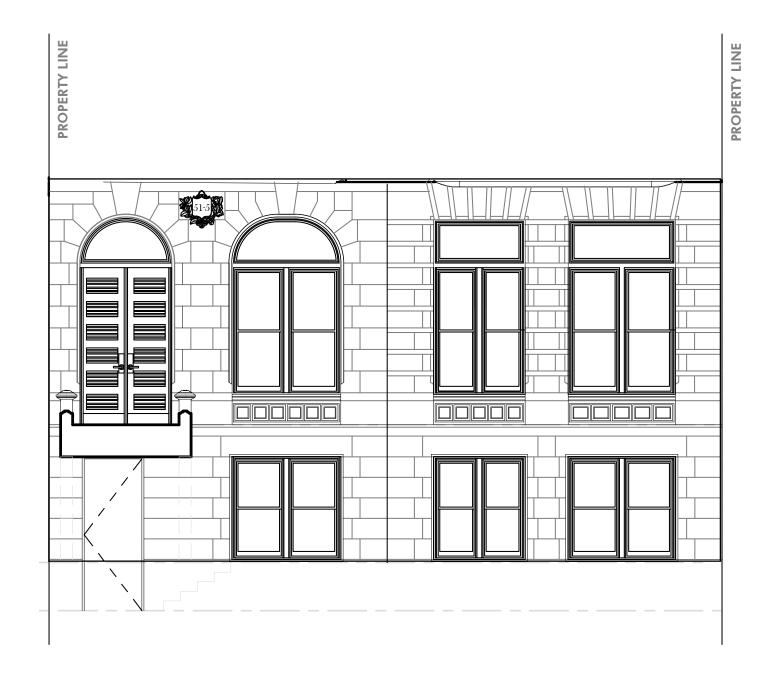


STOOP & ENTRY DESIGN






FRONT FACADE AXON VIEW


HISTORIC STOOP RESTORATION

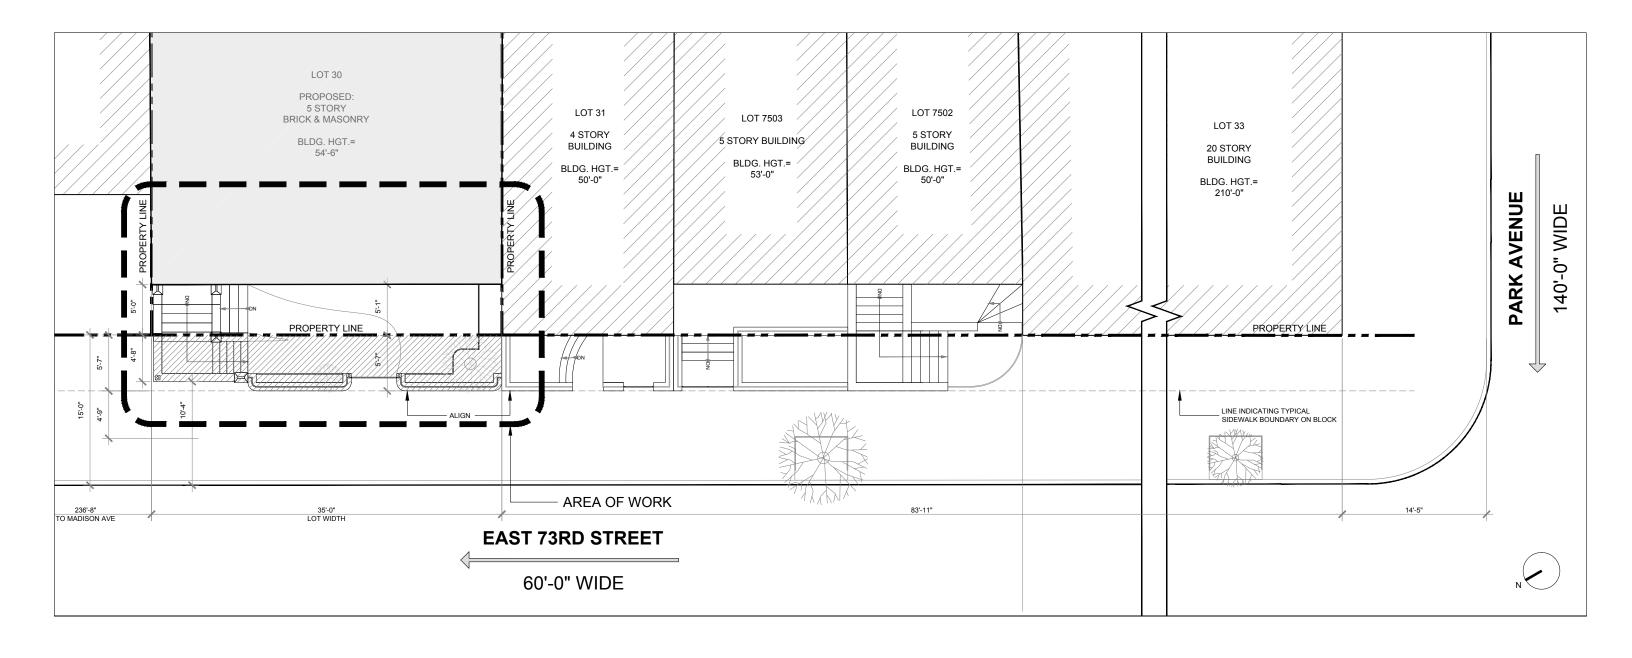

10'-2"

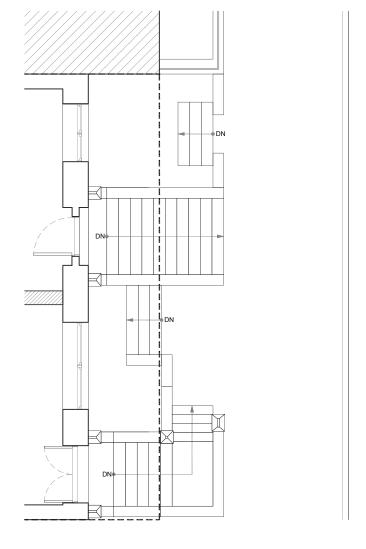


Original Entry 1885

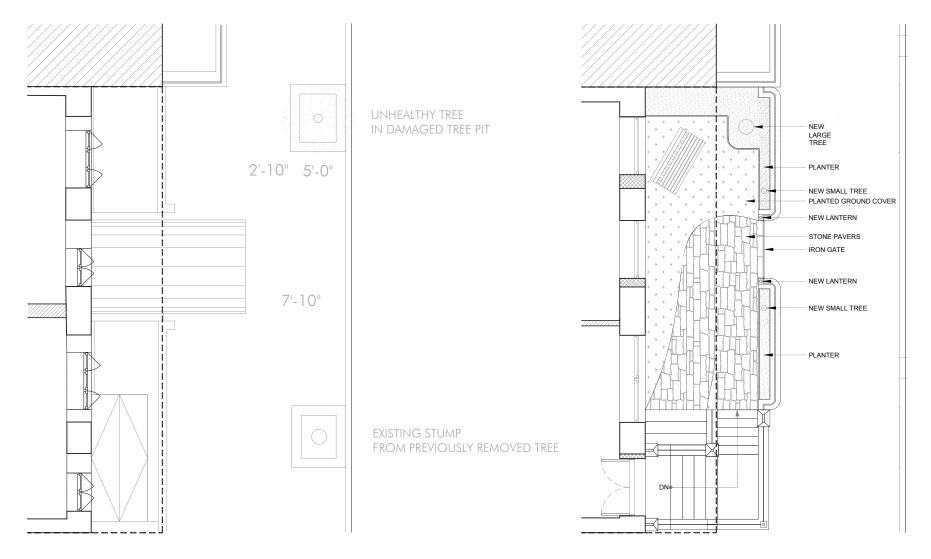



Existing Entry
1945

Proposed Entry

PROPOSED ENTRY RESTORATION

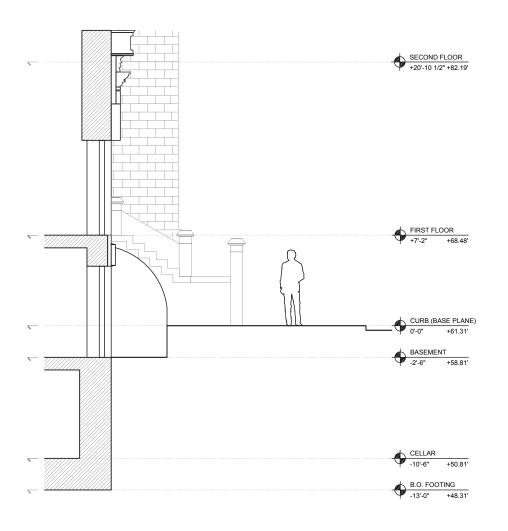

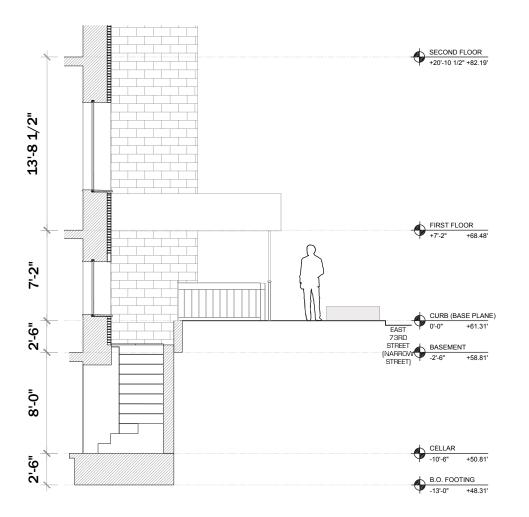

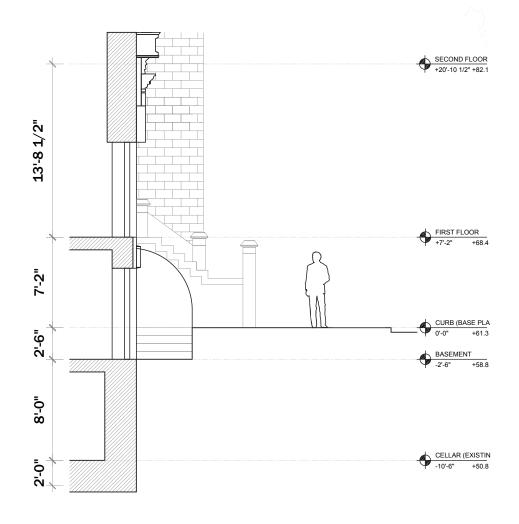

Original Entry 1885

Existing Entry 1945

Proposed Entry



The current proposal is:

Preservation Department – Item 6, LPC-23-03513

51-53 East 73rd Street – Upper East Side Historic District Borough of Manhattan

To testify virtually, please join Zoom

Webinar ID: 864 9888 2944

Passcode: 903125

By Phone: 1 646-558-8656 US (New

York) 877-853-5257 (Toll free) US

888 475 4499 (Toll free)

Note: If you want to testify virtually on an item, join the Zoom webinar at the agenda's "Be Here by" time (about an hour in advance). When the Chair indicates it's time to testify, "raise your hand" via the Zoom app if you want to speak (*9 on the phone). Those who signed up in advance will be called first.