

The current proposal is:

Preservation Department – Item 1, LPC-23-00996

163 Bleecker Street – South Village Historic District Borough of Manhattan

Note: this is a Public Meeting item. No public testimony will be received today as the hearing on this item is closed



PROPOSED FACADE FOR:

163 BLEECKER STREET

NEW YORK CITY, NEW YORK

PRESENTED TO NEW YORK CITY

LANDMARKS PRESERVATION COMMISSION (LPC)

FOR THE PUBLIC HEARING


DECEMBER 6, 2022




OWNER 109 E. 9TH ST. LLC

FILING REPRESENTATIVE PRAXIS WorkShop Inc.



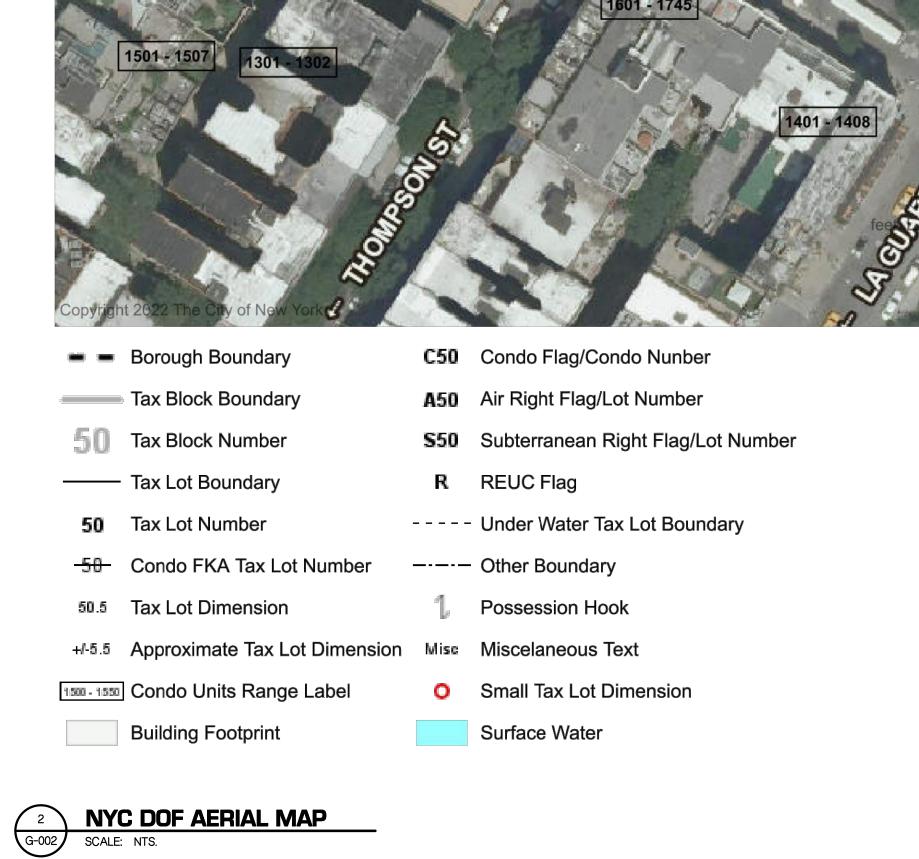

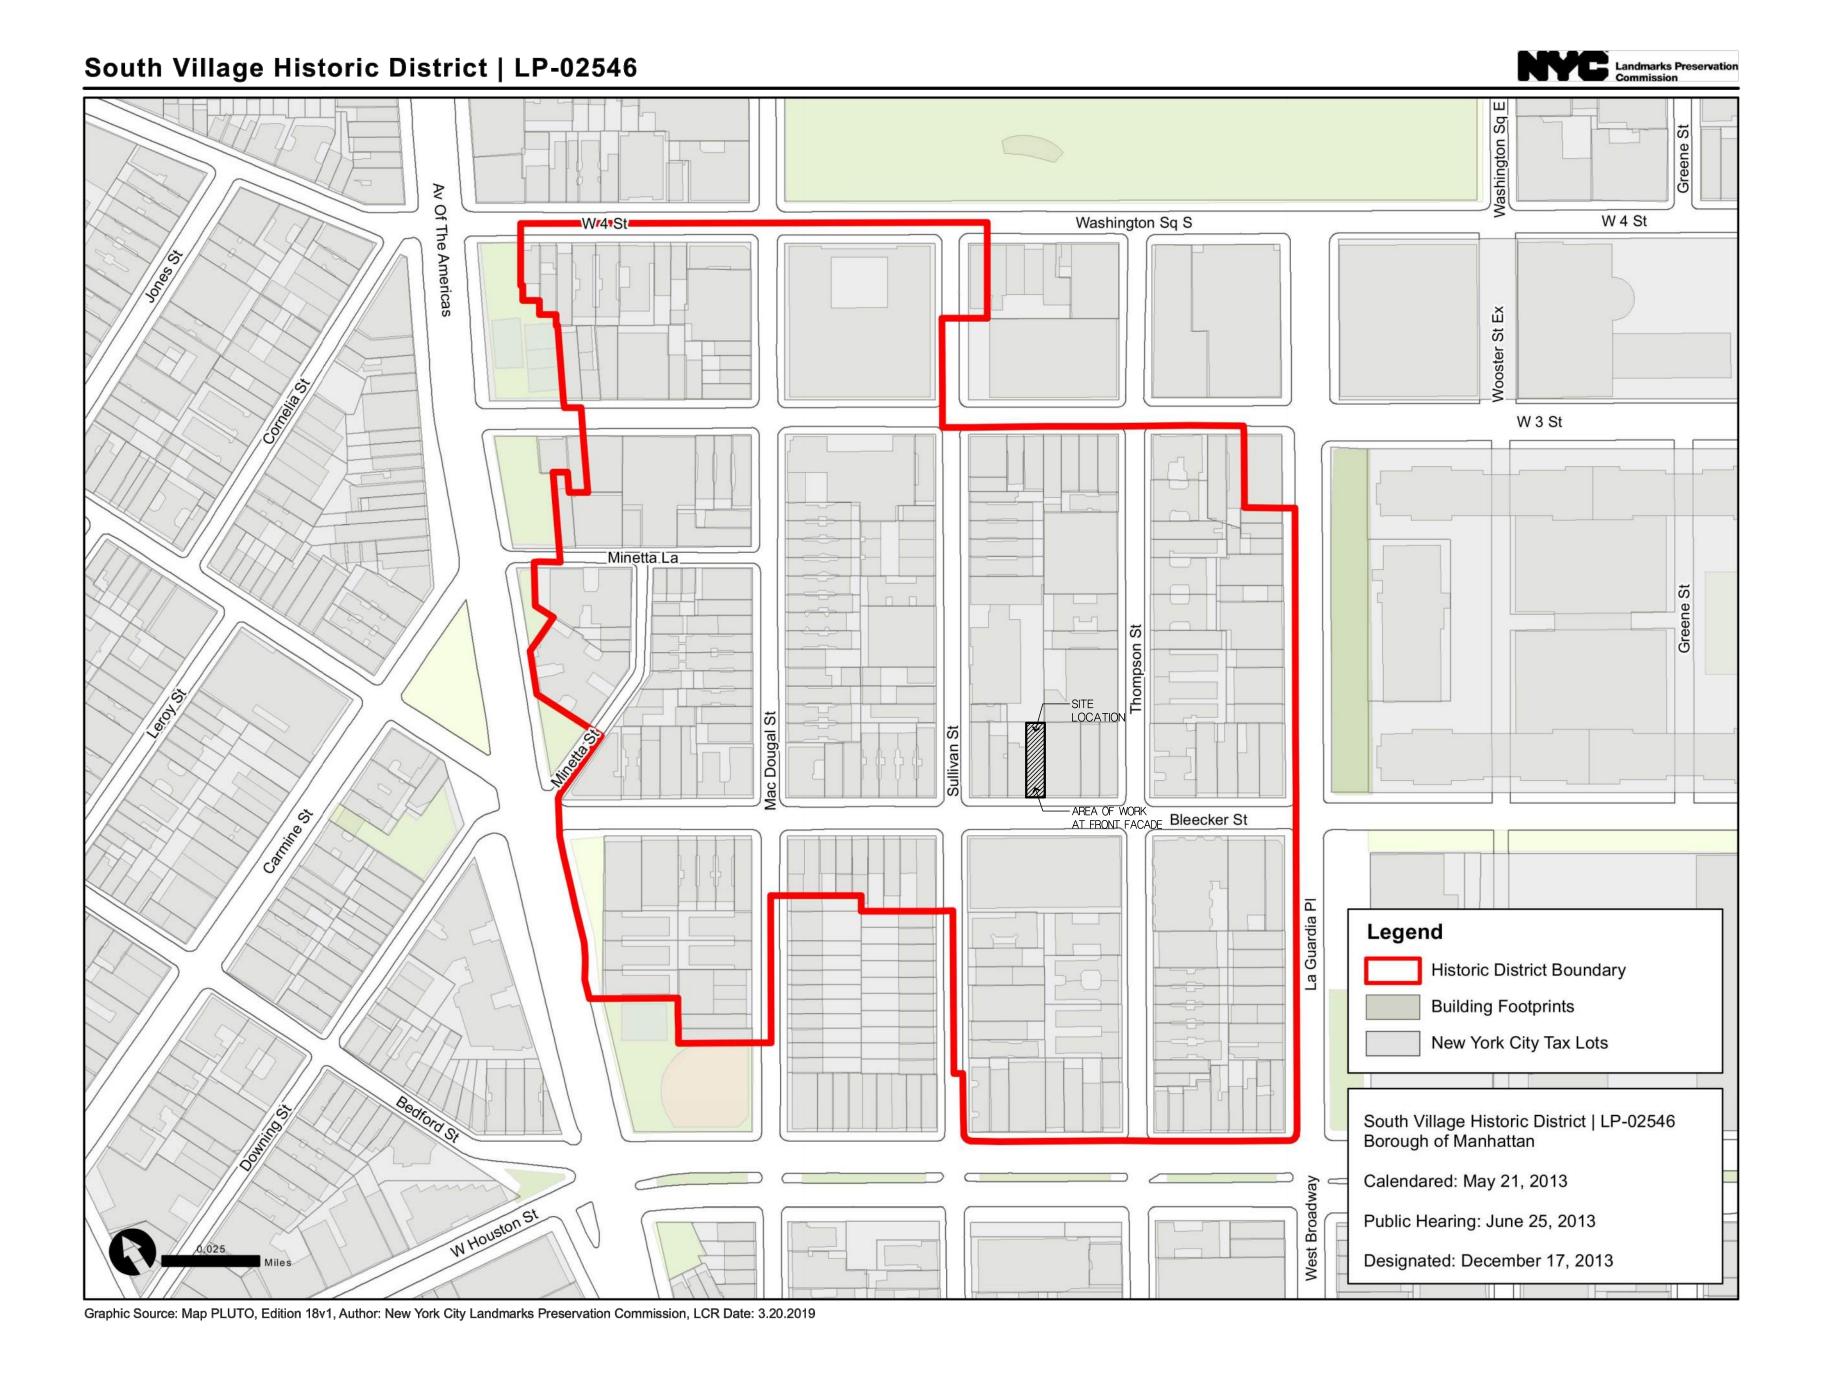

1 MAP OF SOUTH VILLAGE HISTORIC DISTRICT
G-002 SCALE: NTS


WWW.MOJOSTUMER.COM 14 Plaza Road (t) 516.625.3344 Greenvale, NY 11548 (f) 516.625.3418

Associates, P.C. & is not to be altered, reused or reproduced without written permission.

LANDMARKS PRESERVATION COMMISSION SET

D A T E : DEC 06, 2022

DOB NOW JOB #:

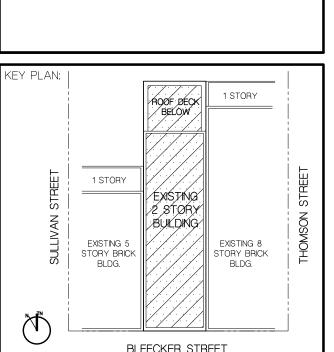


COMMERCIAL **BUILDING ALTERATION**


163 BLEECKER STREET NEW YORK, NY 10021

PROJECT NUMBER:

HISTORIC DISTRICT MAP

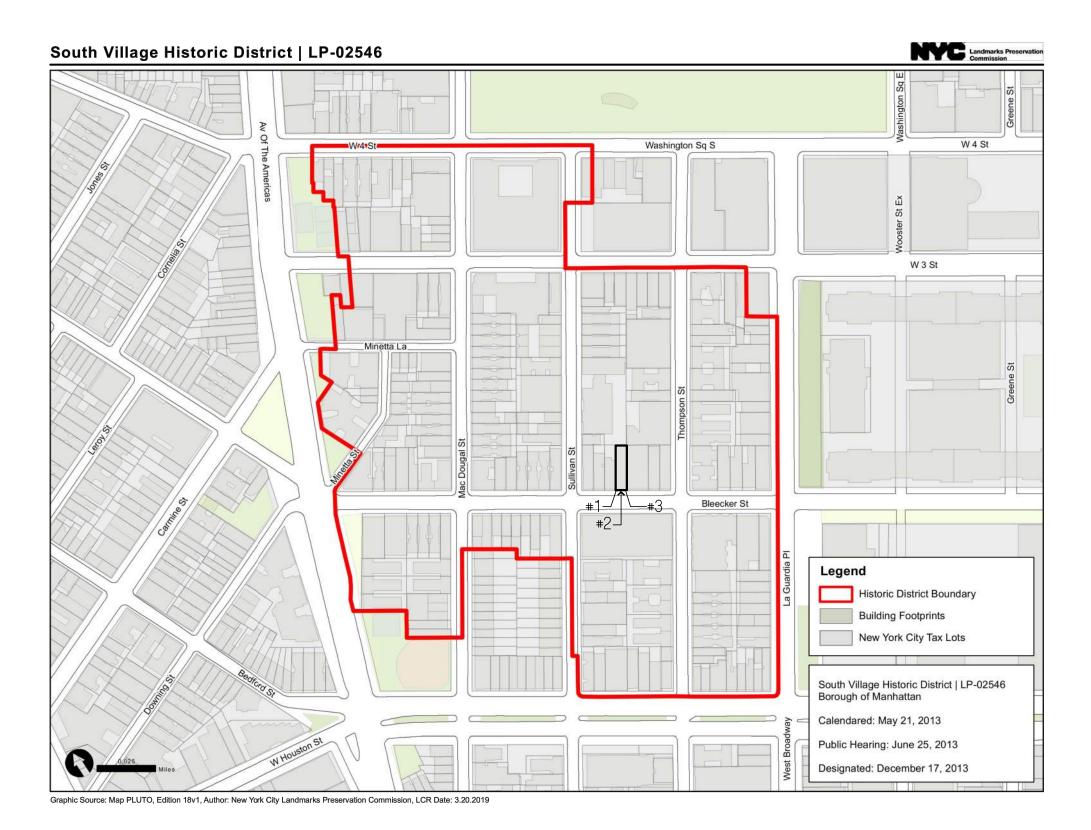


KEY MAP

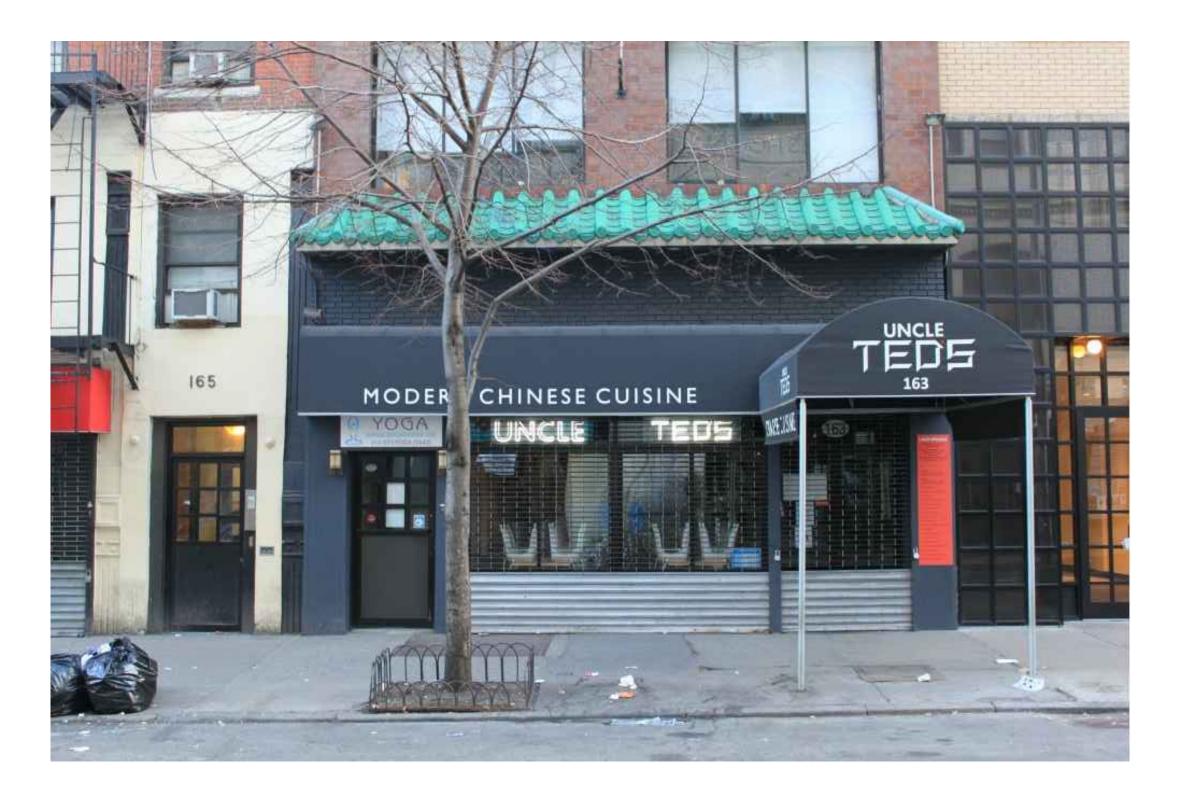


163 BLEECKER - 2013 PHOTO 1



163 BLEECKER - 1940 TAX LOT PHOTO 2

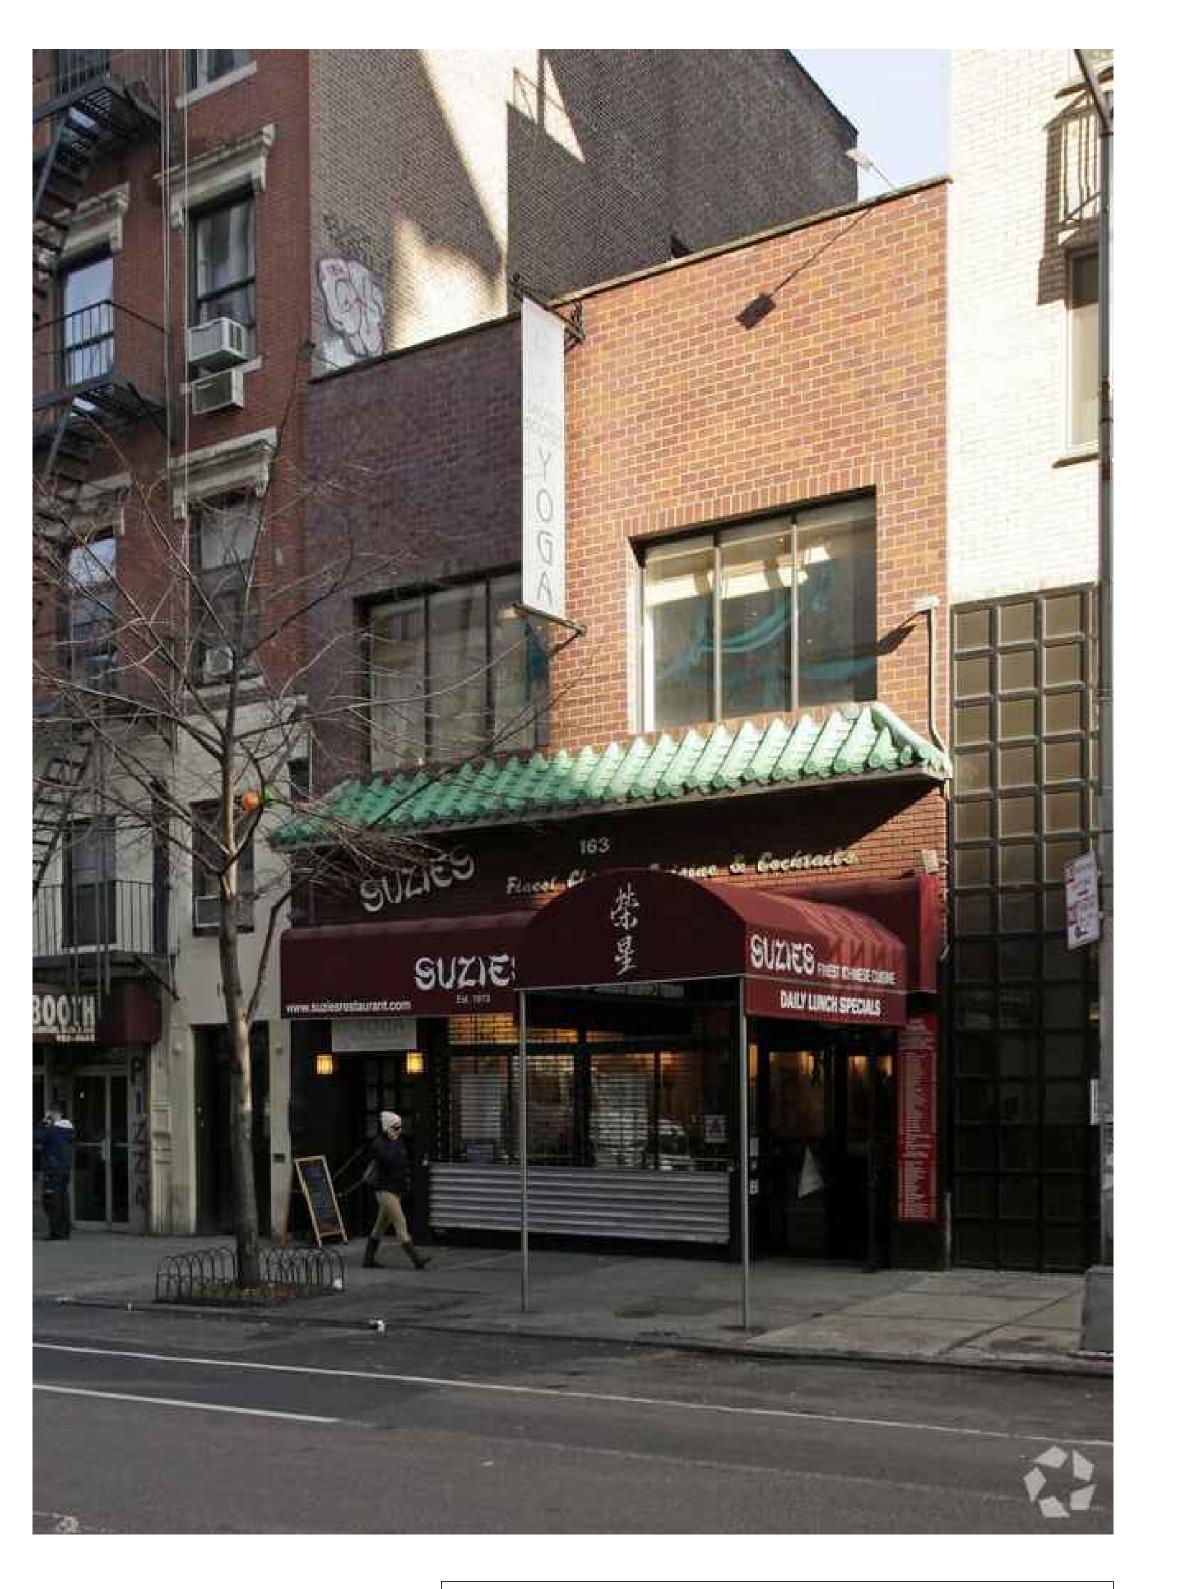

163 BLEECKER - 2011 PHOTO 3

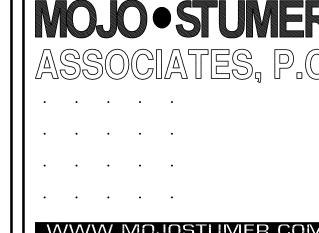

WWW.MOJOSTUMER.COM

14 Plaza Road (t) 516.625.3344

Greenvale, NY 11548 (f) 516.625.3418


This drawing is the property of Mojo Stumer Associates, P.C. & is not to be altered, reused or reproduced without written permission.

CONSULTANTS:

LANDMARKS PRESERVATION COMMISSION SET

DATE: DEC 06, 2022

DOB NOW JOB #:

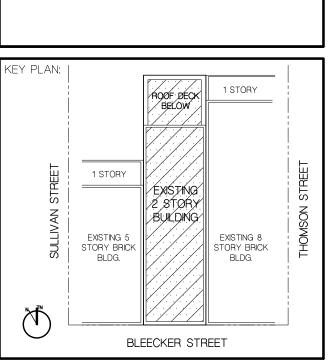

COMMERCIAL
BUILDING ALTERATION

163 BLEECKER STREET
NEW YORK, NY 10021

SCALE:

AS SHOWN

DATE:

DEC 06, 2022

DRAWN BY:


GLC/AM

PROJECT NUMBER:

2022.08

163 BLEECKER STREET
EXISTING BUILDING
PHOTOGRAPHS

DRAWING NUMBER

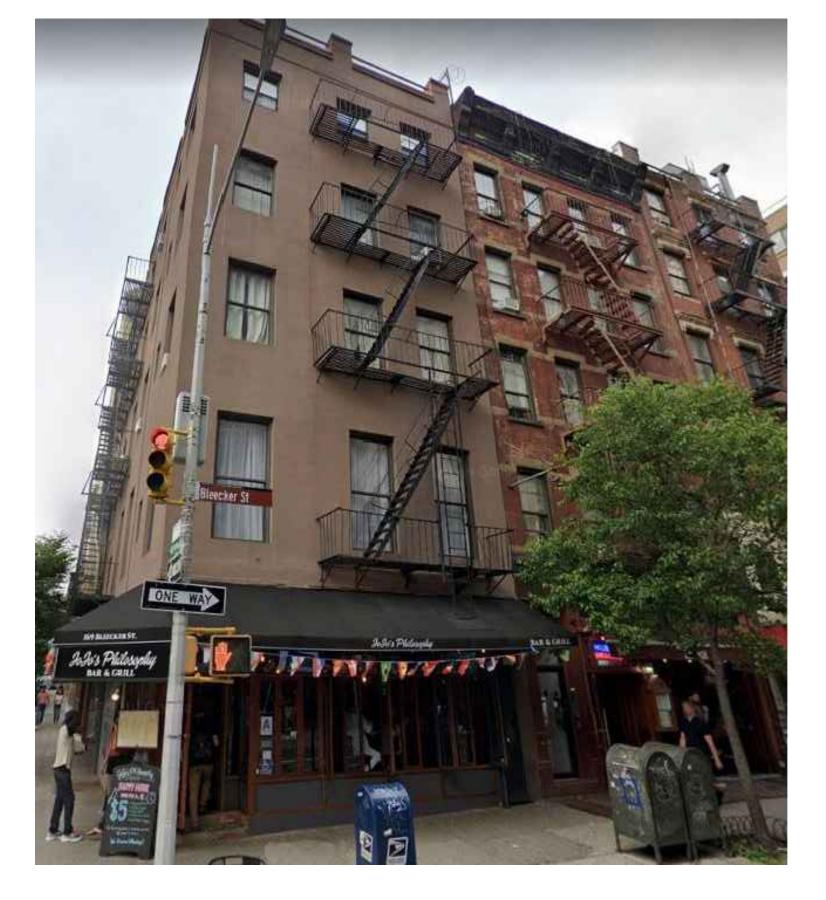






165 BLEECKER



159 BLEECKER

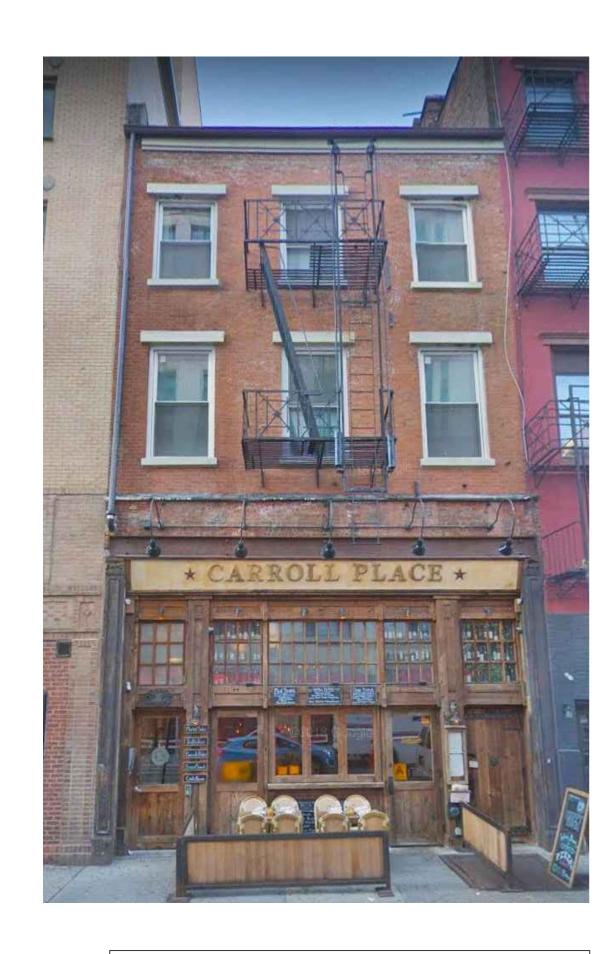

157 BLEECKER



155 BLEECKER



BLEECKER STREET BETWEEN THOMPSON AND SULLIVAN LOOKING NORTHWEST




BLEECKER STREET BETWEEN THOMPSON AND SULLIVAN LOOKING NORTHEAST



This drawing is the property of Mojo Stumer Associates, P.C. & is not to be altered, reused or reproduced without written permission.

DATE: DEC 06, 2022

3 NOW JOB #:

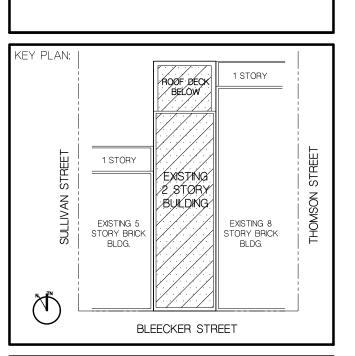

COMMERCIAL
BUILDING ALTERATION

163 BLEECKER STREET
NEW YORK, NY 10021

SCALE:

AS SHOWN

DATE:

DEC 06, 2022

DRAWN BY:

GLC/AM

PROJECT NUMBER:

2022.08

BLEECKER STREET
155 THRU 169
EXISTG BUILDING PHOTOS

DRAWING NUMBER:



163 BLEECKER STREET PROPOSED FACADE RENDERING

SCALE: NTS - (PLEASE NOTE, SMALL TREE TO BE PLACED IN FRONT OF BUILDING INTENTIONALLY LEFT OUT TO VIEW FACADE IN ITS ENTIRETY)

163 BLEECKER STREET | SOUTH VILLAGE HISTORIC DISTRICT IN NEW YORK CITY PROPOSED BUILDING RENOVATION | FACADE DESCRIPTION

The proposed renovation of 163 Bleecker Street comes after a 2020 fire caused significant damage to the structure. Prior to the fire, the building's architecture held little historic value, as major façade renovations in the years 1931, 1980, and 1993 resulted in a façade of various modern and thematic styles, including a faux-Chinese pagoda roof structure directly below the second-floor windows, with no aesthetic connection to the fabric of the South Village Historic District.

The original structure built in 1892 by Charles E. Hadden was modest in its conception and detailing, displaying little to no ornate character on its exterior wall surfaces, an all-glass ground level storefront, and two large windows placed at its second level. In the currently proposed renovation, the building will be repurposed for use as a live music venue, tying into the long and storied history of the Greenwich Village music scene, but it will also receive a new façade designed to carefully reintegrate the building back into the fabric of the South Village Historic District neighborhood.

The Façade design draws on inspiration from the facades at 80 West 3rd Street (currently Amity Hall) and 219 Thompson (currently the Chess Forum) in addition to some of the other contextually rich contemporary examples such as those found at 179 and 209 Sullivan Street.

What we found throughout the area, and particularly at 80 West 3rd Street, is the insertion of a dark panelized window and door system into a brick surround. The double height storefront at Amity Hall includes a signage band between the entry level and upper portion. Another example we found with a similar idea, is at the Chess Forum at 219 Thompson Street. Here again the same strategy of a dark panelized insertion into a brick surround was used.

The facades at 80 West 3rd Street and 219 Thompson were used as relevant references for the design at 163 Bleecker, where the dark panelized multi-story venue is contained similarly between the brick surround. The panelized window and door system adds great depth and historic texture to the new facade while also creating a direct connection between the interior of the venue and the ground level street scene. This aspect of the facade design is inspired by and is reminiscent of the rich musical and artistic periods dating back to the Beatnick and Bohemian rediscovery period.

With respect to the building's occupancy, it is scheduled solely for commercial use including its second story where the venue's operating offices are located. The office space, directly above the venue's double height entrance, is also included as part of the panelized insertion but is separated from the venue on the ground floor and mezzanine with two rows of spandrel panels between the ground floor double height venue and the second floor where the office is located.

Regarding the facade's design and its connection to it's immediate neighbors, we established alignments between the top of the double height entry of the venue where the clear glass is interrupted by the spandrel panels separating the second floor office and the top of the adjacent base and lobby entrance at 159 Bleecker. Additional relationships were made between the height and alignment of the second floor office window and horizontal metal band above with the windows and brick bands also at the 159 Bleecker apartment building to further reinforce tying in to its neighbor.

The alignments and proportioning systems used at 163 Bleecker connect it as a natural extension of the immediate adjacent buildings and prevent it from appearing like a forced insertion into the existing facade fabric on its block.

We noticed diverse color ranges in brick throughout the district, with tones usually in red, brown, and gray. Brick selection for the facade at 163 Bleecker gravitated towards warm gray to keep tonal consistency with the window and door frame color and to remain neutral with respect to the varying material and color tones found at 159 and 169 Bleecker. The brick size is modular to maintain dimensional uniformity with the rest of the South Village Historic District.

Regarding the marquee, it follows examples found at 179 Sullivan Street and 80 West 3rd Street in its materiality, proportions, and color. As is done at 179 Sullivan, it will also use a dark painted steel channel. The name of the venue is proposed to be placed at the top of the marquee in light colored lettering. A separate LED illuminated sign is proposed to be placed within the channel flanges to announce scheduled venue events.

With respect to the acoustical design, the venue is planned to include a ground floor vestibule to mitigate sound output from within the main space of the venue to the street. The interior perimeter walls will be lined with wall framing and sheathing but connected with isolation clips to prevent sound vibration from transferring through the walls. Interior materials will also be carefully selected to absorb noise and keep it within the venue.

In the facade design at 163 Bleecker Street, we took the opportunity to integrate the existing structure back into the historical fabric found in the South Village Historic District through use of proportionality and material, while also reintroducing the sense of vibrancy and character that epitomized the periods of beatnik and bohemian rediscovery of the Village.


PREVIOUS VERSION

Greenvale, NY 11548 (f) 516.625.3418

ssociates, P.C. & is not to be altered, reused o reproduced without written permission

LANDMARKS PRESERVATION COMMISSION SET

DATE: DEC 06, 2022

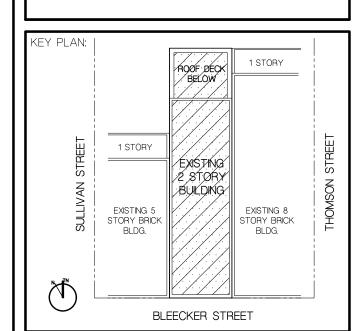





NEW YORK, NY 10021 PROJECT NUMBER:

163 BLEECKER STREET PROPOSED FACADE RENDERING

2022.08



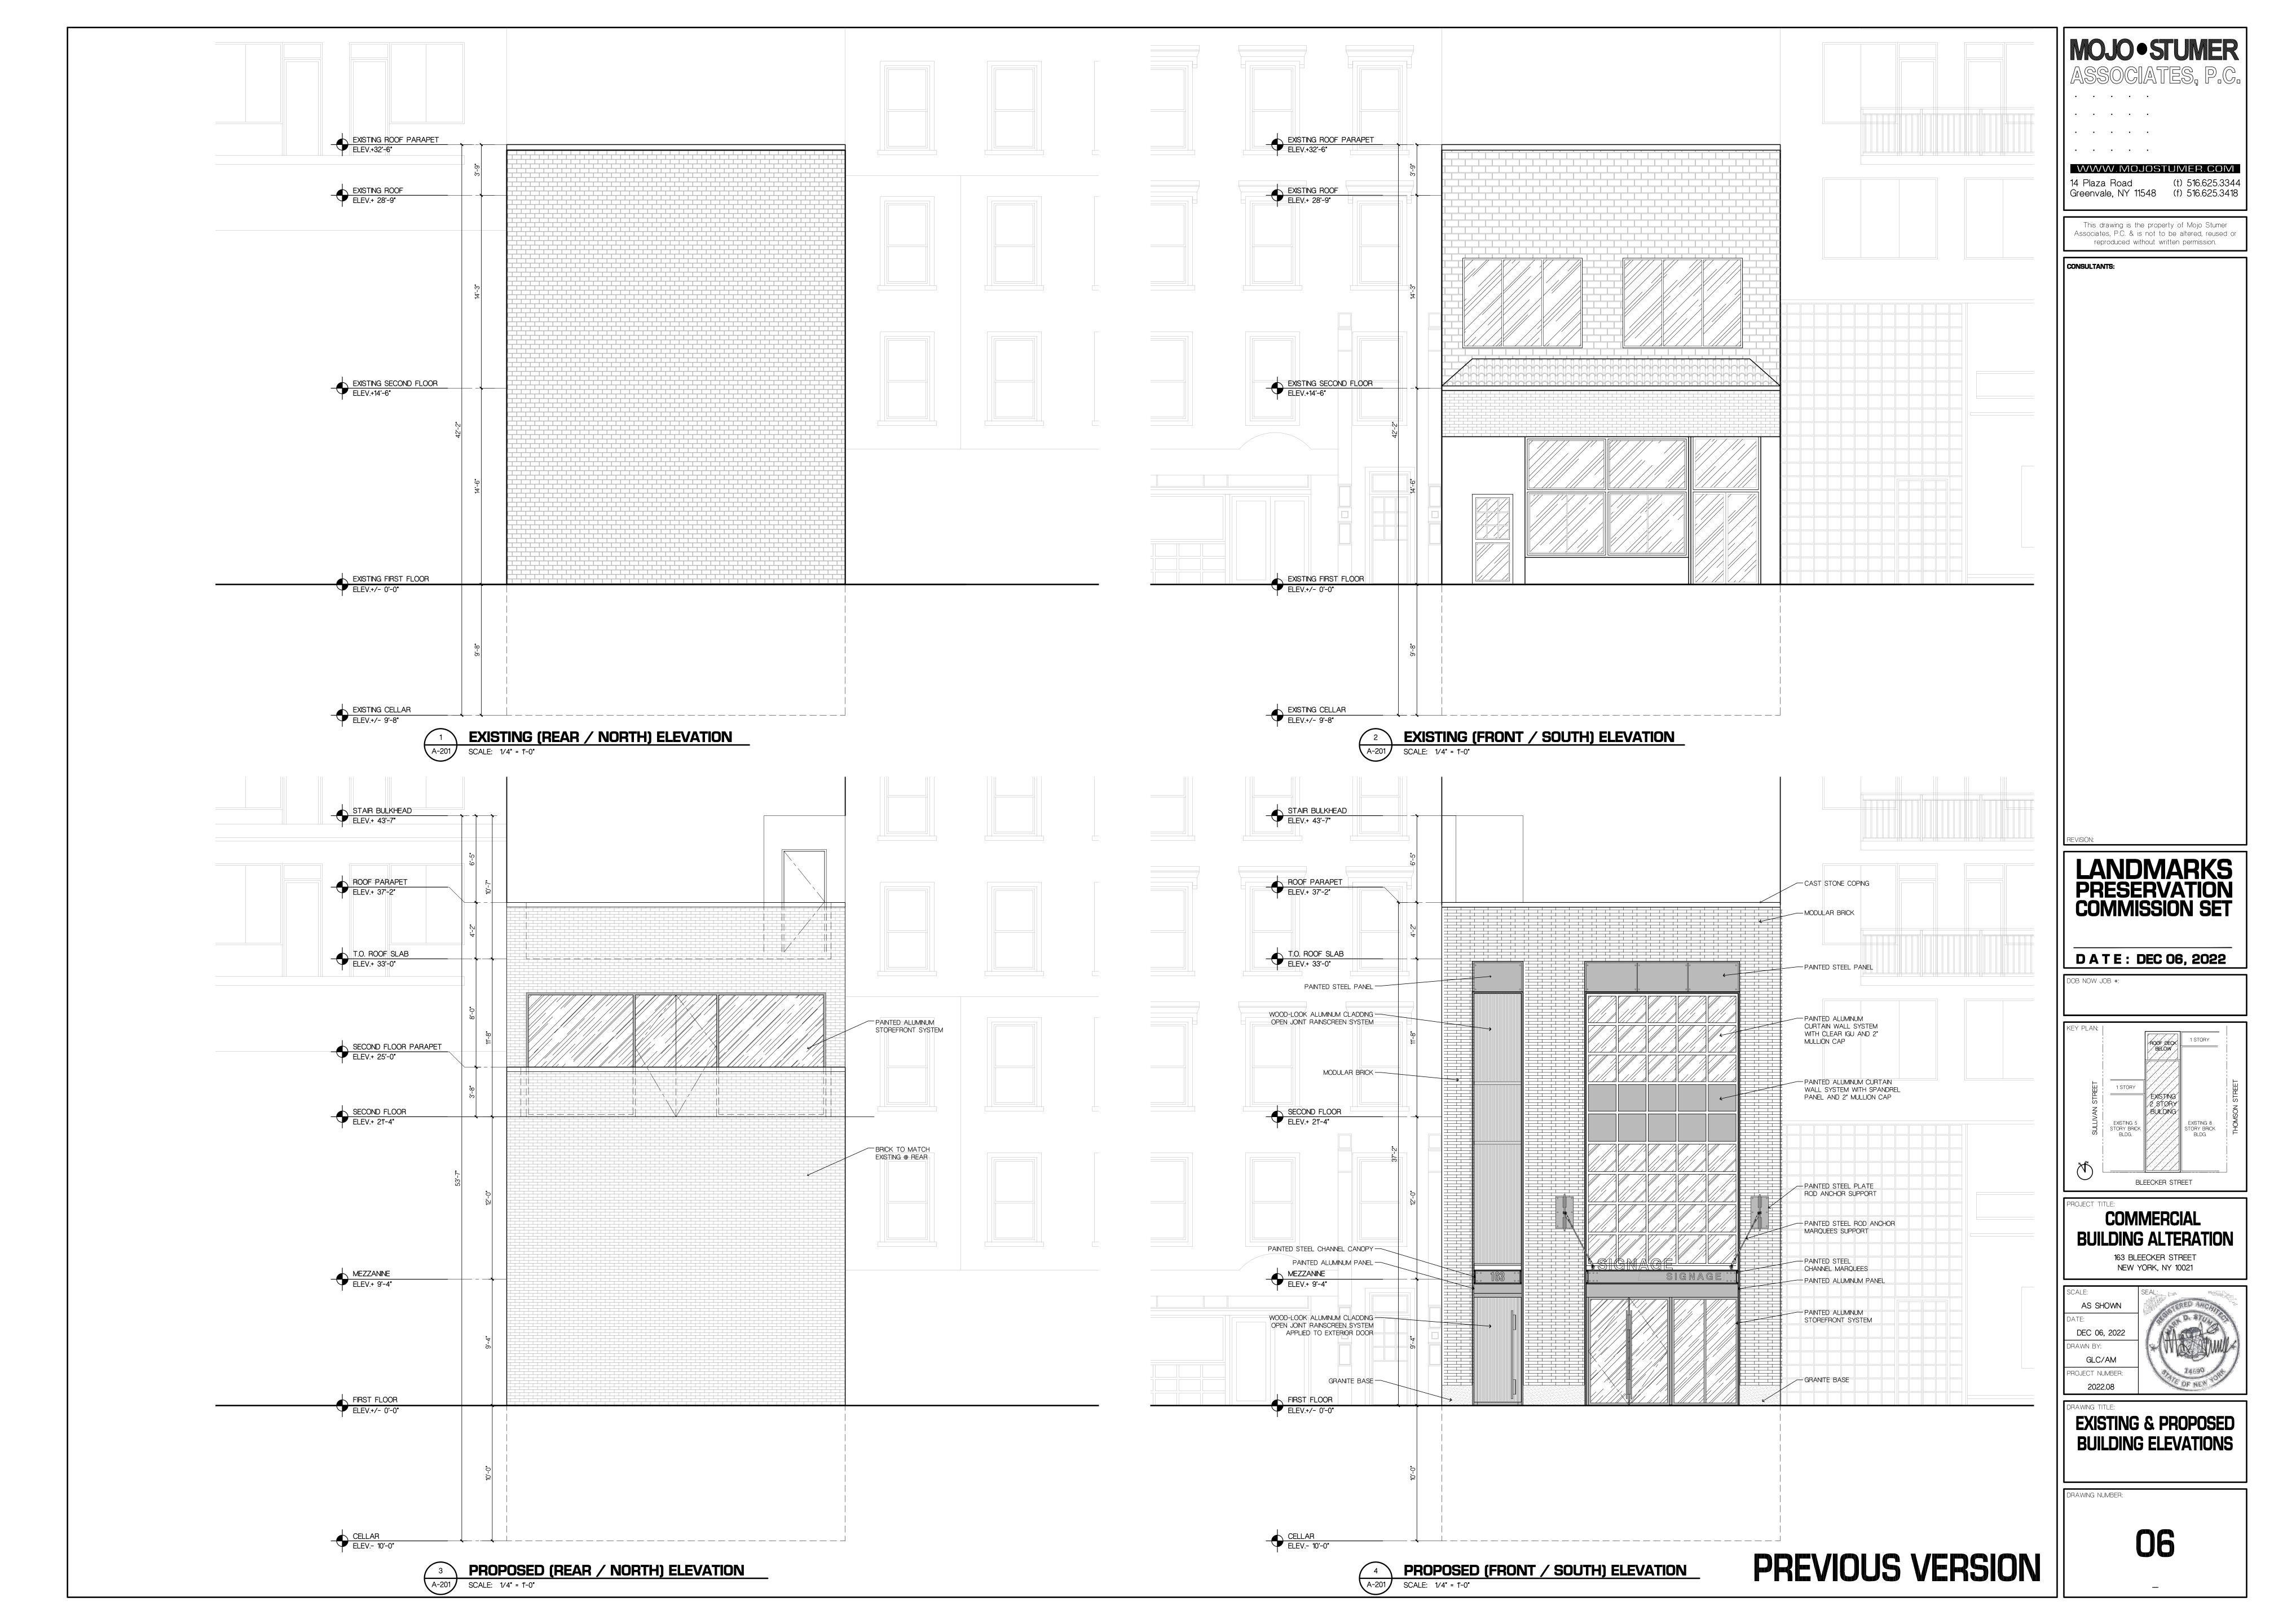

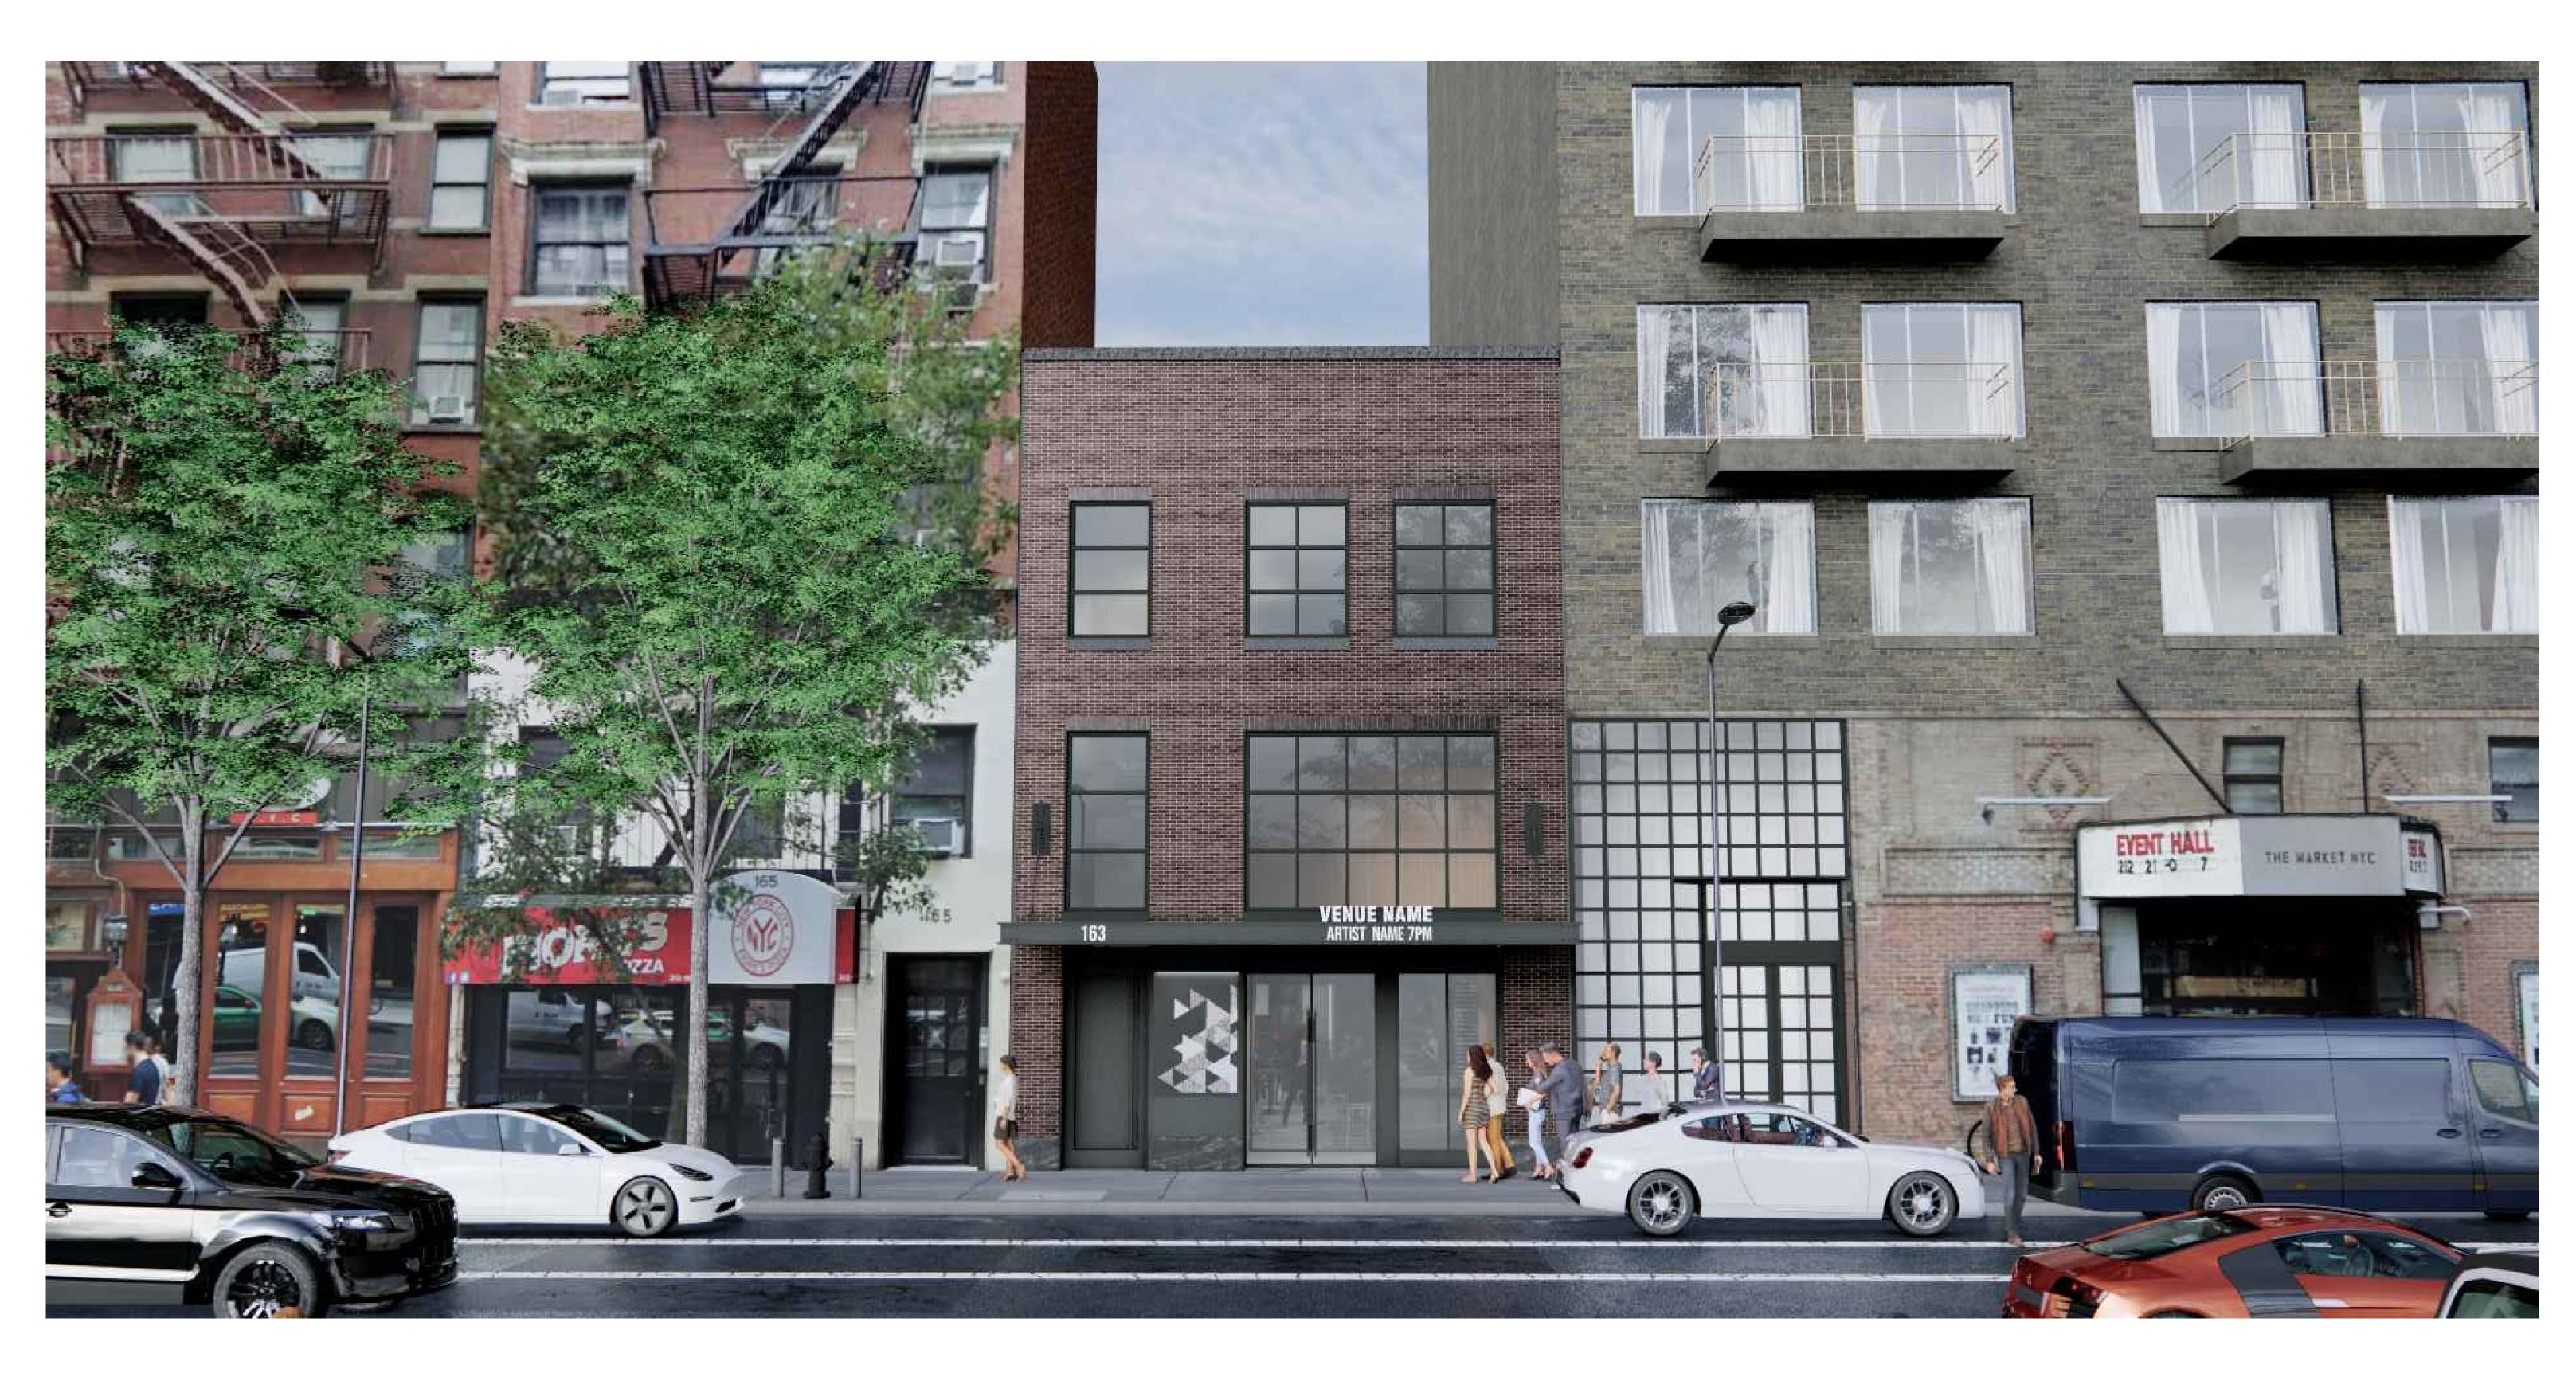

163 BLEECKER STREET PROPOSED FACADE RENDERING

G-007) SCALE: NTS - (PLEASE NOTE, SMALL TREE TO BE PLACED IN FRONT OF BUILDING INTENTIONALLY LEFT OUT TO VIEW FACADE IN ITS ENTIRETY)

163 BLEECKER STREET | SOUTH VILLAGE HISTORIC DISTRICT IN NEW YORK CITY PROPOSED BUILDING RENOVATION | FACADE DESCRIPTION

The proposed renovation of 163 Bleecker Street comes after a 2020 fire caused significant damage to the structure. Prior to the fire, the building's architecture held little historic value, with the South Village Historic District Designation Report listing it as a "No Style" Factory Building.

The original structure built in 1892 by Charles E. Hadden was modest in its conception and detailing, displaying little to no ornate character on its exterior wall surfaces, an all-glass ground level storefront, and two large windows placed at its second level.

Major façade renovations in the years 1931, 1980, and 1993 resulted in a façade of various modern and thematic styles, including a partial faux pagoda roof structure directly below the second-floor windows, with no aesthetic connection to the fabric of the South Village Historic District.

In the currently proposed renovation, the building will be repurposed for use as a live music venue, tying into the long and storied history of the Greenwich Village music scene, but it will also receive a new façade designed to carefully reintegrate the building back into the fabric of the South Village Historic District neighborhood and into the context of the block in which it is located.

The Facade Design at 163 Bleecker aims to unify the block, as the site and existing building creates a visual gap between the buildings to the east and west sides between Thompson and Sullivan streets.

The contextual fabric of the existing street wall is made up of single and double story ground floor storefront with residential type punched windows populating the upper floors.

Both the single and double story storefronts from the block are brought through the new facade by way of alignments with the marquees above the ground floor entrance systems and the top of the double height entry window of the venue. The dark framed and paneled storefront, in its color and proportioning, alludes to some of the great examples found throughout the District, such as at 80 West 3rd Street (Amity Hall) and 219 Thompson Street (Chess Forum).

The second floor windows are split into three separate punched openings between masonry piers reflecting the tripartite arrangements found typically on the block and throughout the District. Although the second floor of the venue is dedicated to venue support offices, we thought it was important to maintain the residential window texture on the upper level to reinforce the integration of the new building with the existing adjacent

We noticed diverse color ranges in brick throughout the district, with tones usually in red, brown, and gray. Brick selection for the facade at 163 Bleecker gravitated towards red with some of the bricks having a reddish gray tone to help synthesize and maintain streetwall continuity along the block.

The proposed brick also balances the dark gray window and door frames inserted with the masonry frame surround of the facade. The brick size is modular to maintain dimensional uniformity with the rest of the South Village Historic District.

Regarding the marquee, it follows examples found at 179 Sullivan Street and 80 West 3rd Street. Similar to 179 Sullivan, it will also use a dark painted steel channel. The name of the venue is proposed to be placed at the top of the marquee in light colored lettering. A separate LED illuminated sign is proposed to be placed within the channel flanges to announce scheduled venue events.

With respect to the acoustical design, the venue is planned to include a ground floor vestibule to mitigate sound output from within the main space of the venue to the street. The interior perimeter walls will be lined with wall framing and sheathing but connected with isolation clips to prevent sound vibration from transferring through the walls. Interior materials will also be carefully selected to absorb noise and keep it within the venue.

Our goal behind the Facade Design at 163 Bleecker was to connect it as a natural extension of the immediate adjacent buildings and prevent it from appearing like a forced insertion into the existing facade fabric on its block.

We took the opportunity to integrate the existing structure back into the historical fabric found in the South Village Historic District through use of typological storefront and window systems, proportionality, and material, while also reintroducing the sense of vibrancy and character that epitomized the periods of beatnik and bohemian rediscovery of the Village.


Greenvale, NY 11548 (f) 516.625.3418

ssociates, P.C. & is not to be altered, reused or reproduced without written permission

LANDMARKS PRESERVATION COMMISSION SET

DATE: DEC 06, 2022

DOB NOW JOB #:

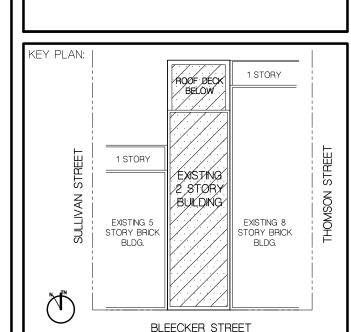

COMMERCIAL BUILDING ALTERATION 163 BLEECKER STREET

NEW YORK, NY 10021 PROJECT NUMBER:

2022.08 **163 BLEECKER STREET** PROPOSED FACADE RENDERING



WWW.Midjostumer.com

14 Plaza Road (t) 516 625 3344
Greenvale, NY 11548 (f) 516 625 3448

This drawing is the property of Mojo Stumer Associates, P.C. & is not to be altered, reused or reproduced without written permission.

LANDMARKS PRESERVATION COMMISSION SET

D A T E : DEC 06, 2022

DOB NOW JOB #:

COMMERCIAL
BUILDING ALTERATION

163 BLEECKER STREET
NEW YORK, NY 10021

SCALE:

AS SHOWN

DATE:


DEC 06, 2022

DRAWN BY:

GLC/AM

PROJECT NUMBER:


2022.08

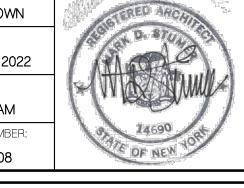

163 BLEECKER STREET
EXISTING & PROPOSED
ELEVATIONS

DRAWING NUMBER:



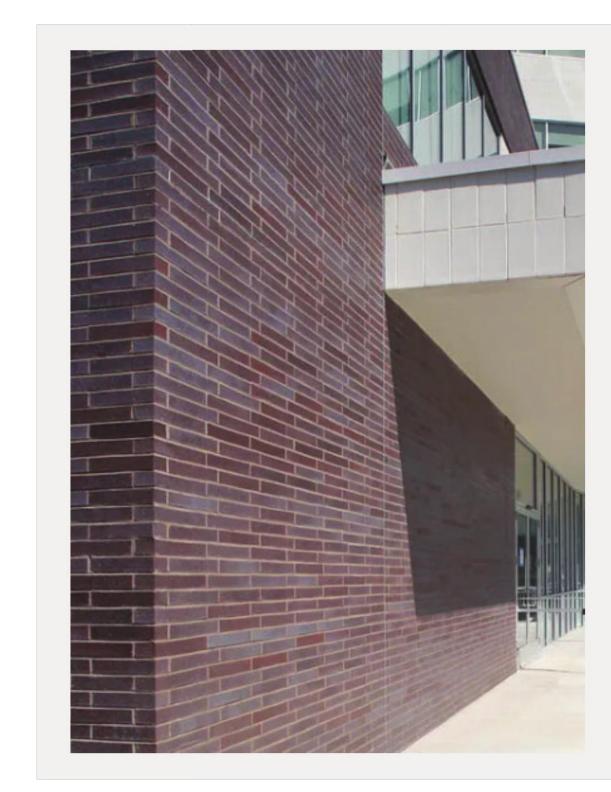

BRICK


ASHBERRY VELOUR (MODULAR SIZE BRICK)
BY BELDEN TRI-STATE OR EQUAL
WITH WCB-125 MORTAR



METAL

DON GREY (LOT #073119 DARK GREY COLOR) BY ALPOLIC OR EQUAL



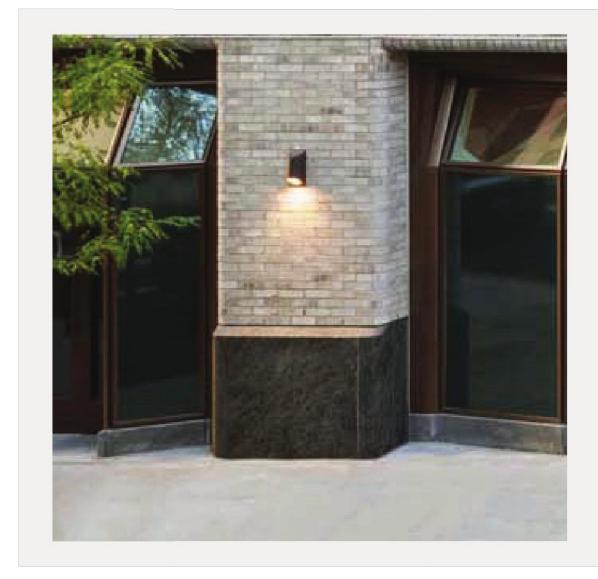

STONE

JET MIST GRANITE BY UNIQUE STONE CONCEPTS OR EQUAL





MOJO • STUMER ASSOCIATES, P.C.

WWW.MOJOSTUMER.COM

14 Plaza Road (t) 516.625.3344

Greenvale, NY 11548 (f) 516.625.3418

This drawing is the property of Mojo Stumer Associates, P.C. & is not to be altered, reused or reproduced without written permission.

CONSULTANTS:

LANDMARKS PRESERVATION COMMISSION SET

D A T E : DEC 06, 2022

NOW JOB #:

EXISTING 8
STORY BRICK
BLDG.

I STORY

EXISTING
2 STORY
BUILDING

EXISTING 8
STORY BRICK
BLDG.

COMMERCIAL
BUILDING ALTERATION

163 BLEECKER STREET

163 BLEECKER STREET NEW YORK, NY 10021

SCALE:

AS SHOWN

DATE:

DEC 06, 2022

DRAWN BY:


GLC/AM


PROJECT NUMBER:

2022.08

MATERIAL
PALETTE

DRAWING NUMBER

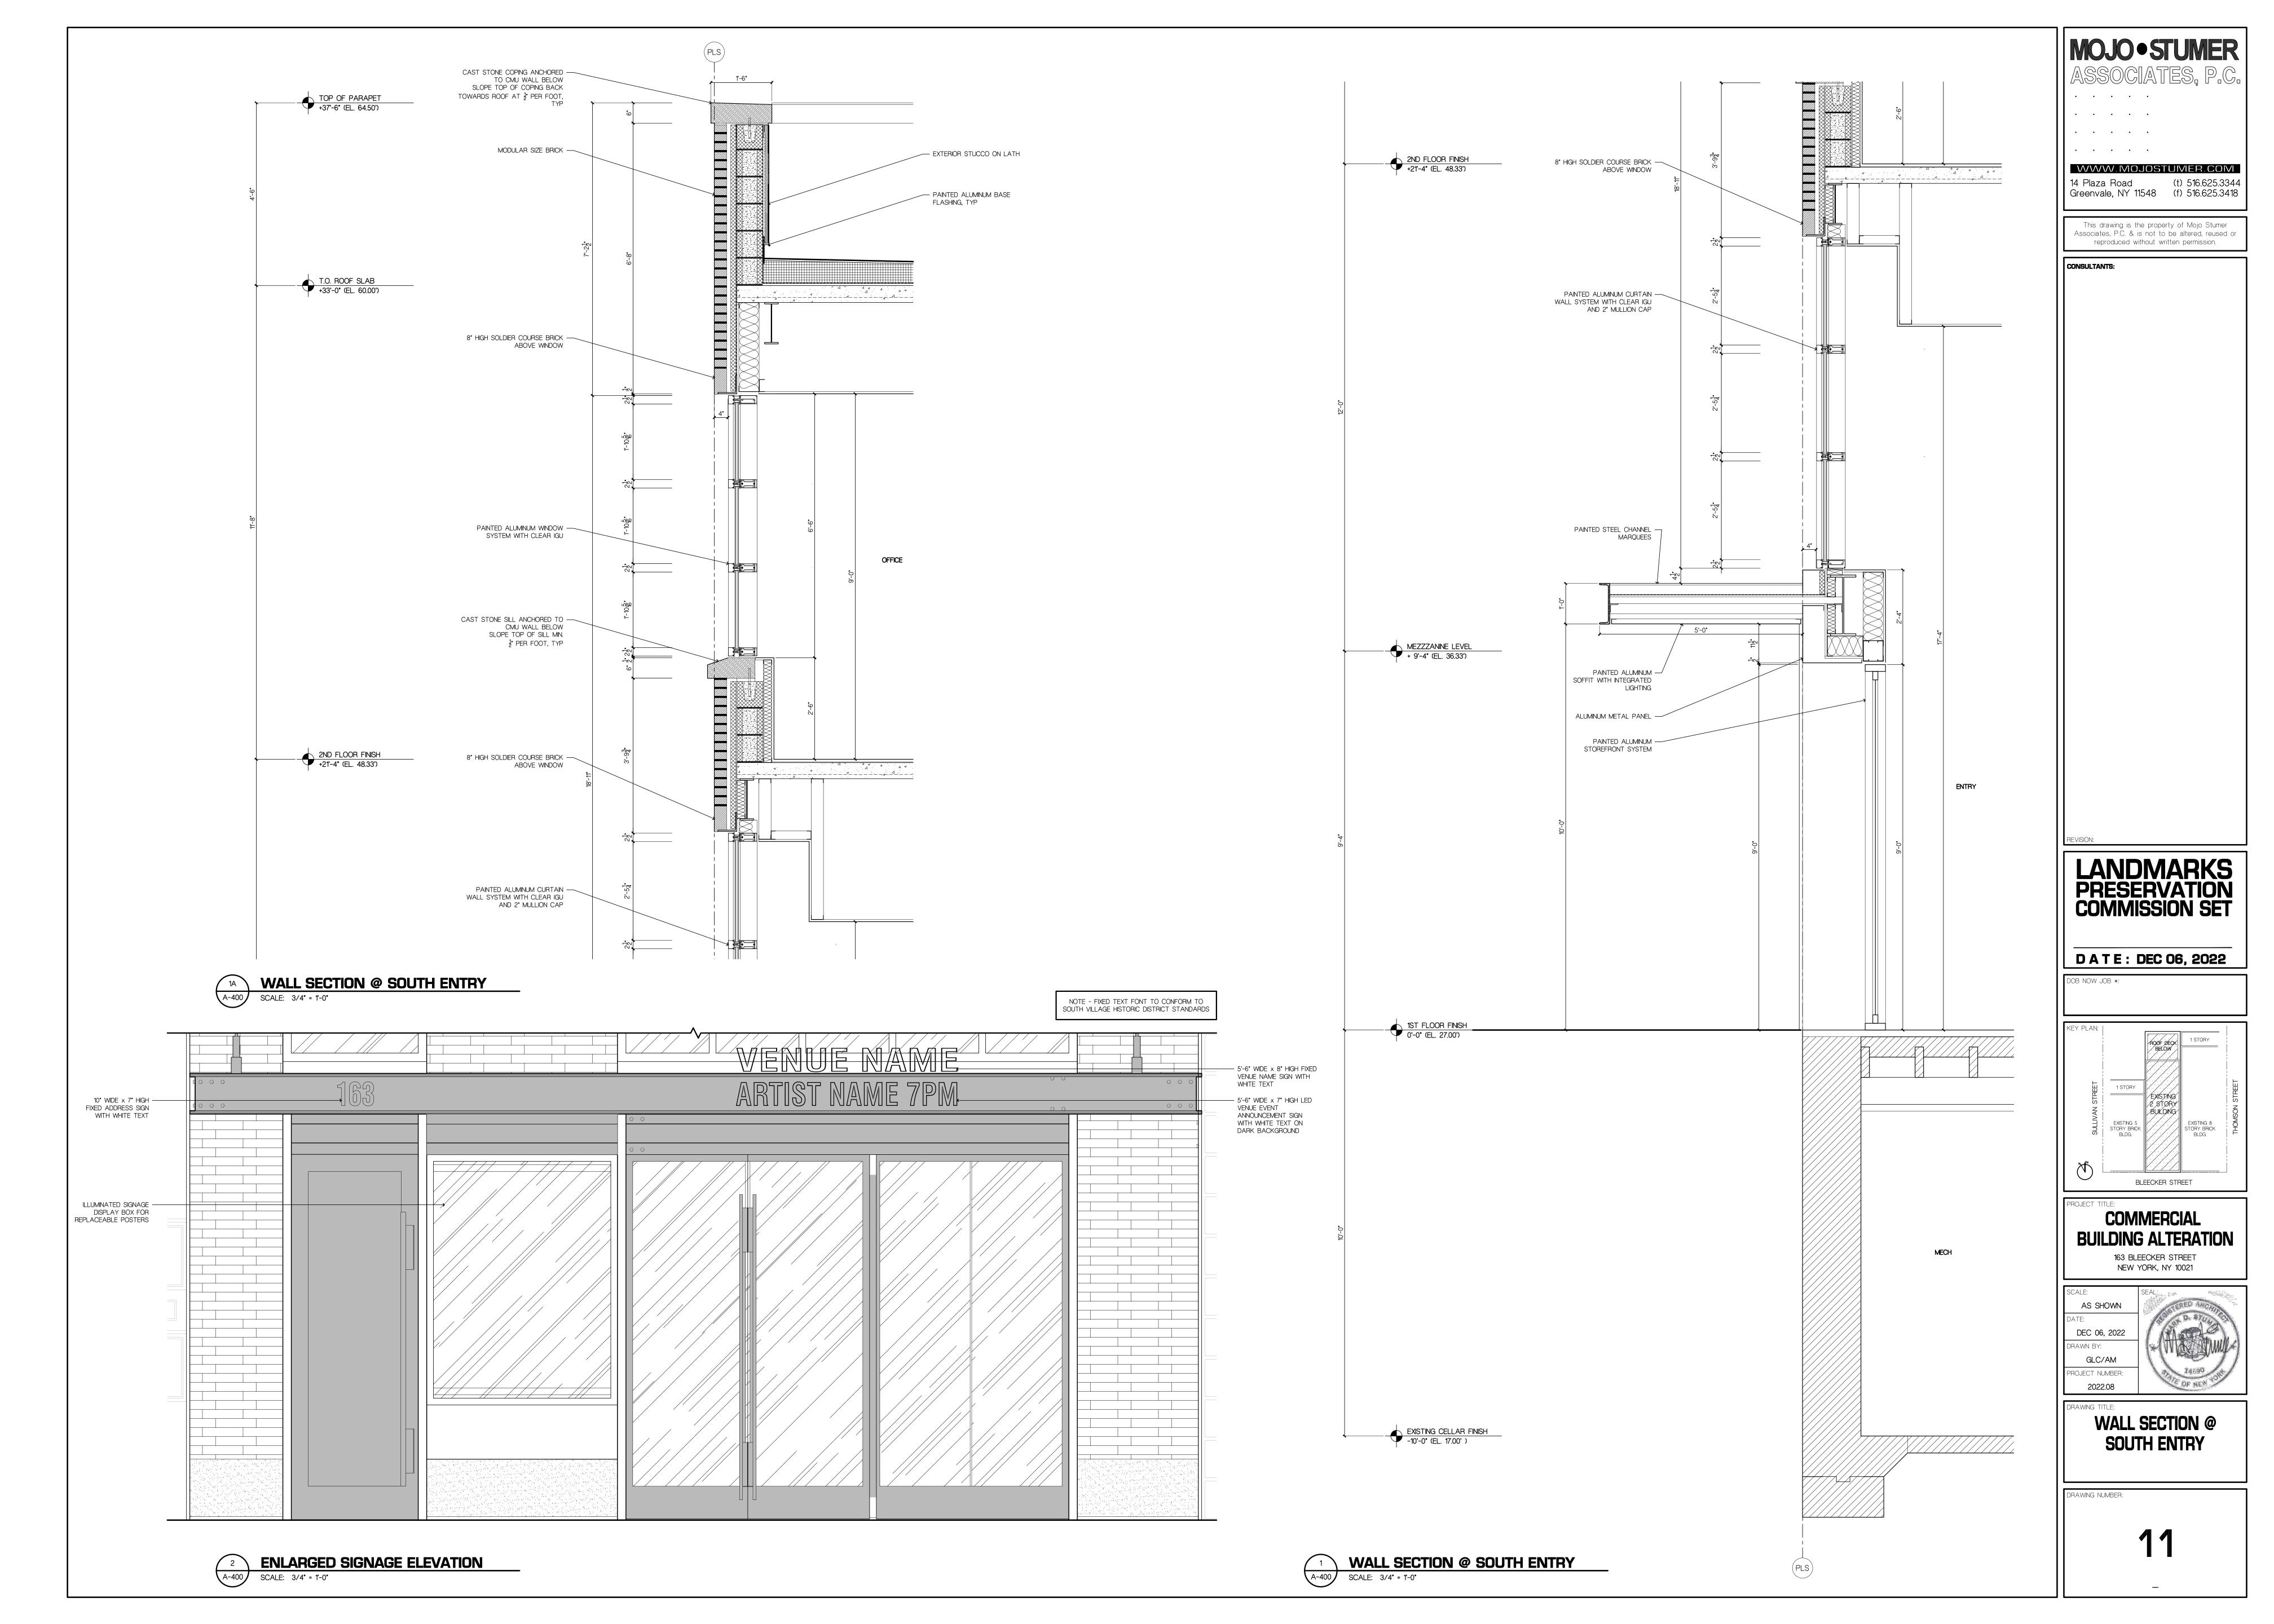

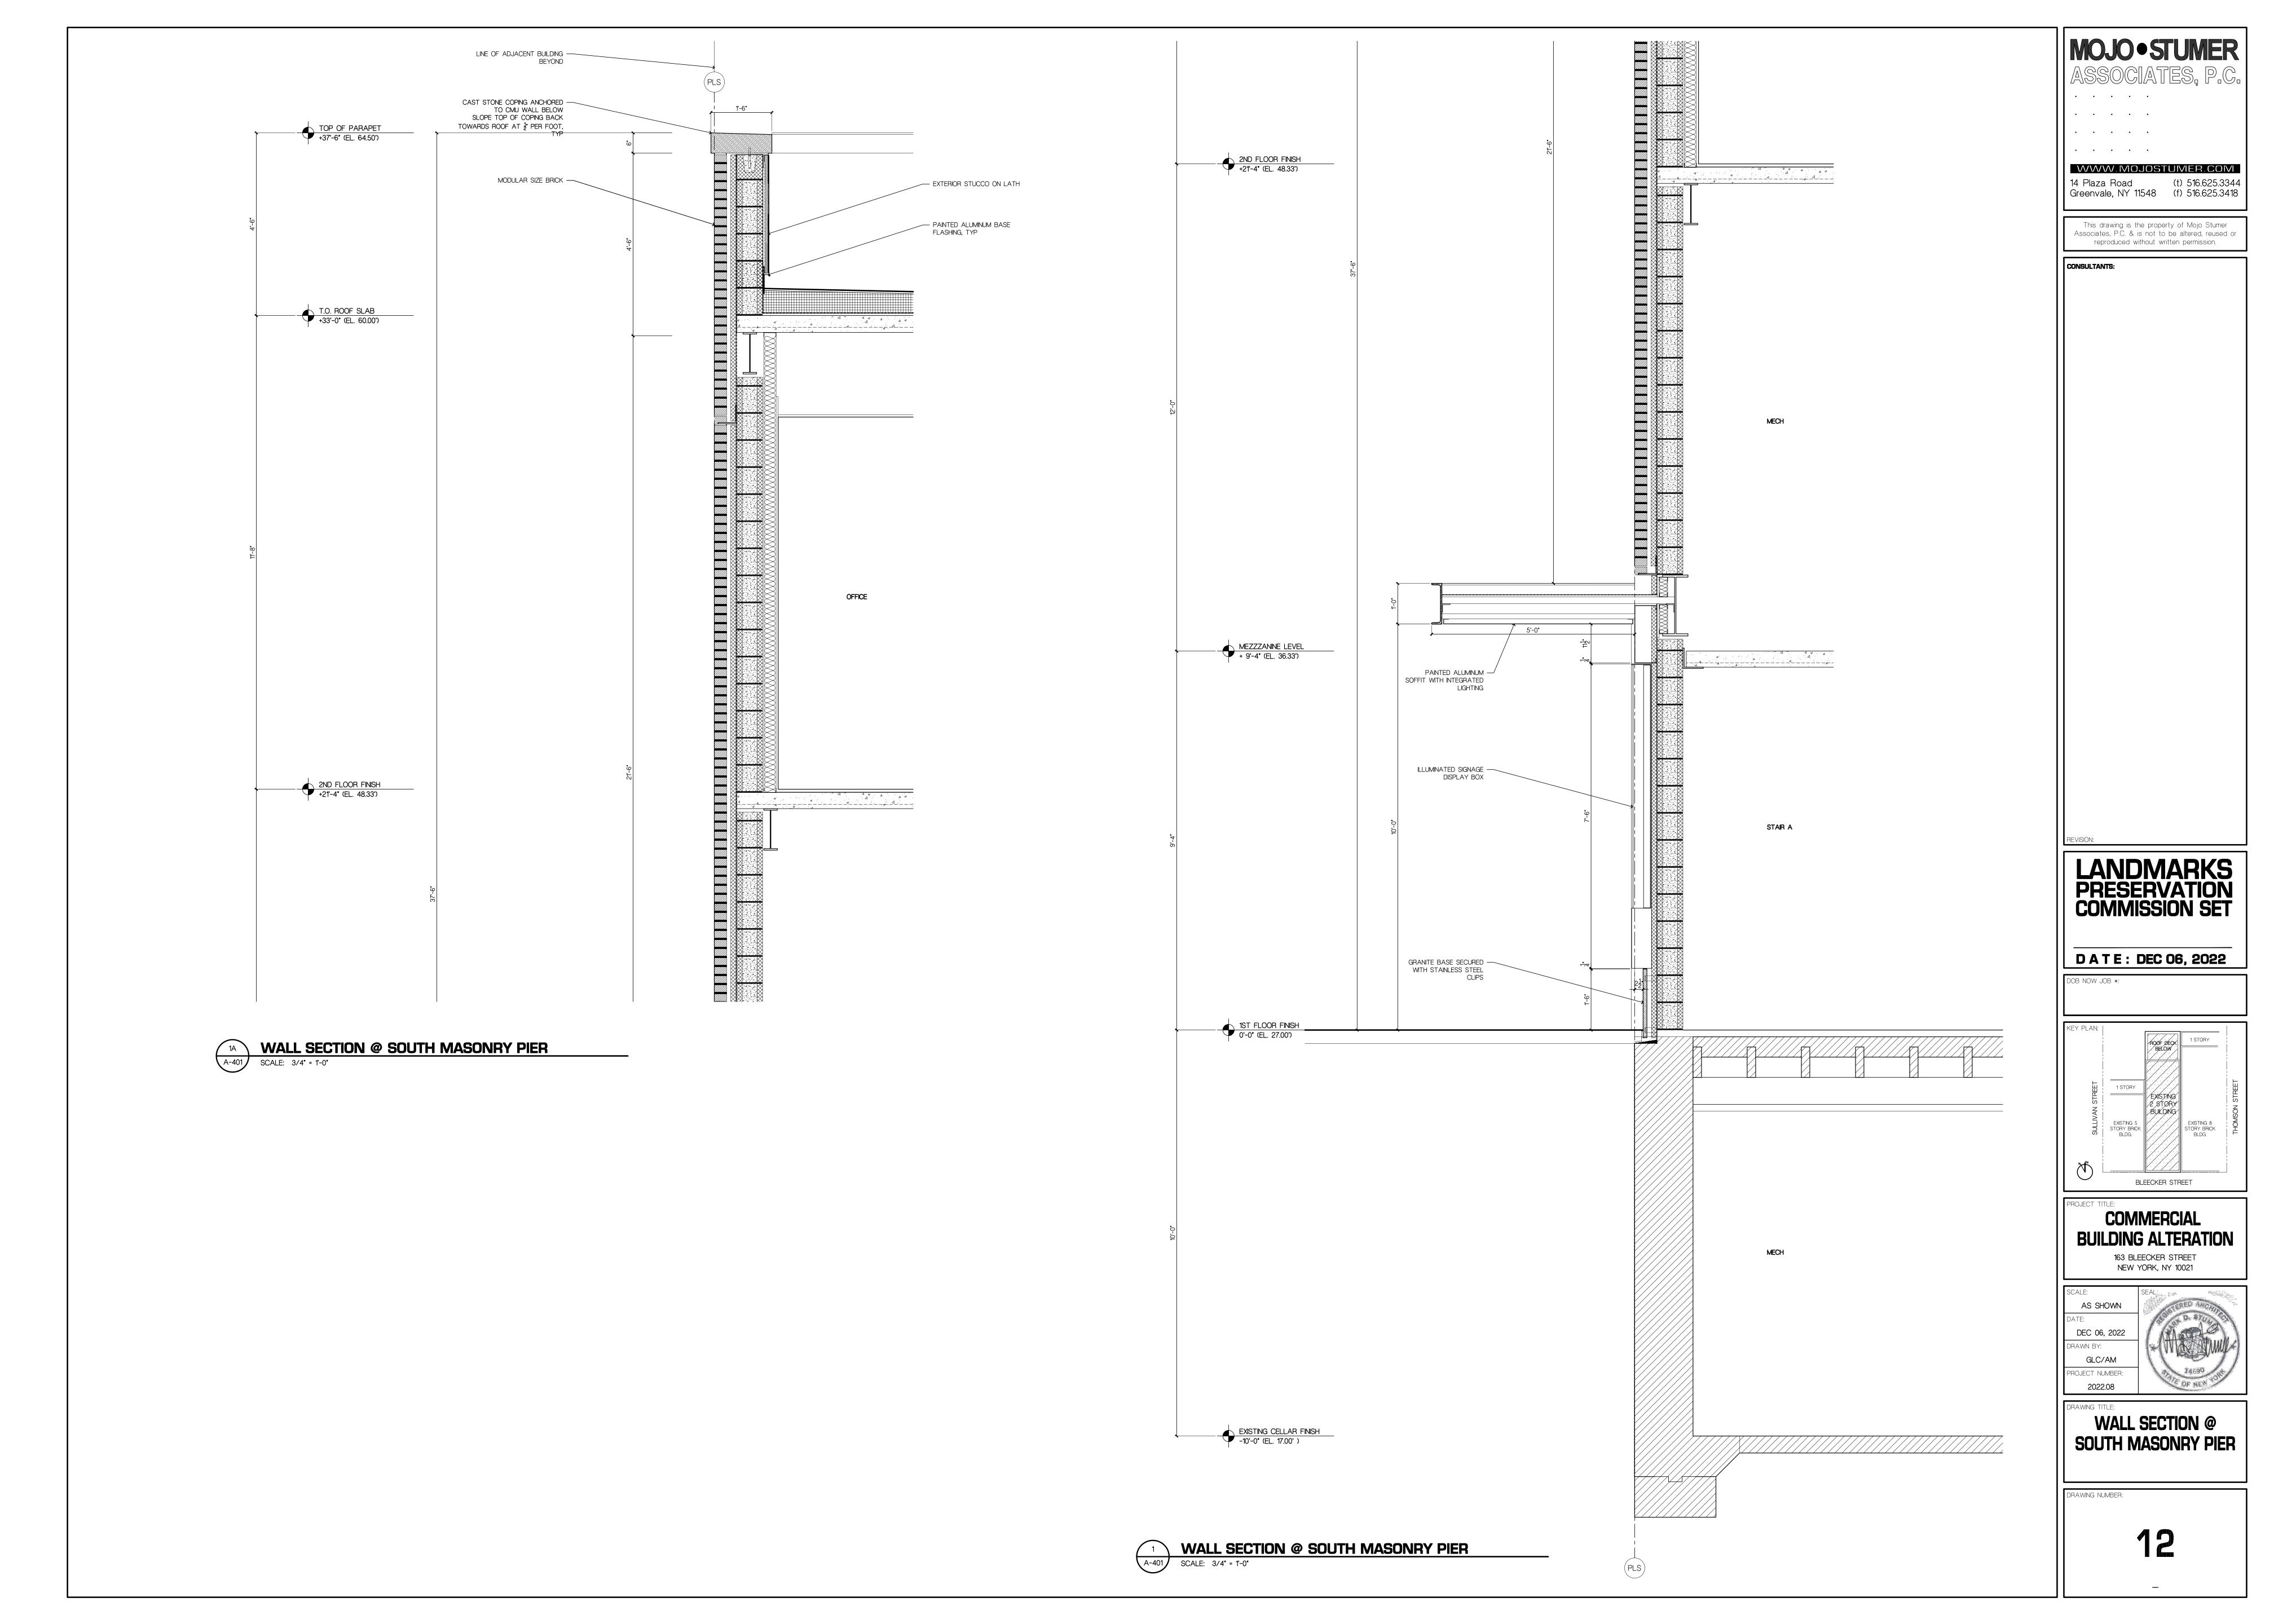




APPENDIX









155 BLEECKER

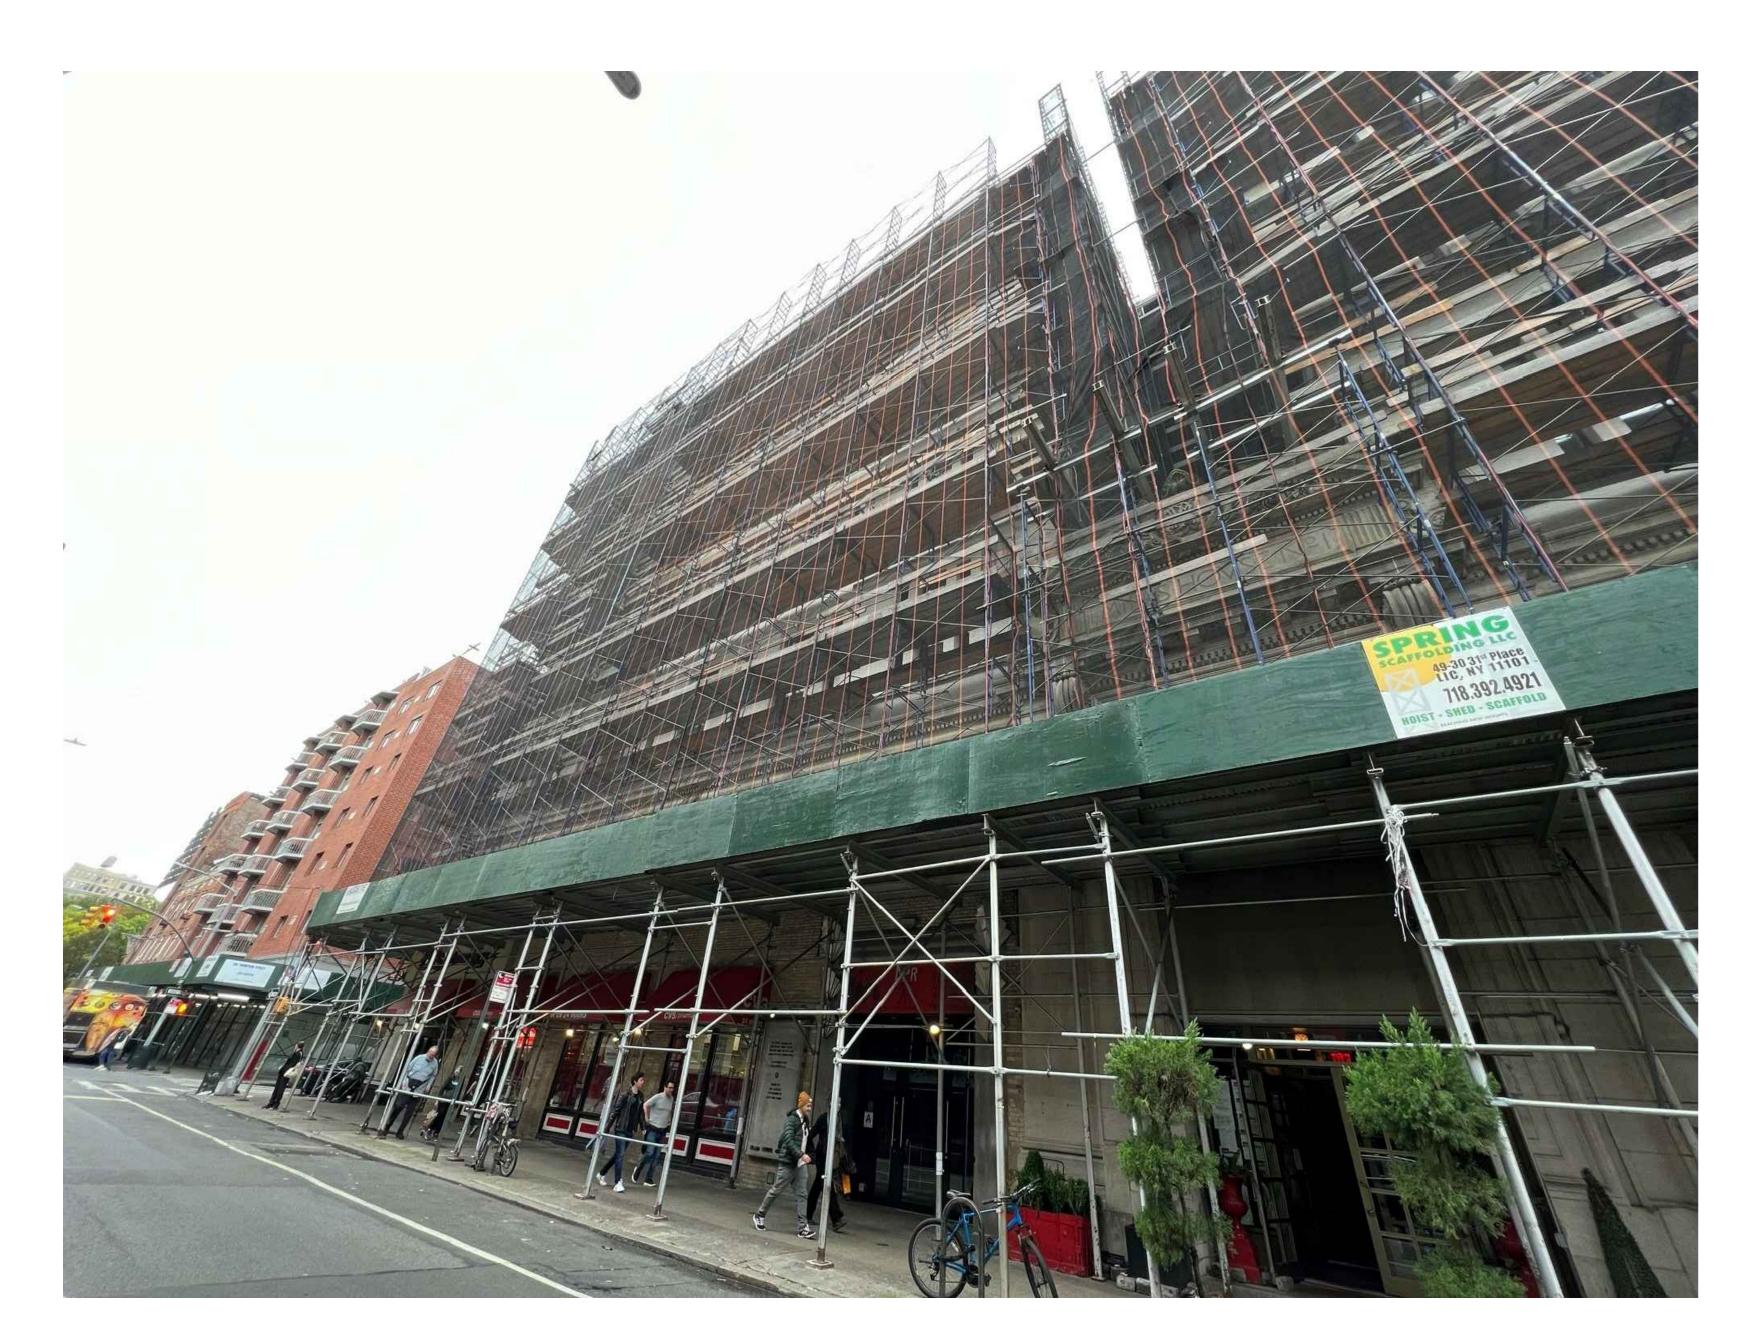

160 BLEECKER STREET LOOKING SOUTHEAST

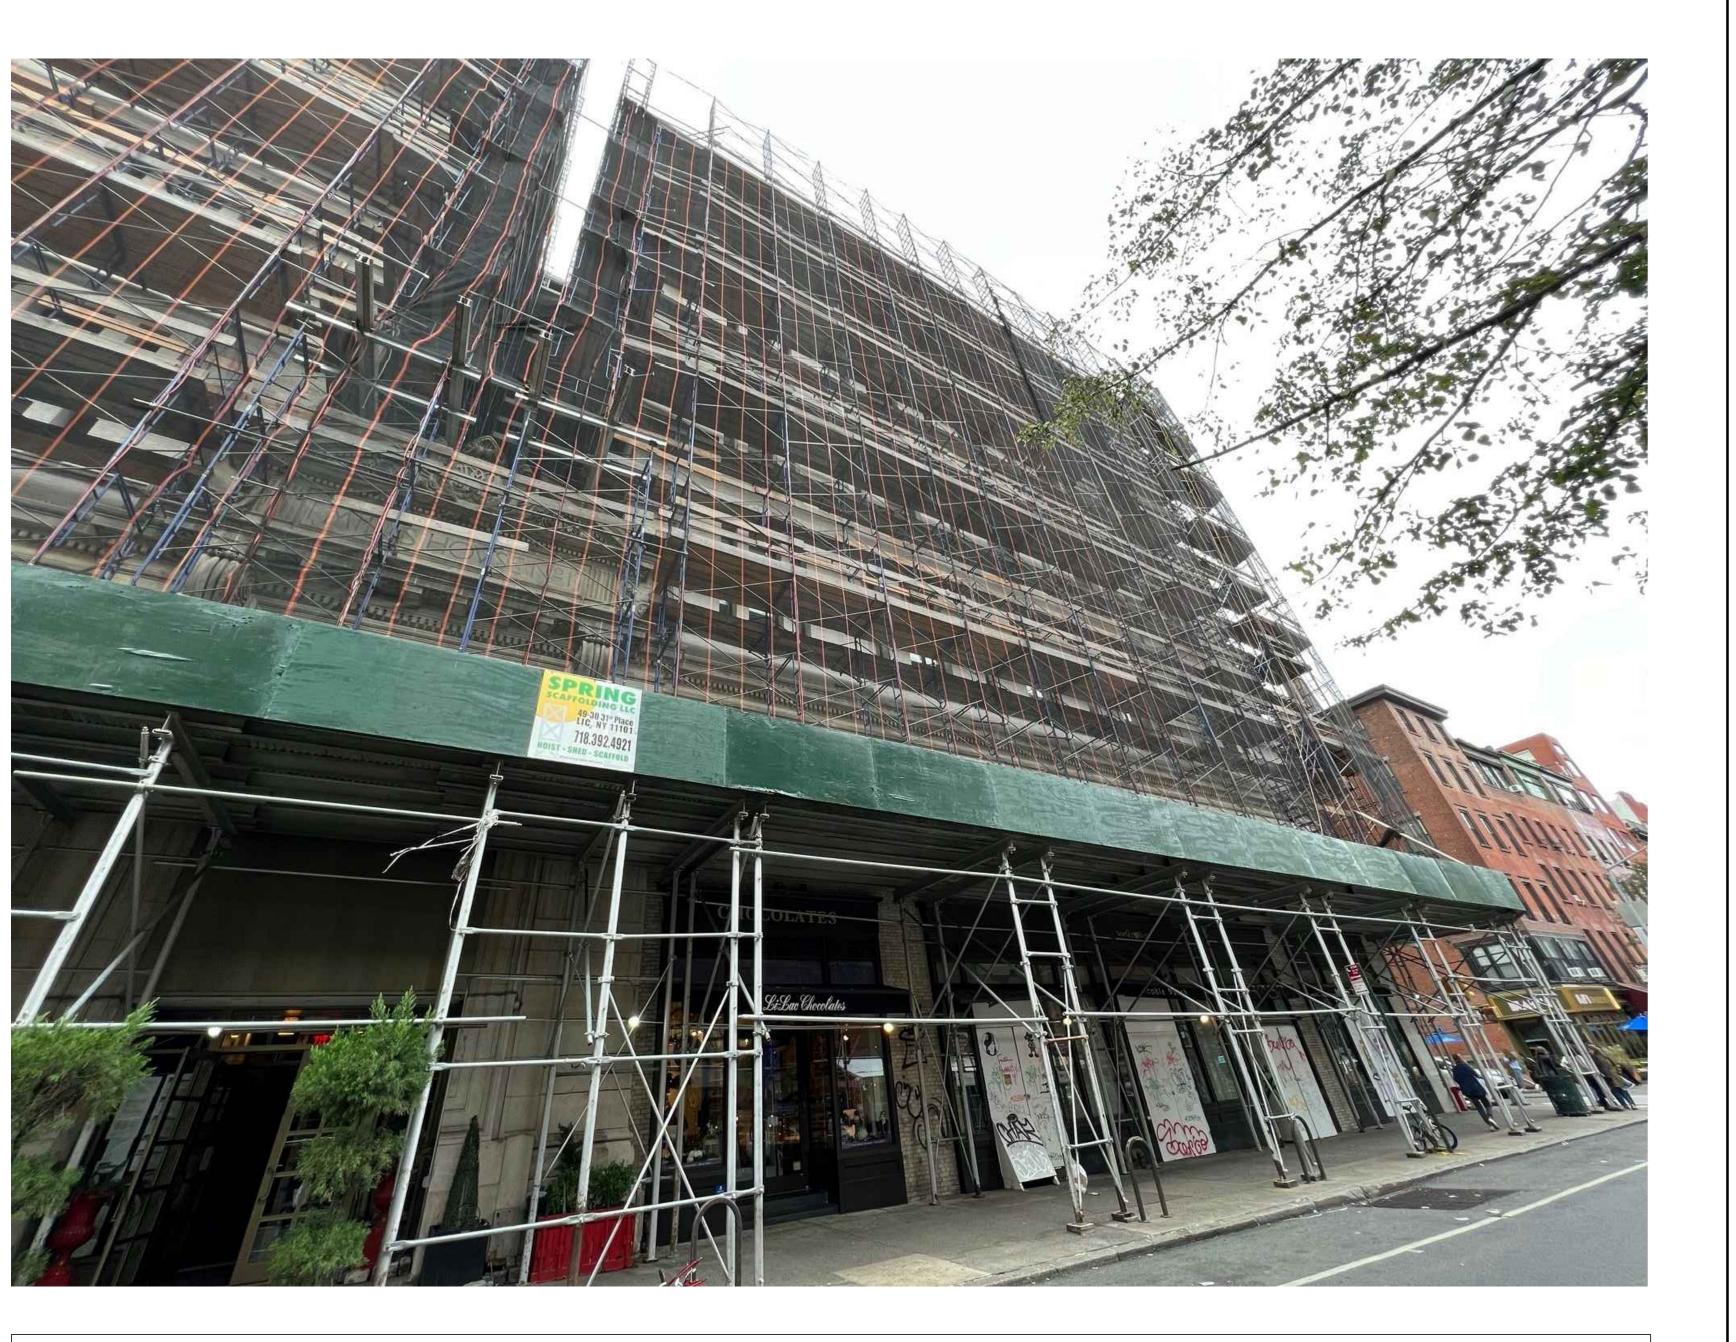


160 BLEECKER STREET LOOKING SOUTHWEST

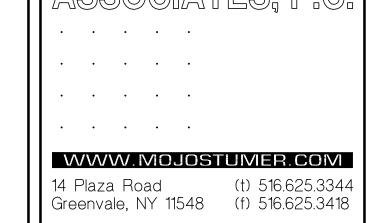

This drawing is the property of Mojo Stumer Associates, P.C. & is not to be altered, reused or reproduced without written permission.




DATE: DEC 06, 2022

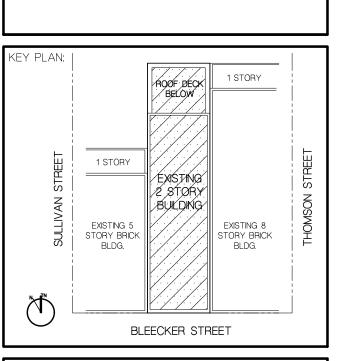


COMMERCIAL **BUILDING ALTERATION** 163 BLEECKER STREET NEW YORK, NY 10021

160 BLEECKER STREET + 155 AND 169 EXISTG BUILDING PHOTOS

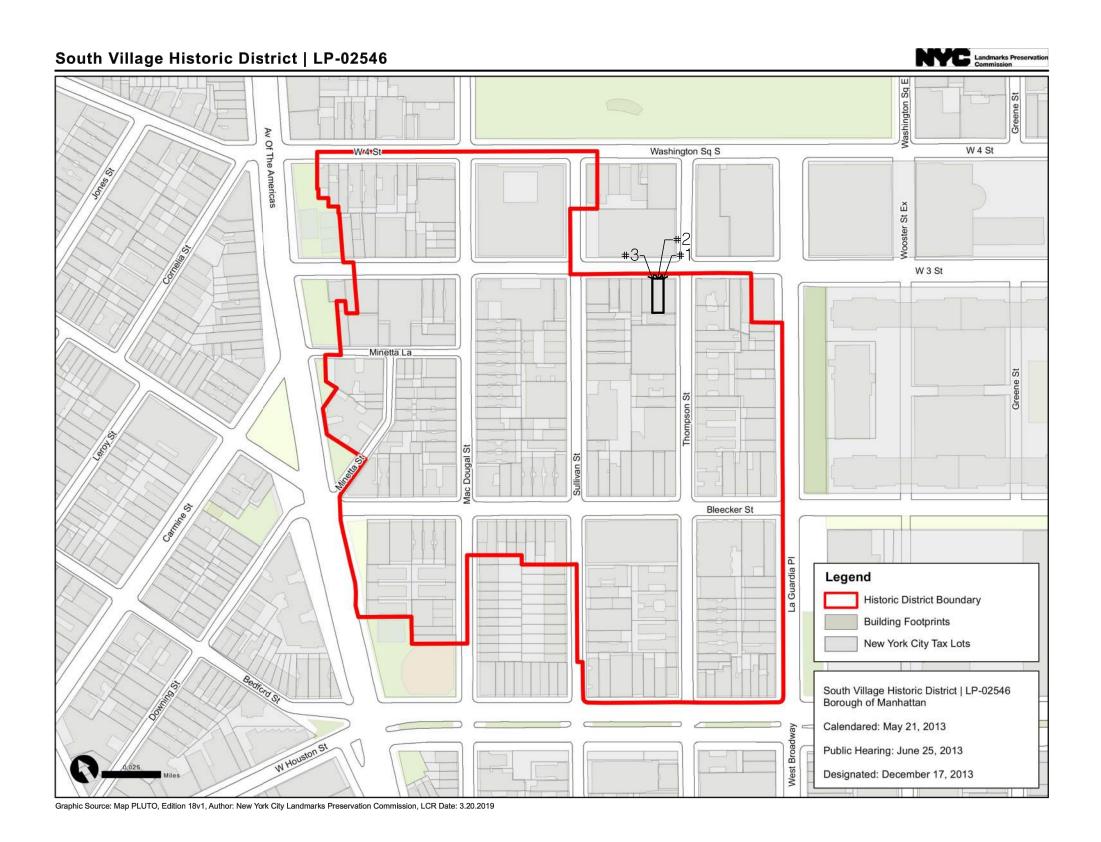

KEY MAP

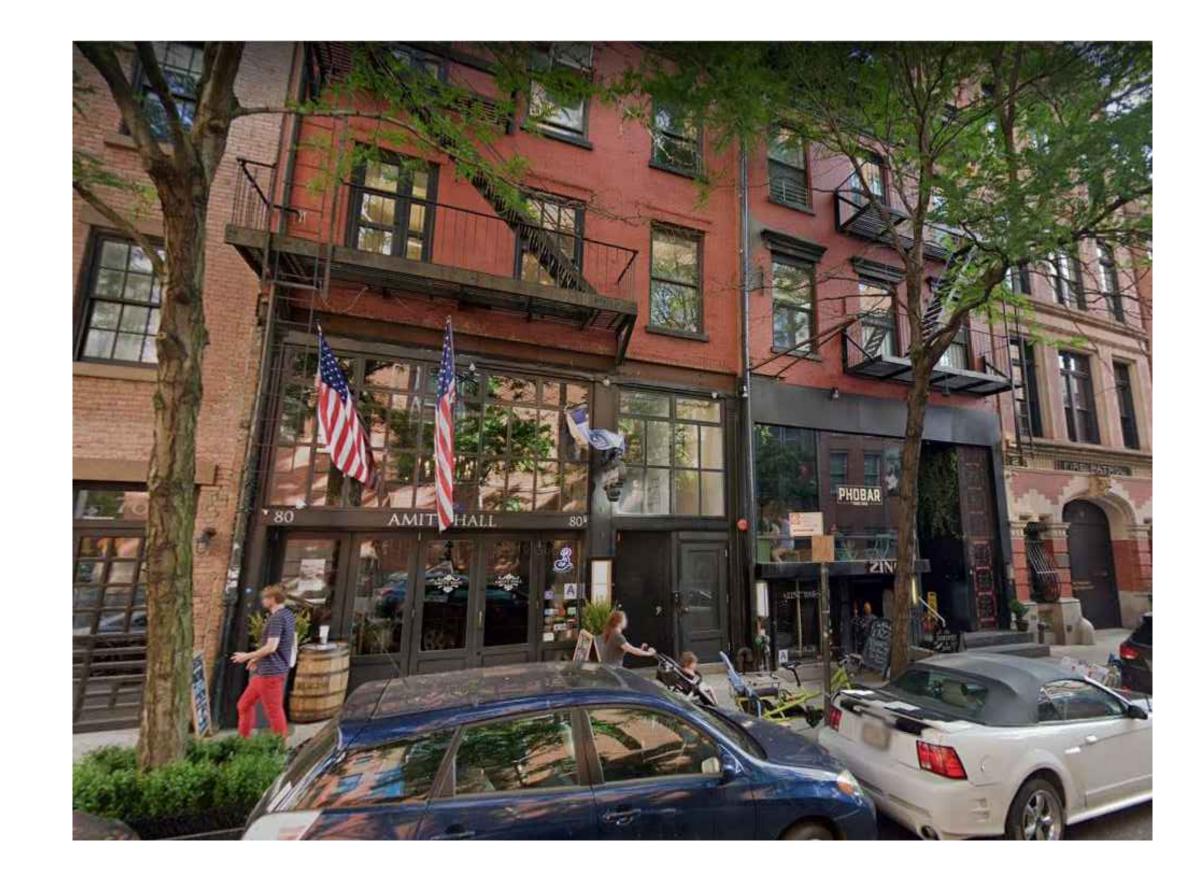


80 WEST 3RD STREET - PHOTO 1



80 WEST 3RD STREET - PHOTO 2



80 WEST 3RD STREET - PHOTO 3

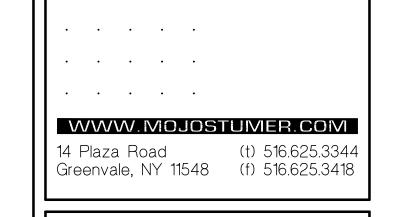


This drawing is the property of Mojo Stumer Associates, P.C. & is not to be altered, reused or reproduced without written permission.

NSULTANTS:

LANDMARKS PRESERVATION COMMISSION SET

D A T E : DEC 06, 2022

DOB NOW JOB #:

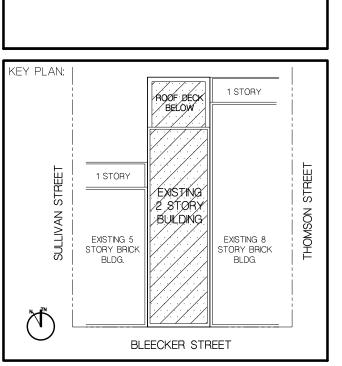

COMMERCIAL
BUILDING ALTERATION

163 BLEECKER STREET
NEW YORK, NY 10021

SCALE:

AS SHOWN

DATE:

DEC 06, 2022


DRAWN BY:

GLC/AM

PROJECT NUMBER:
2022.08

PROJECT REFERENCES
80 WEST 3RD STREET
AMITY HALL PHOTOS

DRAWING NUMBER:

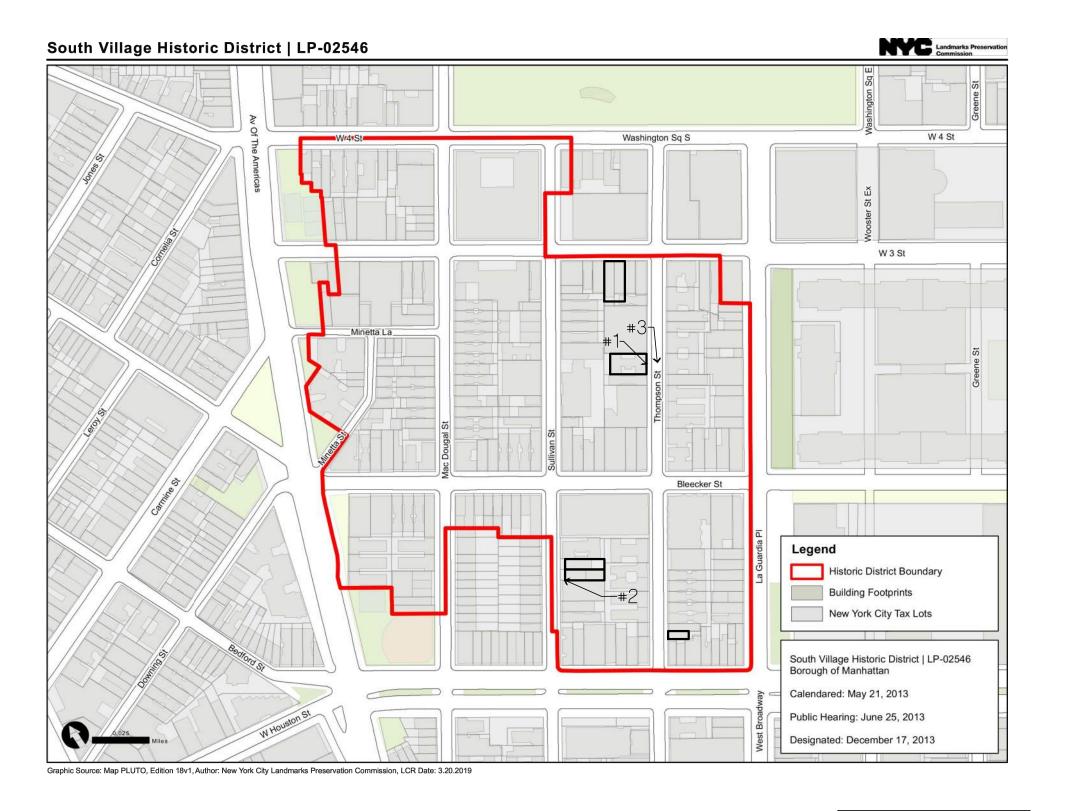


KEY MAP



219 THOMPSON STREET - PHOTO 1



179 SULLIVAN STREET - PHOTO 2

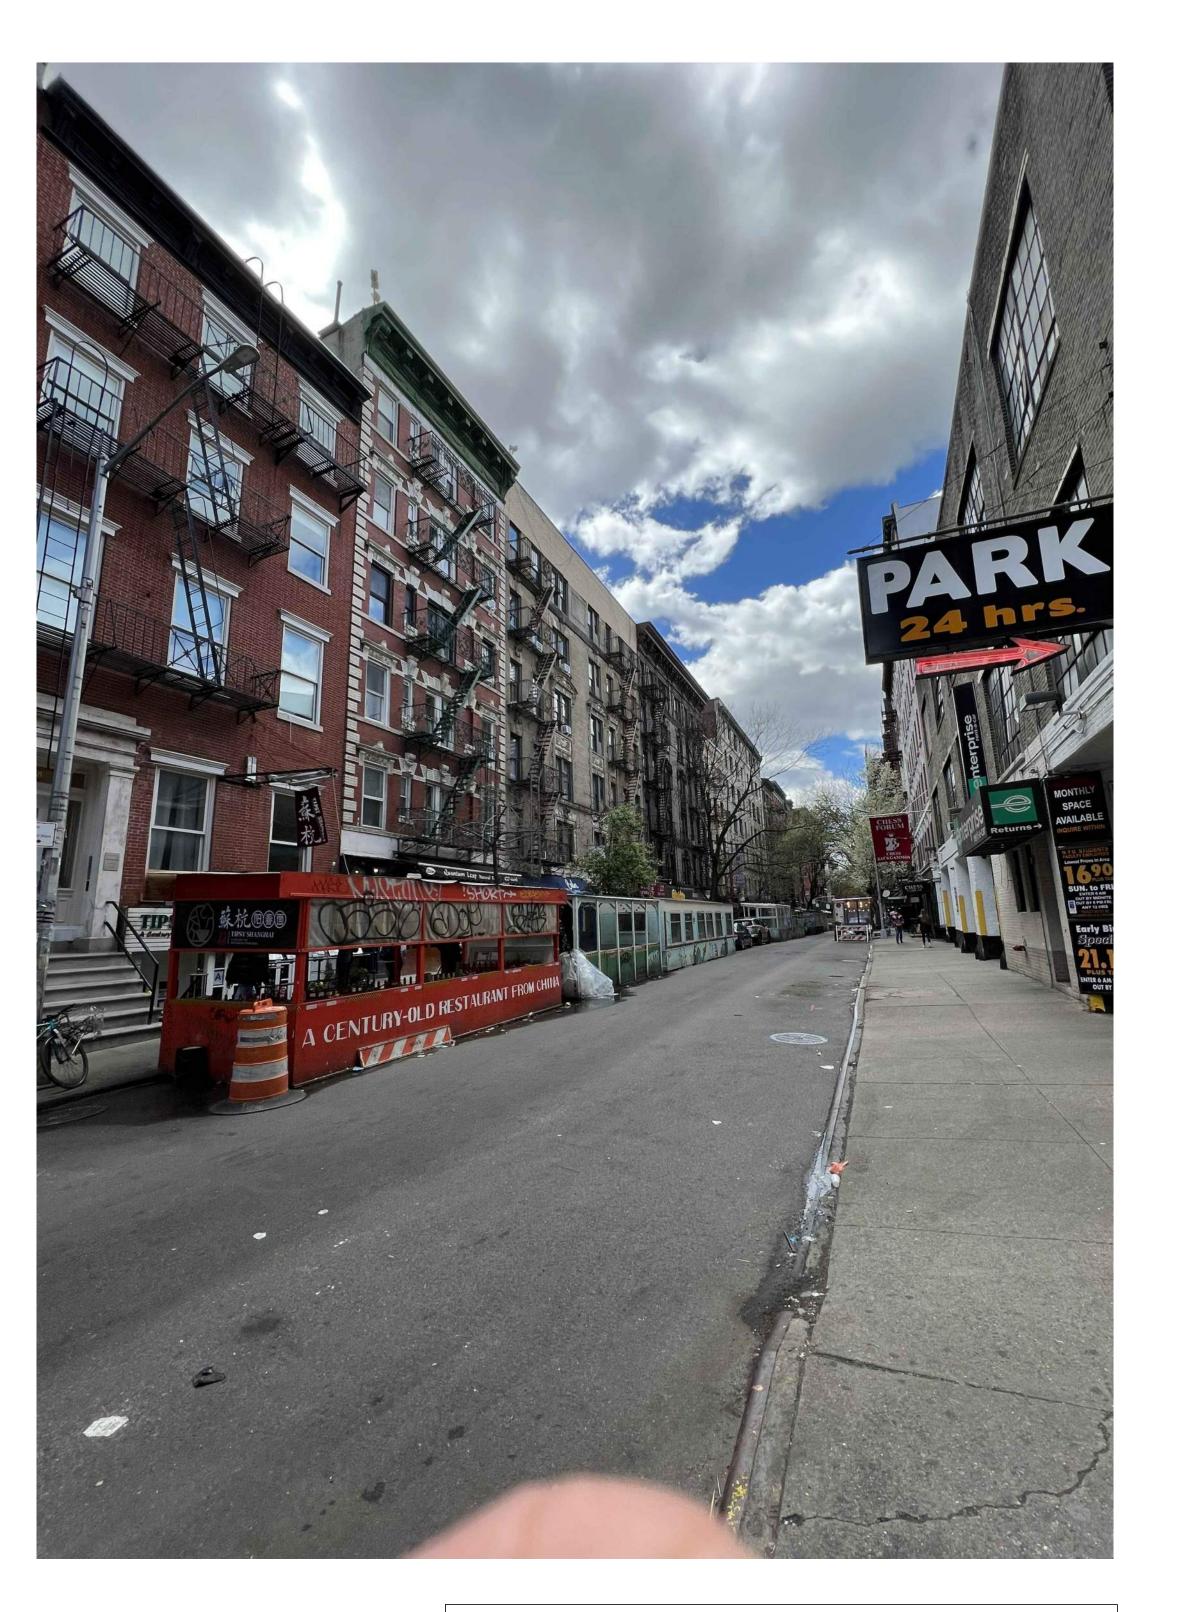

THOMPSON STREET - PHOTO 3




Associates, P.C. & is not to be altered, reused or reproduced without written permission.

CONSULTANTS:

LANDMARKS PRESERVATION COMMISSION SET

DATE: DEC 06, 2022

DOB NOW JOB #:

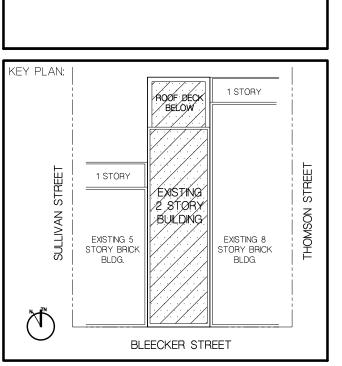

COMMERCIAL
BUILDING ALTERATION

163 BLEECKER STREET
NEW YORK, NY 10021

SCALE:

AS SHOWN

DATE:

DEC 06, 2022

DRAWN BY:

GLC/AM

PROJECT NUMBER:

GLC/AM
PROJECT NUMBER:
2022.08

DRAWING TITLE:
PROJECT REFERENCES

| PROJECT REFERENCES | 219 THOMPSON STREET | 179 & 209 SULLIVAN ST

/ING NUMBEK:

ZONING ANALYSIS (ALL PROVISIONS PROVIDED AS OF RIGHT):

163 BLEECKER STREET, NEW YORK, NY 10012 BOROUGH: MANHATTAN BLOCK: 539 LOT: ZONING DISTRICT: C1-5 IN R7-2 ZONING MAP: 12C LOT SIZE: 25.0' X 100.00' LOT AREA: 2,500.0 SF LOT WIDTH: WIDTH OF STREET: 60' (NARROW STREET < 75') TAX LOT 39 CONSISTS OF A SINGLE ZONING LOT. RESTRICTIVE DECLARATION WILL BE FILED AT THE MANHATTAN COUNTY CLERK OFFICE UNDER DOCUMENTS: CERTIFICATE, EXHIBIT "I": CRFN#2022000000000, ZONING LOT DESCRIPTION, EXHIBIT "III" CRFN#2022000000000

OCCUPANCY GROUP:

PROPOSED 1ST FLOOR - (UG 6A) SERVICE ESTABLISHMENT 2ND FLOOR - (UG 6B) OFFICE

SECTION ZR. 33-121 MAXIMUM FLOOR AREA RATIO IN DISTRICTS WITH BULK GOVERNED BY RESIDENCE BULK REGULATIONS

FOR ZONING LOTS CONTAINING ONLY COMMERCIAL USE, THE FLOOR AREA RATIO IN R7-2 IS 2.0

C1-5 IN R7-2 FAR 2.00

LOT AREA 2,500 SF x 2.0 = 5,000 SF MAXIMUM FLOOR AREA FOR COMMERCIAL USE

<u>PROPOSED</u> 1ST FLOOR: 2,500.00 SF 2ND FLOOR: 2,000.00 SF TOTAL AREA: 4,500.00 SF

4,500.00 < 5,000 SF - OK (PROPOSED COMMERCIAL FAR 1.80)

SECTION ZR. 33-25 MINIMUM REQUIRED SIDE YARDS

NO SIDE YARDS ARE REQUIRED

SECTION ZR. 33-26 MINIMUM REQUIRED REAR YARDS

20' REAR YARD IS REQUIRED NO REAR YARD PROVIDED AT EXISTING 1ST FLOOR (COMMERCIAL USES) 20' REAR YARD PROVIDED AT 2ND FLOOR

SECTION ZR. 33-431 HEIGHT AND SETBACK REGULATIONS - MAXIMUM HEIGHT OF FRONT WALL AND REQUIRED SETBACKS

MAXIMUM STREET WALL HEIGHT OF 60' OR 4 STORIES WHICHEVER IS LESS PROPOSED HEIGHT OF 33'-9", 2 STORIES

SECTION ZR. 36-21 REQUIRED ACCESSORY OFF-STREET PARKING SPACES FOR COMMERCIAL OR COMMUNITY FACILITY USES

FOR GENERAL MEETING HALLS, AUDITORIUMS, EATING OR DRINKING PLACES IN C1-5

NONE REQUIRED

SECTION ZR. 36-70 BICYCLE PARKING REQUIREMENT

THE PROVISION OF THIS SECTION, INCLUSIVE, RELATING TO BICYCLE PARKING SHALL APPLY TO: (b) ENLARGEMENTS THAT INCREASE THE FLOOR AREA WITHIN A BUILDING BY 50 PERCENT OR MORE. PROPOSED ALTERATION DECREASE THE AREA OF AN EXISTING 2 STORY BUILDING, THEREFORE BICYCLE PARKING REQUIREMENT DOES NOT APPLY.

SECTION ZR. 26-41 STREET TREE PLANTING

ONE STREET SHALL BE PROVIDED FOR EVERY 25' OF STREET FRONTAGE. FRONTAGE 25'= (1) STREET TREES REQUIRED THERE IS AN EXISTING (1) STREET TREE FRONTING THE PROPERTY

CALCULATION OF INCREASE IN FLOOR AREA


EXISTING SURFACE AREA TO REMAIN CELLAR= 2,500 SF 1ST FL= 2,500 SF TOTAL SURFACE AREA TO REMAIN=5,000.00 SF PROPOSED ADDITIONAL SURFACE AREA MEZZANINE FLOOR=825 SF 2ND FLOOR=2,000 SF

2ND FLOOR TERRACE = 500 SF ROOF = 2,000 SF TOTAL PROPOSED SURFACE AREA=5,325 SF


(PROPOSED - EXISTING TO REMAIN/ EXISTING TO REMAIN)X100 = PERCENTAGE INCREASE IN FLOOR SURFACE AREA

5,325-5000 = 325 SF 325 / 5000 = 0.065 0.065 X 100 = 6.5 %

6.5 % PERCENTAGE INCREASE IN FLOOR SURFACE AREA

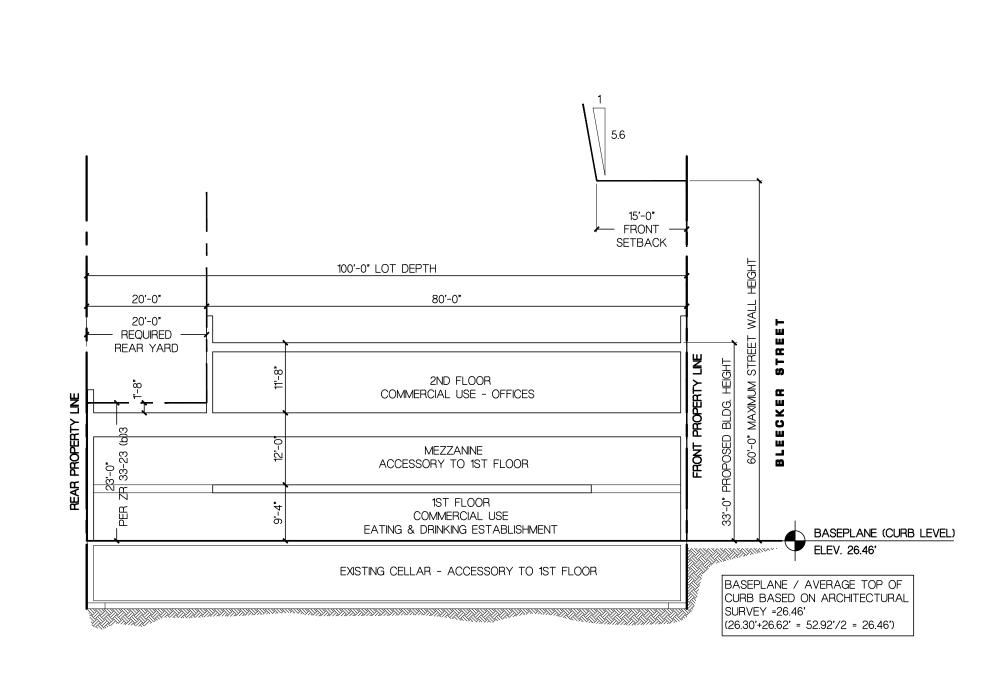




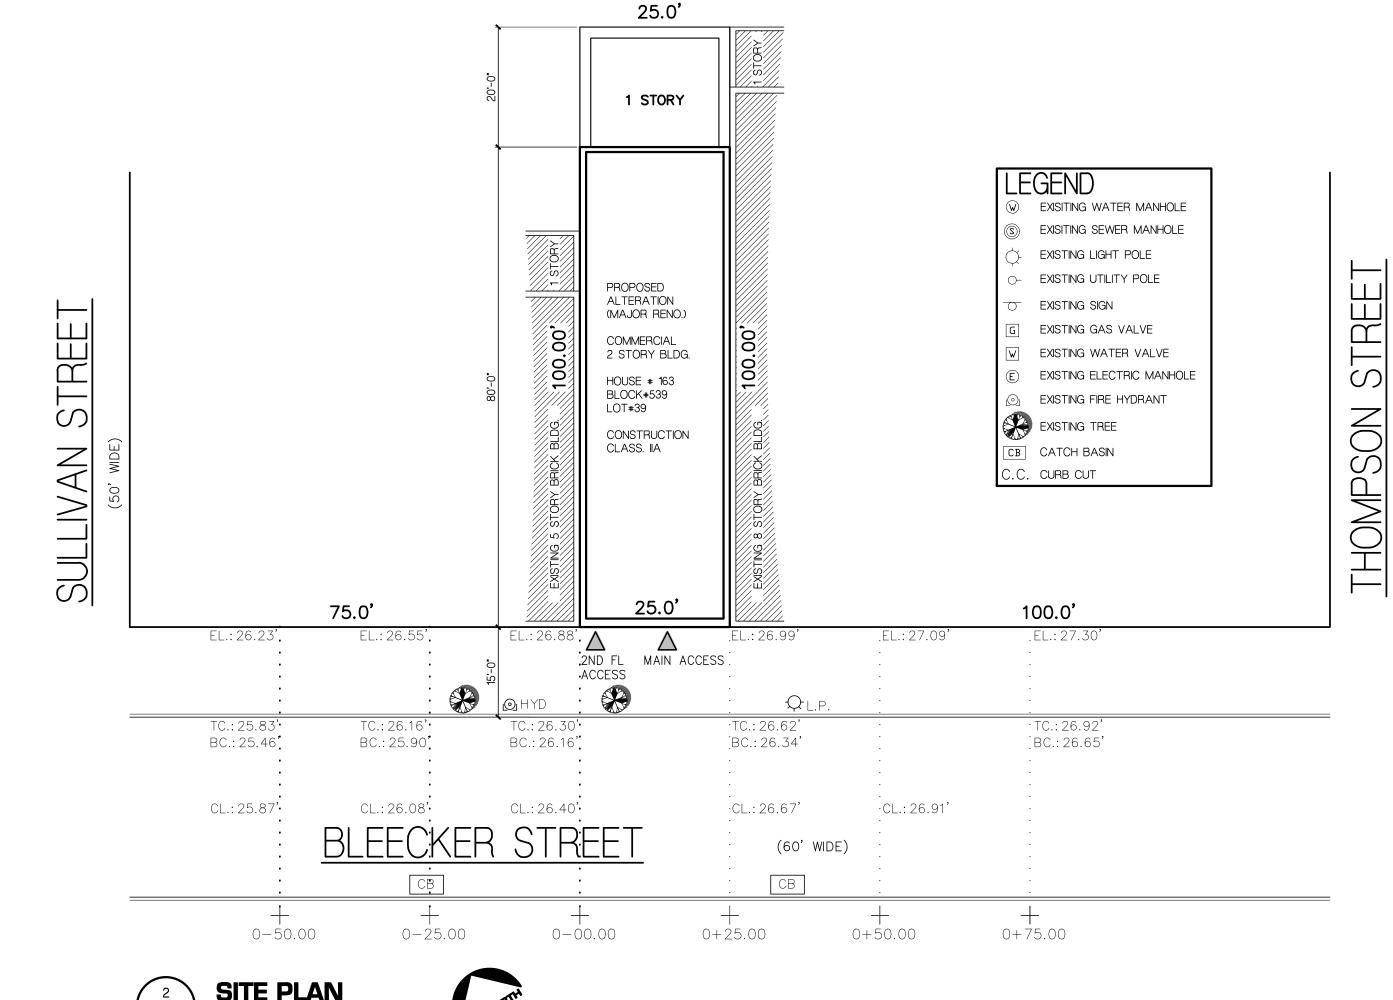

SCALE: 1/16" = 1'-0"

ZONING MAP:



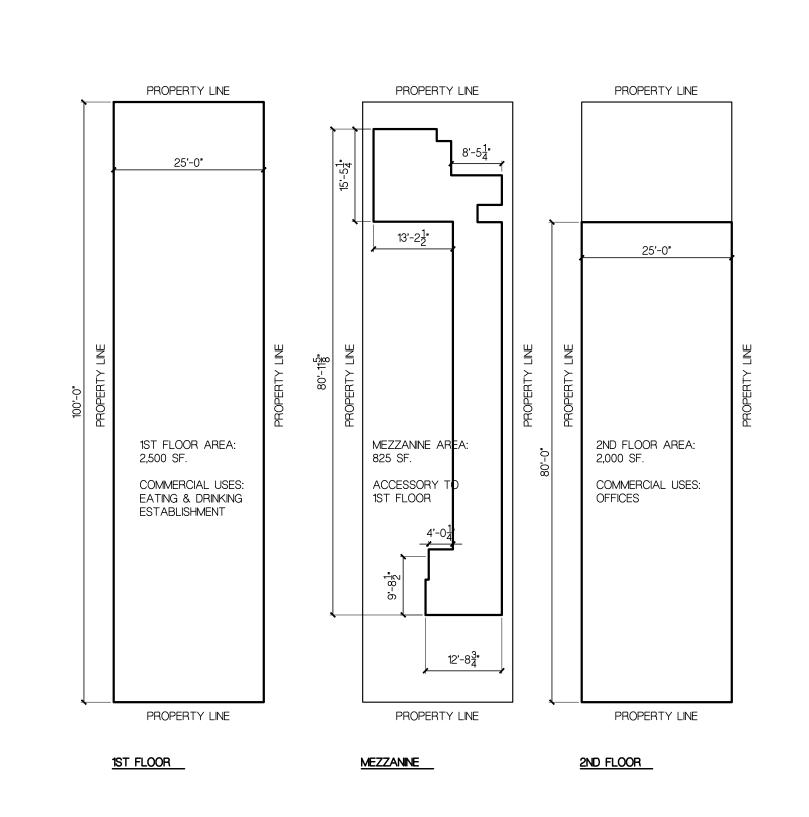

AREA DIAGRAM Z-100 SCALE: 1/16" = 1'-0"

.

WWW.MOJOSTUMER.COM 14 Plaza Road Greenvale, NY 11548 (f) 516.625.3418

> This drawing is the property of Mojo Stumer Associates, P.C. & is not to be altered, reused or reproduced without written permission.

CONSULTANTS:

LANDMARKS PRESERVATION COMMISSION SET

D A T E : DEC 06, 2022

DOB NOW JOB #:

1 STORY EXISTING 5 STORY BRICK BLDG.

COMMERCIAL BUILDING ALTERATION 163 BLEECKER STREET


NEW YORK, NY 10021

BLEECKER STREET

PROJECT NUMBER:

ZONING SHEET

DRAWING NUMBER:

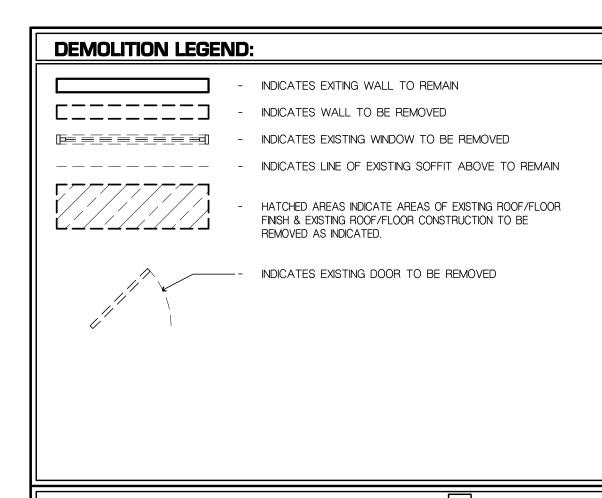

REFERENCE KEYED NOTES - DEMOLITION: *

SERVICES DURING CONSTRUCITON.

- 1. REMOVE <u>NON-STRUCTURAL</u> PARTITION WALLS AS INDICATED AND ALL ASSOCIATED COMPONENTS, INCLUDING BUT NOT LIMITED TO: METAL STUDS, WOOD STUDS, GYPSUM BOARD OR PLASTER, AND ALL ATTACHMENTS, FROM SLAB TO SLAB.
- 2. REMOVE INTERIOR DOOR OR WINDOW ASSEMBLY IN ITS ENTIRETY.
 A. COORDINATE WITH BUILDING MANAGEMENT REGARDING DOORS OR OTHER COMPONENTS TO BE SAVED OR STORED.
- 3. REMOVE NON-STRUCTURAL CEILING SYSTEM AND ALL ASSOCIATED COMPONENTS UP TO STRUCTURAL DECK, INCLUDING BUT NOT LIMITED TO: ACOUSTIC CEILING SYSTEMS (TILES, GRID, SUSPENSION COMPONENTS,) SHEETROCK OR PLASTER CEILINGS, LIGHTING FIXTURES, DIFFUSERS, ETC. UNLESS OTHERWISE NOTED. COORDINATE WITH MECHANICAL DRAWINGS.


 A. ANY WIRING OR LIFE SAFETY ELEMENTS SUPPORTED BY CEILING OR CEILING SUPPORTS MUST BE LEFT OR RE-SUPPORTED TO CAUSE NO INTERRUPTION OF
- 4. REMOVE FINISH FLOORING DOWN TO EXISTING CONCRETE SLAB, INCLUDING BUT NOT LIMITED TO: CARPET/CARPET PAD INCLUDING ADHESIVES AND SUB-BASE, VCT INCLUDING ADHESIVE OR SUB-BASE, CERAMIC TILE, STONE, INCLUDING MUDSET AND ADHESIVES, WOOD FLOOR, SUB-FLOOR, ADHESIVES AND ALL ATTACHMENTS, AND ANY AND ALL OTHER SPECIALTY FLOORS AND SUB-FLOOR. PATCH AND LEVEL EXISTING SLAB AS REQUIRED FOR A FLUSH SURFACE ADEQUATE FOR INSTALLATION OF NEW FINISH FLOORING MATERIALS. CONTRACTOR TO VERIFY ALL FINISH FLOOR CONDITIONS PRIOR TO BID
- 5. REMOVE MILLWORK AND CABINETRY IN ITS ENTIRETY, INCLUDING ANY ASSOCIATED FIXTURES OR APPLIANCES.
- 6. REMOVE PLUMBING FIXTURES AND ALL ASSOCIATED COMPONENTS IN THEIR ENTIRETY. CUT, CAP AND FLUSH ALL ABANDONED STUBS, AND PROVIDE REQUIRED PATCHING. SEE PLUMBING DRAWINGS.
- 7. SEE MECHANICAL DRAWINGS FOR DEMOLITION OF EXISTING HVAC SYSTEMS AND DUCTWORK.


DEMOLITION NOTES:

- CONTRACTOR NOTE: BIDDERS, BEFORE SUBMITTING PROPOSALS, SHALL VISIT AND CAREFULLY EXAMINE THE AREA AFFECTED BY THIS WORK TO FAMILIARIZE THEMSELVES WITH THE EXISTING CONDITIONS AND THE DIFFICULTIES THAT WILL ATTEND THE EXECUTION OF THIS WORK. SUBMISSIONS OF A PROPOSAL WILL BE CONSTRUED AS EVIDENCE THAT SUCH EXAMINATION HAS BEEN MADE IN AN ATTEMPT TO OBSERVE DIFFICULTIES THAT WOULD BE ENCOUNTERED ONLY IF SUCH AN EXAMINATION HAD BEEN MADE.
- THE ARCHITECT AND/OR HIS CONSULTANTS ASSUME NO RESPONSIBILITY FOR THE MEANS BY WHICH THE DEMOLITION IS PERFORMED. THE CONTRACTOR AND HIS SUBCONTRACTORS SHALL REMOVE AND/OR PERFORM THE ITEMS NOTED AS SUCH ON THIS SHEET IN A PROFESSIONAL MANNER IN ACCORDANCE WITH 'GOOD GENERAL PRACTICES'. SHOULD ANY STRUCTURAL DAMAGE OCCUR WHILE INSTITUTING DEMOLITION PROCEDURES, THE CONTRACTOR IS TO TEMPORARILY STABILIZE THE STRUCTURE TO A 'SAFE' CONDITION AND TO NOTIFY THE ARCHITECT AND/OR ENGINEER IMMEDIATELY FOR RECTIFICATION. PROVIDE ALL TEMPORARY SHORING REQUIRED TO INSURE THE STABILITY OF THE BUILDING THROUGHOUT CONSTRUCTION.
- 3. REFER TO MECHANICAL, PLUMBING, ELECTRICAL AND STRUCTURAL DRAWINGS INCLUDED IN THIS DRAWING PACKAGE FOR ADDITIONAL SELECTIVE DEMOLITION WITH REGARDS TO THE RESPECTIVE TRADES. DEMOLITION CONTRACTOR TO FAMILIARIZE HIM/HER SELF WITH THE ENTIRE CONSTRUCTION DRAWING PACKAGE, AND MAKE PROVISIONS FOR THE NEW WORK TO BE COMPLETED AS DESCRIBED IN THE DRAWINGS AND SPECIFICATIONS. THE CONTRACTOR SHALL NOTIFY THE ARCHITECT/ENGINEER IMMEDIATELY SHOULD THERE BE ANY PROBLEMS OR
- 4. CONTRACTOR SHALL MEET WITH OWNER TO COORDINATE ALL WORK, SCHEDULING, ETC. AND TO SEE IF ANY EXISTING ITEMS SHALL BE SAVED AND IF NECESSARY REMOVED CAREFULLY AND

DISCREPANCIES FROM WHAT EXISTS IN THE FIELD TO WHAT IS INDICATED ON THE DRAWINGS.

- 5. MAINTAIN ALL EXISTING REQUIRED BUILDING SHAFTS AND FIRE RATED WALLS WITH SAME FIRE RATING AS BEFORE.
- 6. CONTRACTOR SHALL TAKE ALL PRECAUTIONS DURING DEMOLITION WORK SO AS NOT TO CAUSE ANY DAMAGE TO EXISTING WORK TO REMAIN.
 7. BEFORE ANY REMOVAL WORK IS STARTED, ELECTRICAL CONTRACTOR SHALL VERIFY THAT SERVICE HAS BEEN CUT TO THAT AREA EXCEPT AS NOTED BELOW.
- 3. THE CONTRACTOR IS REQUIRED TO PROVIDE ALL SHORING AND BRACING REQUIRED DURING THE REMOVAL OF EXISTING STRUCTURAL MEMBERS AND INSTALLATION OF NEW STRUCTURAL FRAMING.
- ALL DEMOLISHED MATERIALS AND DEBRIS SHALL BE LEGALLY DISPOSED OF AND REMOVED FROM THE SITE BY THE CONTRACTOR. CONTRACTOR SHALL REMOVE ALL DEBRIS FROM BUILDING AND SITE AT THE END OF EACH DAY. ACCUMULATION OF RUBBISH SHALL NOT BE PERMITTED.
- 10. AT NO TIME SHOULD THE CONTRACTOR ALLOW THE DEMOLITION WORK OR STORAGE OF DEBRIS TO CAUSE INTERFERENCE WITH ANY REQUIRED MEANS OF EGRESS OR CAUSE A HAZARDOUS CONDITION
- 11. MAINTAIN AT ALL TIMES THE EMERGENCY LIGHTING THROUGHOUT THE BUILDING DURING DEMOLITION WORK, AS WELL AS RECONSTRUCTION WORK. PROVIDE ALL NECESSARY TEMPORARY LIGHTING, PARTITIONS AND DUST COVERS.
- 12. CUT, CAP AND FLUSH ALL ABANDONED STUBS, AND PROVIDE REQUIRED PATCHING. PROVIDE ABANDONED OUTLETS WITH BLANK COVER.
- 13. PROVIDE BOX AND SPLICE WIRES WHERE IT IS REQUIRED TO MAINTAIN CONTINUITY OF CIRCUITS OR REMOVE WIRING AND SPLICE WIRE AT NEAREST ACTIVE BOX FROM OUTLETS WHICH HAVE
- 14. INCLUDE IN BID ALL DEMOLITION WORK AS REQUIRED TO COMPLETE ALL NEW WORK AS DELINEATED BY ARCHITECTURAL AND ENGINEERING DRAWINGS WHETHER SHOWN ON DRAWINGS
- 15. PROVIDE ALL REQUIRED PATCHING OF WALLS, CEILINGS AND FLOORS AS REQUIRED TO ACHIEVE NEW FINISHES SHOWN ON CONSTRUCTION DRAWINGS.

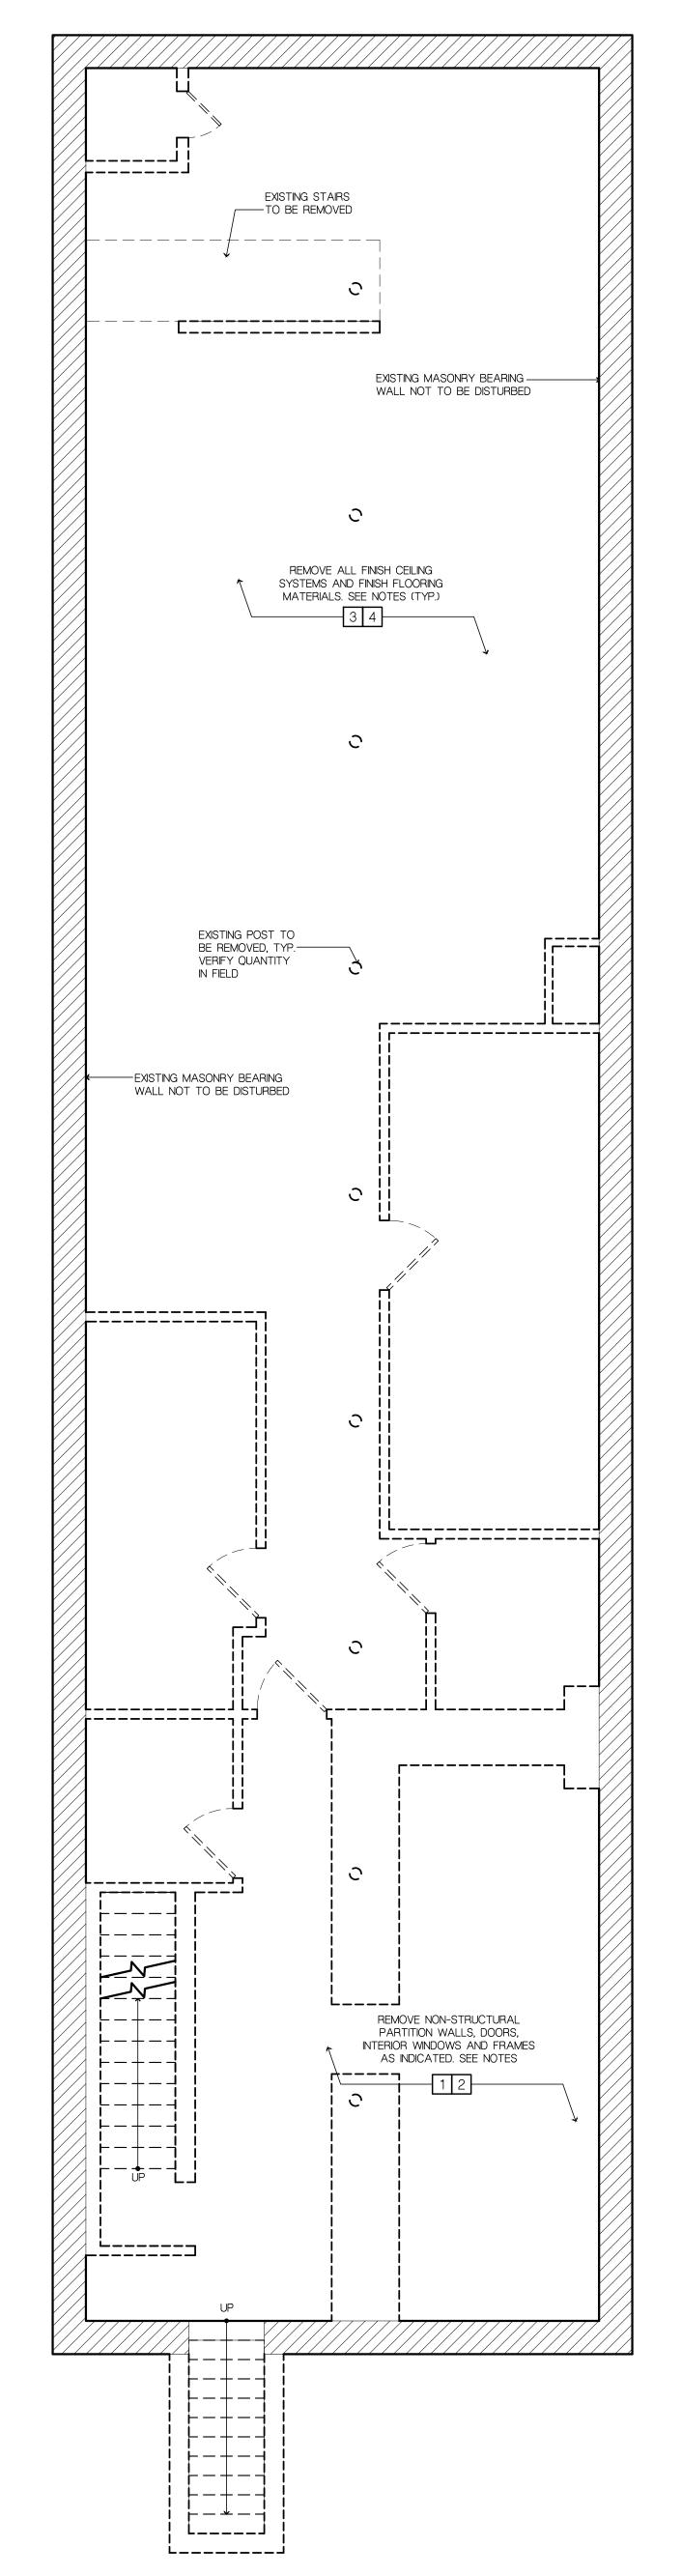

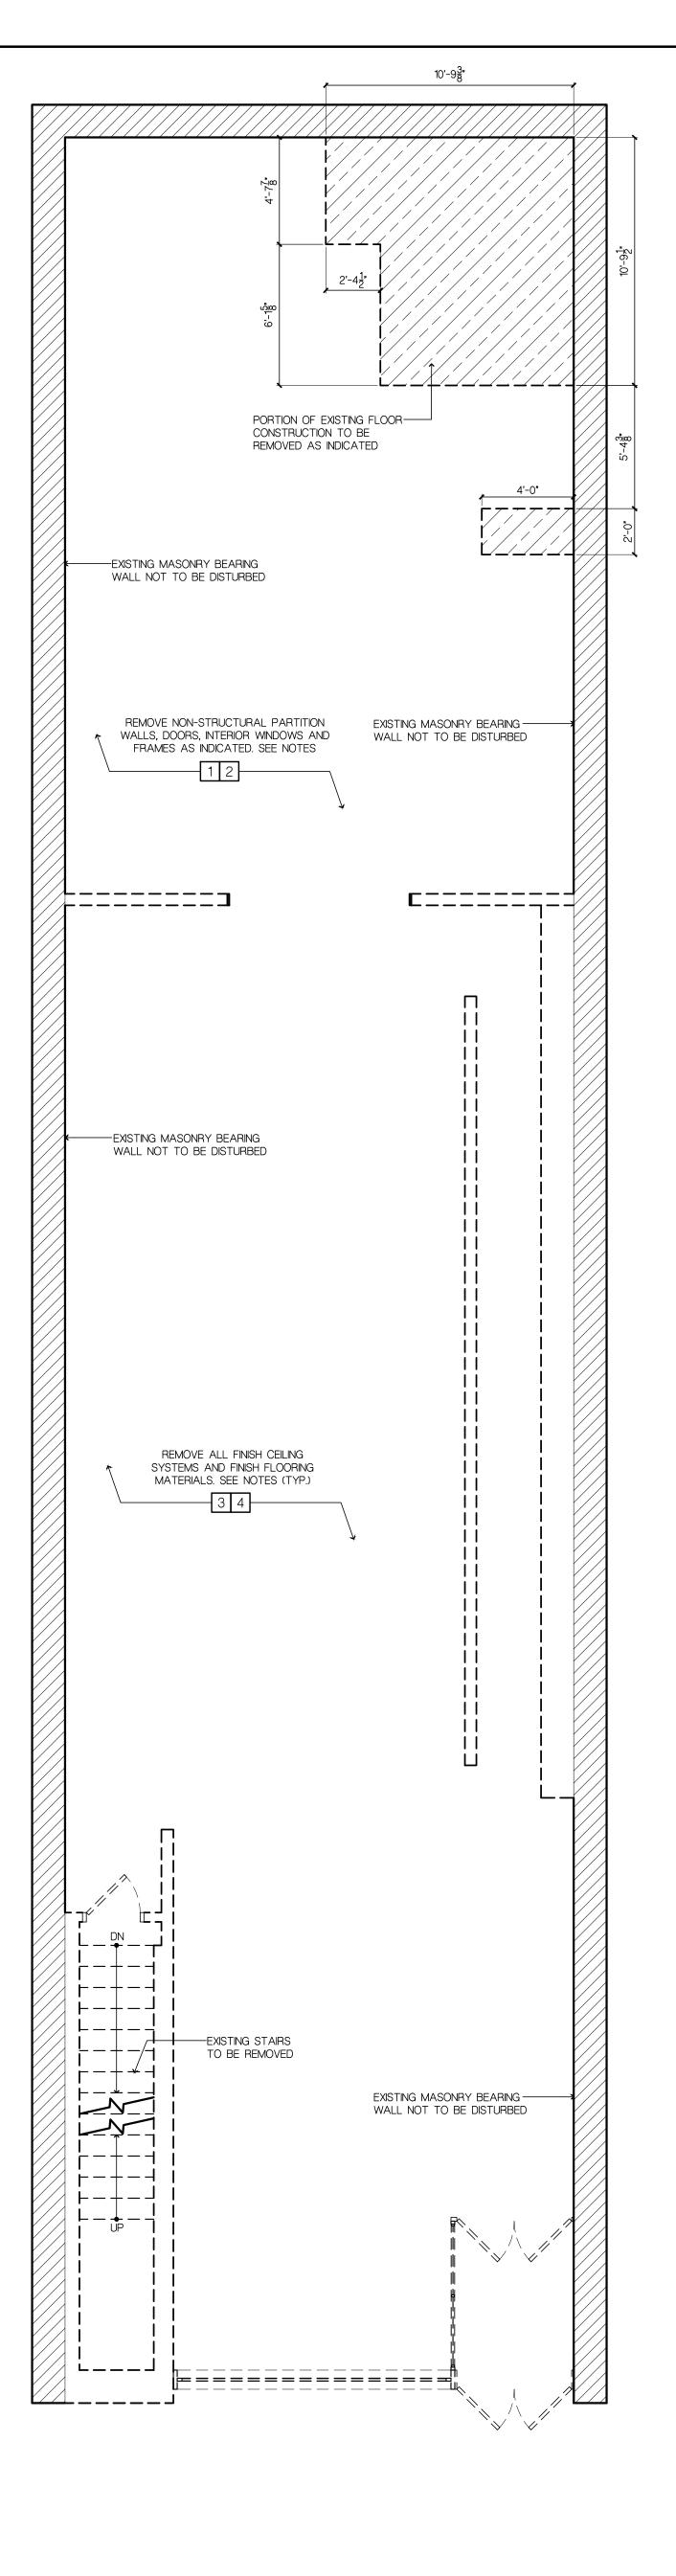



MOJO SI UMER ASSOCIATES, P.C

14 Plaza Road (t) 516.625.3344 Greenvale, NY 11548 (f) 516.625.3418

.


This drawing is the property of Mojo Stumer Associates, P.C. & is not to be altered, reused or reproduced without written permission.

CONSULTANTS:

LANDMARKS PRESERVATION COMMISSION SET

DATE: DEC 06, 2022

DOB NOW JOB #:

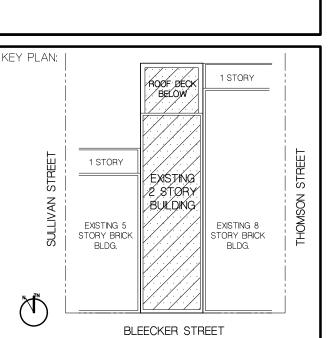

COMMERCIAL
BUILDING ALTERATION

163 BLEECKER STREET

163 BLEECKER STREET NEW YORK, NY 10021

AS SHOWN

DATE:

DEC 06, 2022

DRAWN BY:

GLC/AM

PROJECT NUMBER:

2022.08

CELLAR & FIRST FLOOR
DEMOLITION PLAN


DRAWING NUMBER:

17




m .


CELLAR DEMOLITION PLAN

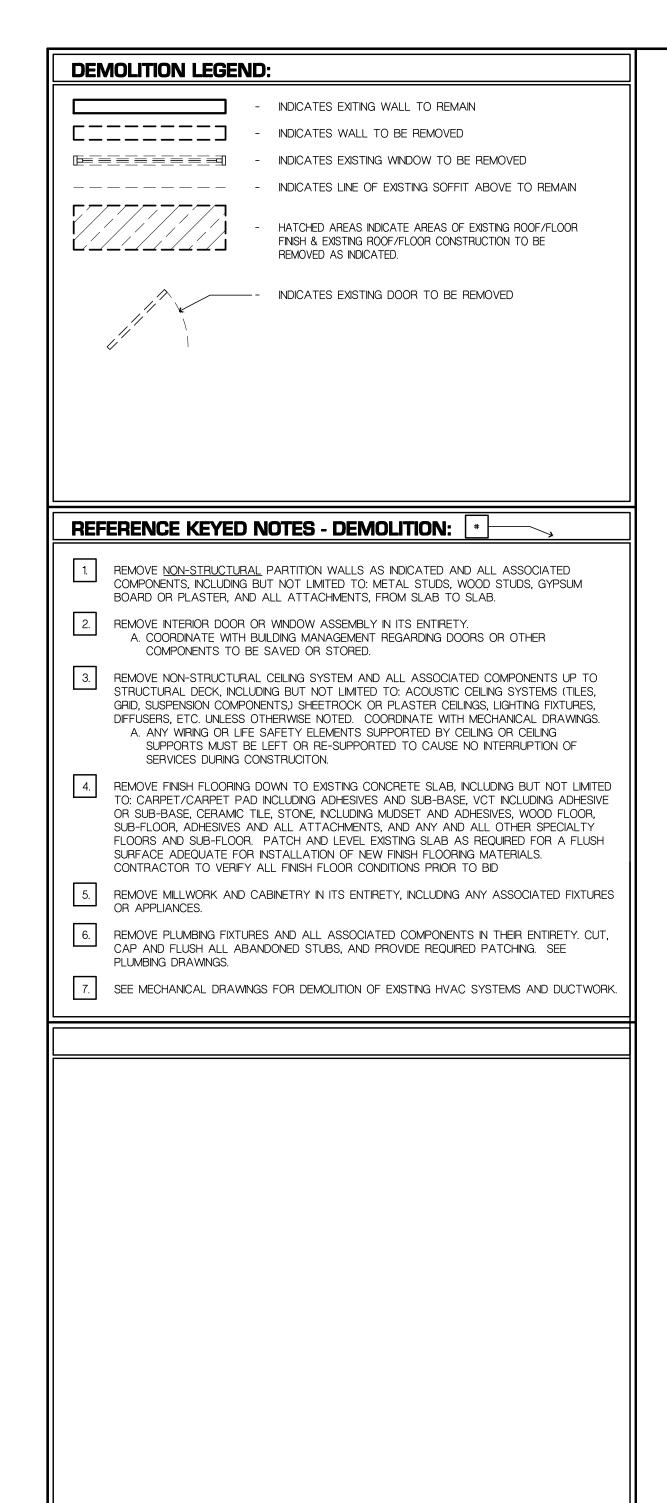


DEMOLITION NOTES:

- CONTRACTOR NOTE: BIDDERS, BEFORE SUBMITTING PROPOSALS, SHALL VISIT AND CAREFULLY EXAMINE THE AREA AFFECTED BY THIS WORK TO FAMILIARIZE THEMSELVES WITH THE EXISTING CONDITIONS AND THE DIFFICULTIES THAT WILL ATTEND THE EXECUTION OF THIS WORK. SUBMISSIONS OF A PROPOSAL WILL BE CONSTRUED AS EVIDENCE THAT SUCH EXAMINATION HAS BEEN MADE IN AN ATTEMPT TO OBSERVE DIFFICULTIES THAT WOULD BE ENCOUNTERED ONLY IF SUCH AN EXAMINATION HAD BEEN MADE.
- THE ARCHITECT AND/OR HIS CONSULTANTS ASSUME NO RESPONSIBILITY FOR THE MEANS BY WHICH THE DEMOLITION IS PERFORMED. THE CONTRACTOR AND HIS SUBCONTRACTORS SHALL REMOVE AND/OR PERFORM THE ITEMS NOTED AS SUCH ON THIS SHEET IN A PROFESSIONAL MANNER IN ACCORDANCE WITH 'GOOD GENERAL PRACTICES'. SHOULD ANY STRUCTURAL DAMAGE OCCUR WHILE INSTITUTING DEMOLITION PROCEDURES, THE CONTRACTOR IS TO TEMPORARILY STABILIZE THE STRUCTURE TO A 'SAFE' CONDITION AND TO NOTIFY THE ARCHITECT AND/OR ENGINEER IMMEDIATELY FOR RECTIFICATION. PROVIDE ALL TEMPORARY SHORING REQUIRED TO INSURE THE STABILITY OF THE BUILDING THROUGHOUT CONSTRUCTION.
- REFER TO MECHANICAL, PLUMBING, ELECTRICAL AND STRUCTURAL DRAWINGS INCLUDED IN THIS DRAWING PACKAGE FOR ADDITIONAL SELECTIVE DEMOLITION WITH REGARDS TO THE RESPECTIVE TRADES. DEMOLITION CONTRACTOR TO FAMILIARIZE HIM/HER SELF WITH THE ENTIRE CONSTRUCTION DRAWING PACKAGE, AND MAKE PROVISIONS FOR THE NEW WORK TO BE COMPLETED AS DESCRIBED IN THE DRAWINGS AND SPECIFICATIONS. THE CONTRACTOR SHALL NOTIFY THE ARCHITECT/ENGINEER IMMEDIATELY SHOULD THERE BE ANY PROBLEMS OR DISCREPANCIES FROM WHAT EXISTS IN THE FIELD TO WHAT IS INDICATED ON THE DRAWINGS.
- CONTRACTOR SHALL MEET WITH OWNER TO COORDINATE ALL WORK, SCHEDULING, ETC. AND TO SEE IF ANY EXISTING ITEMS SHALL BE SAVED AND IF NECESSARY REMOVED CAREFULLY AND
- MAINTAIN ALL EXISTING REQUIRED BUILDING SHAFTS AND FIRE RATED WALLS WITH SAME FIRE RATING AS BEFORE.
- CONTRACTOR SHALL TAKE ALL PRECAUTIONS DURING DEMOLITION WORK SO AS NOT TO CAUSE ANY DAMAGE TO EXISTING WORK TO REMAIN. BEFORE ANY REMOVAL WORK IS STARTED, ELECTRICAL CONTRACTOR SHALL VERIFY THAT SERVICE HAS BEEN CUT TO THAT AREA EXCEPT AS NOTED BELOW.
- THE CONTRACTOR IS REQUIRED TO PROVIDE ALL SHORING AND BRACING REQUIRED DURING THE REMOVAL OF EXISTING STRUCTURAL MEMBERS AND INSTALLATION OF NEW STRUCTURAL
- ALL DEMOLISHED MATERIALS AND DEBRIS SHALL BE LEGALLY DISPOSED OF AND REMOVED FROM THE SITE BY THE CONTRACTOR. CONTRACTOR SHALL REMOVE ALL DEBRIS FROM BUILDING AND SITE AT THE END OF EACH DAY. ACCUMULATION OF RUBBISH SHALL NOT BE PERMITTED.
- . AT NO TIME SHOULD THE CONTRACTOR ALLOW THE DEMOLITION WORK OR STORAGE OF DEBRIS TO CAUSE INTERFERENCE WITH ANY REQUIRED MEANS OF EGRESS OR CAUSE A HAZARDOUS
- MAINTAIN AT ALL TIMES THE EMERGENCY LIGHTING THROUGHOUT THE BUILDING DURING DEMOLITION WORK, AS WELL AS RECONSTRUCTION WORK. PROVIDE ALL NECESSARY TEMPORARY LIGHTING, PARTITIONS AND DUST COVERS.
- CUT, CAP AND FLUSH ALL ABANDONED STUBS, AND PROVIDE REQUIRED PATCHING. PROVIDE ABANDONED OUTLETS WITH BLANK COVER.
- . PROVIDE BOX AND SPLICE WIRES WHERE IT IS REQUIRED TO MAINTAIN CONTINUITY OF CIRCUITS OR REMOVE WIRING AND SPLICE WIRE AT NEAREST ACTIVE BOX FROM OUTLETS WHICH HAVE
- . INCLUDE IN BID ALL DEMOLITION WORK AS REQUIRED TO COMPLETE ALL NEW WORK AS DELINEATED BY ARCHITECTURAL AND ENGINEERING DRAWINGS WHETHER SHOWN ON DRAWINGS
- 5. PROVIDE ALL REQUIRED PATCHING OF WALLS, CEILINGS AND FLOORS AS REQUIRED TO ACHIEVE NEW FINISHES SHOWN ON CONSTRUCTION DRAWINGS.

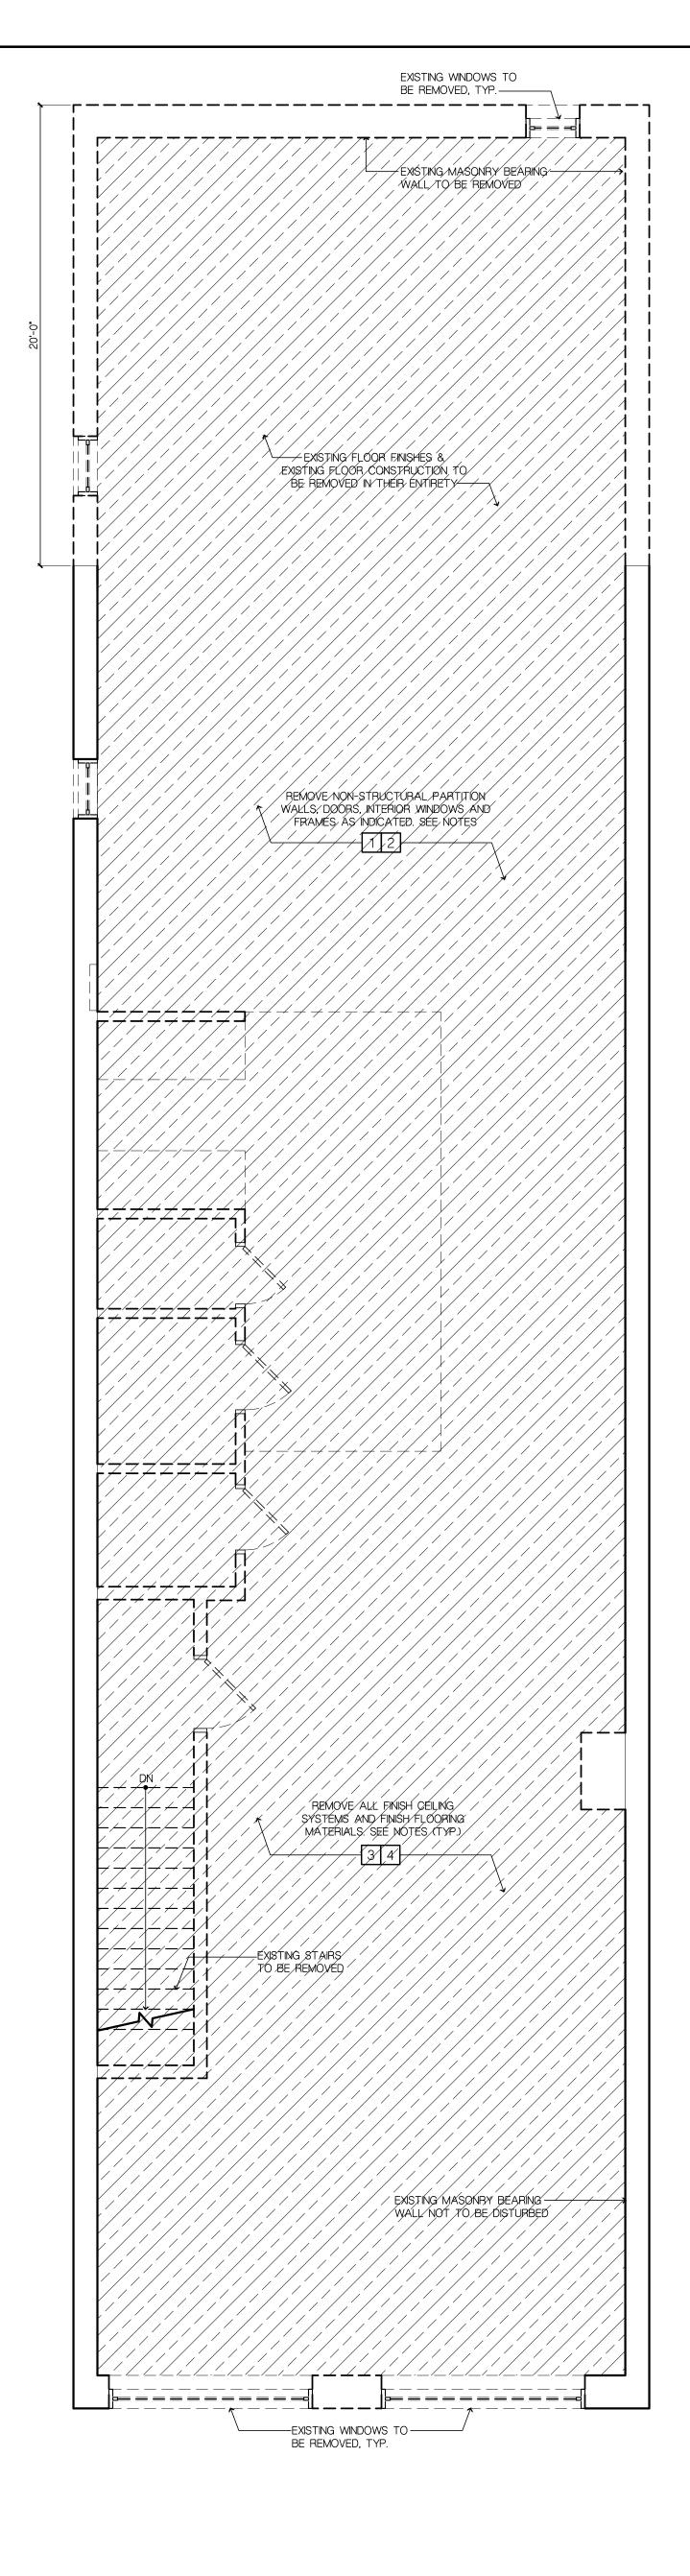

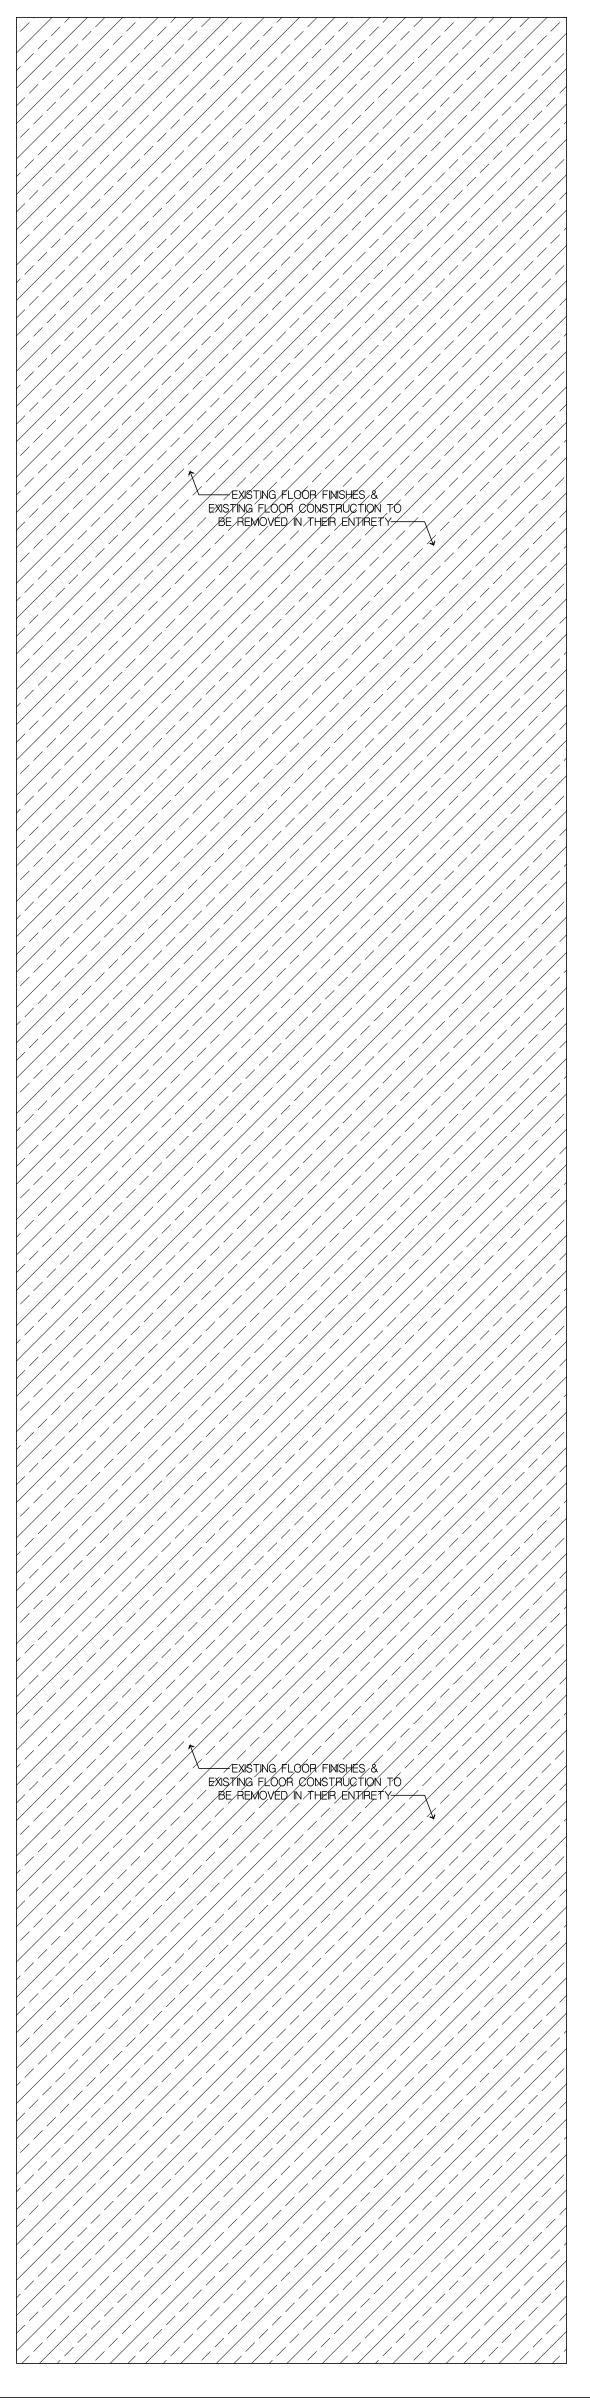

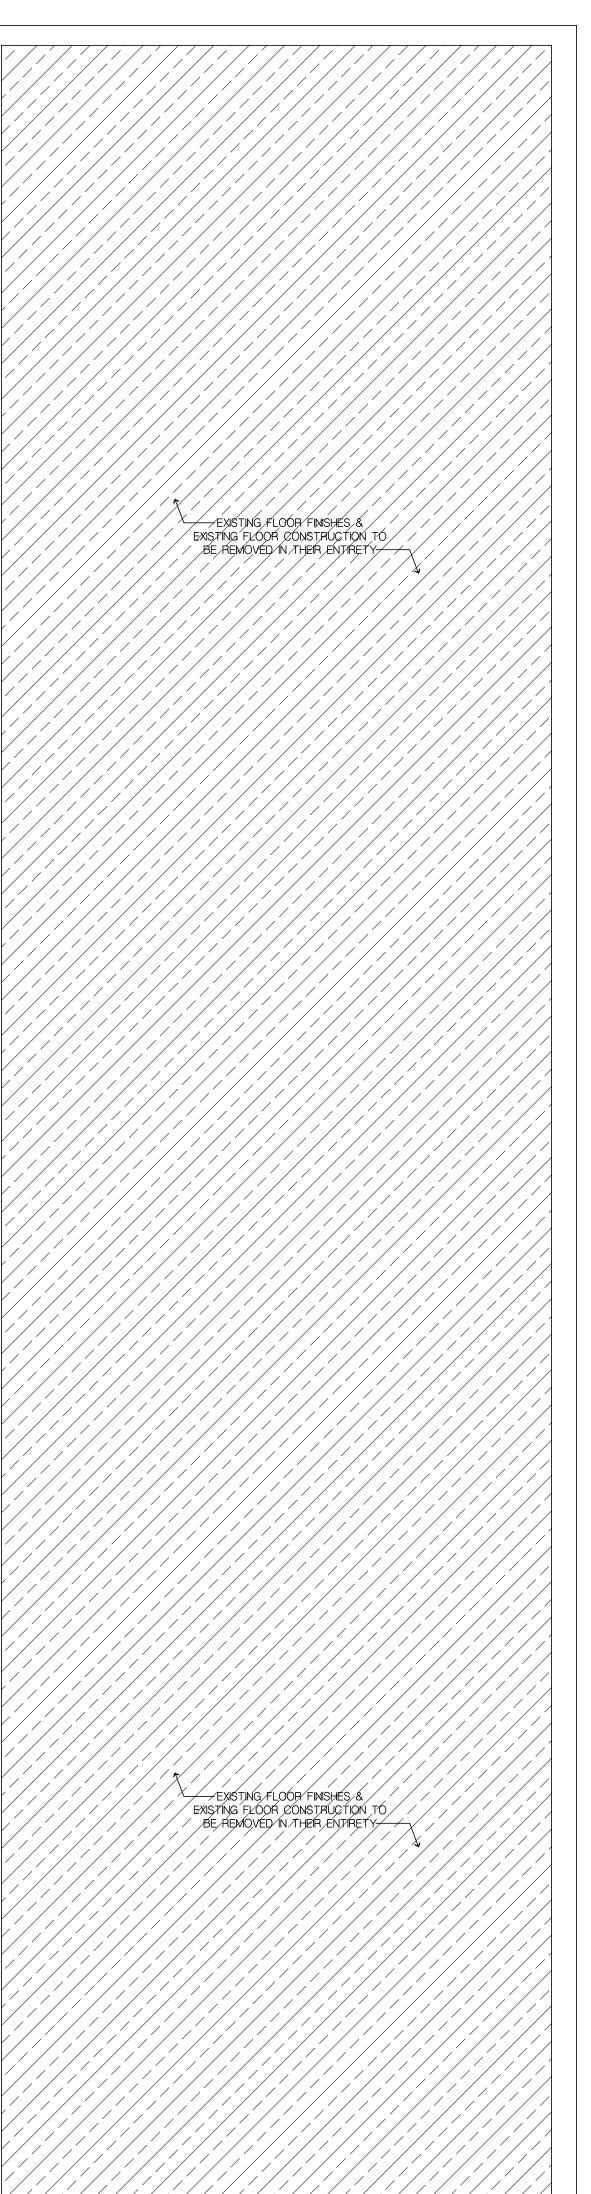

• • • •

WWW.MOJOSTUMER.COM 14 Plaza Road (t) 5**1**6.625.3344 Greenvale, NY 11548 (f) 516.625.3418

.

This drawing is the property of Mojo Stumer Associates, P.C. & is not to be altered, reused or reproduced without written permission.

CONSULTANTS:

LANDMARKS PRESERVATION COMMISSION SET

DATE: DEC 06, 2022

DOB NOW JOB #:

1 STORY BUKDING EXISTING 5 STORY BRICK BLDG.

COMMERCIAL BUILDING ALTERATION

BLEECKER STREET

163 BLEECKER STREET NEW YORK, NY 10021


PROJECT NUMBER: 2022.08

SECOND FLOOR & ROOF DEMOLITION PLAN







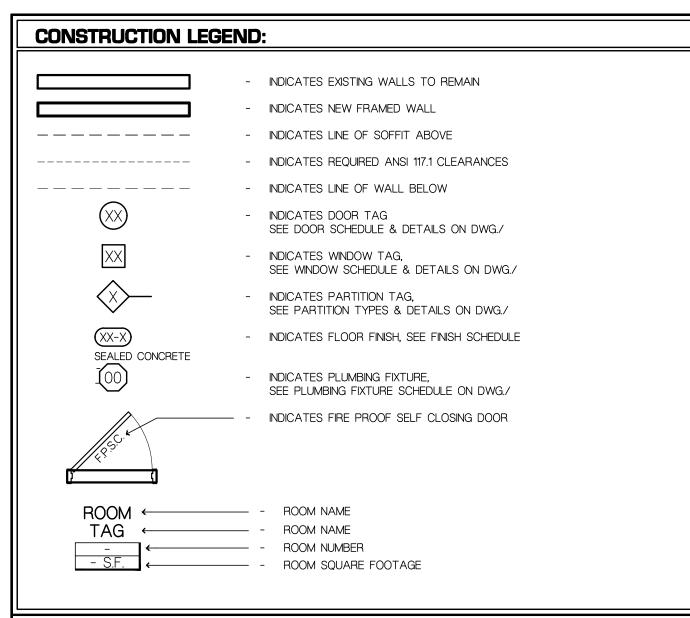

FIRE PREVENTION LEGEND:

- INDICATES COMBINATION SMOKE & CARBON MONOXIDE DETECTOR

_ - INDICATES CEILING MOUNTED EXIT SIGN


CONSTRUCTION NOTES:

FEDERAL EPA RULE ISSUED APRIL 22, 2008.

- ALL DIMENSIONS TAKEN TO ROUGH FRAMING OR FACE OF MASONRY UNLESS SPECIFICALLY NOTED OTHERWISE. DIMENSIONS FROM EXISTING WALLS ARE TAKEN TO EXISTING FINISH.
- COORDINATE FINSH DIMENSIONS WITH ENLARGED CABINETRY PLANS AND REFLECTED CEILING PLAN DESIGNS.
- ALL BATHROOMS TO HAVE 5/8" MOLD RESISTANT GYPSUM WALL BOARD ON NEW WALLS & CEILINGS. ALL KITCHEN WALLS WITHIN 2 FEET OF SINK AND STOVE UP TO 4 FEET HIGH MUST USE % MOLD RESISTANT GYPSUM WALL BOARD.
- 4. ALL WALLS AND CEILINGS OF SPACES CONTAINING CONDENSERS, WATER TANKS, WATER PUMPS AND/OR PRESSURE REDUCTION VALVES MUST HAVE 🖁 MOLD RESISTANT GYPSUM WALL BOARD.
- 5. ALL PLYWOOD USED TO BE FIRE-RESISTANT. 6. WHERE CHASES, SHAFTS, DEMSING WALLS AND STRUCTURAL ELEMENTS ARE OPENED DURING CONSTRUCTION, PROVIDE FIRESTOPPING AS
- REQUIRED BY CODE AT ALL EXISTING OR NEW OPENINGS. A UL RATED FIRESTOPPING SYSTEM IS TO BE PROVIDED AS MANUFACTURED BY STI, HLTI OR EQUAL (UL RATING ON SUBSTITUTIONS IS REQUIRED). FIRESTOPPING MUST BE COMPLETED ONCE DEMOLITION HAS BEEN

SMALL OPENINGS AND PIPE PENETRATIONS IN THE WALLS, FLOOR AND CEILING SLABS CAN BE FIRESTOPPED WITH HITLI PRODUCTS OR

- 8. THE PROJECT MUST BE FILED WITH THE NEW YORK CITY BUILDINGS DEPARTMENT. A PERMIT MUST BE OBTAINED AND COPY MUST BE PROVIDED TO THE OWNER PRIOR TO WORK AT THE COMPLETION OF WORK, A LETTER FROM THE NEW YORK CITY BUILDINGS DEPARTMENT INDICATING THAT THE WORK HAS BEEN SATISFACTORILY COMPLETED MUST BE PROVIDED TO THE OWNER. 9. A CERTIFICATE FROM A LICENSED ASBESTOS INVESTIGATOR INDICATING WHETHER THE PROJECT DOES OR DOES NOT INVOLVE THE
- REMOVAL OF ASBESTOS MUST BE PROVIDED TO THE OWNER PRIOR TO WORK. D. ALL PLUMBING MUST BE PERFORMED BY A LICENSED PLUMBER AND FILED WITH THE NEW YORK CITY BULDINGS DEPARTMENT. THE WORK
- MUST BE APPROVED BY THE NEW YORK CITY BUILDINGS DEPARTMENT AT THE COMPLETION OF WORK I. ALL ELECTRICAL WORK SHALL BE COMPLETED BY AN ELECTRICIAN LICENSED BY THE CITY IF NEW YORK, THE ELECTRICAL WORK MUST BE FILED BY THE CONTRACTOR WITH THE BUREAU OF ELECTRICAL CONTROL AND A CERTIFICATE OF ELECTRICAL INSPECTION MUST BE
- PROVIDED TO THE OWNER AT THE COMPLETION OF WORK 12. THE CONTRACTOR SHALL COMPLY WITH THE USE OF LEAD-SAFE PRACTICES FOR WORK IMPACTING 6 SQ, FT. OR MORE OF LEAD PAINT IN BUILDINGS ERECTED BEFORE 1978, AND ALL APPLICABLE STATE AND LOCAL REGULATIONS. PROPOSED WORK MUST COMPLY WITH THE

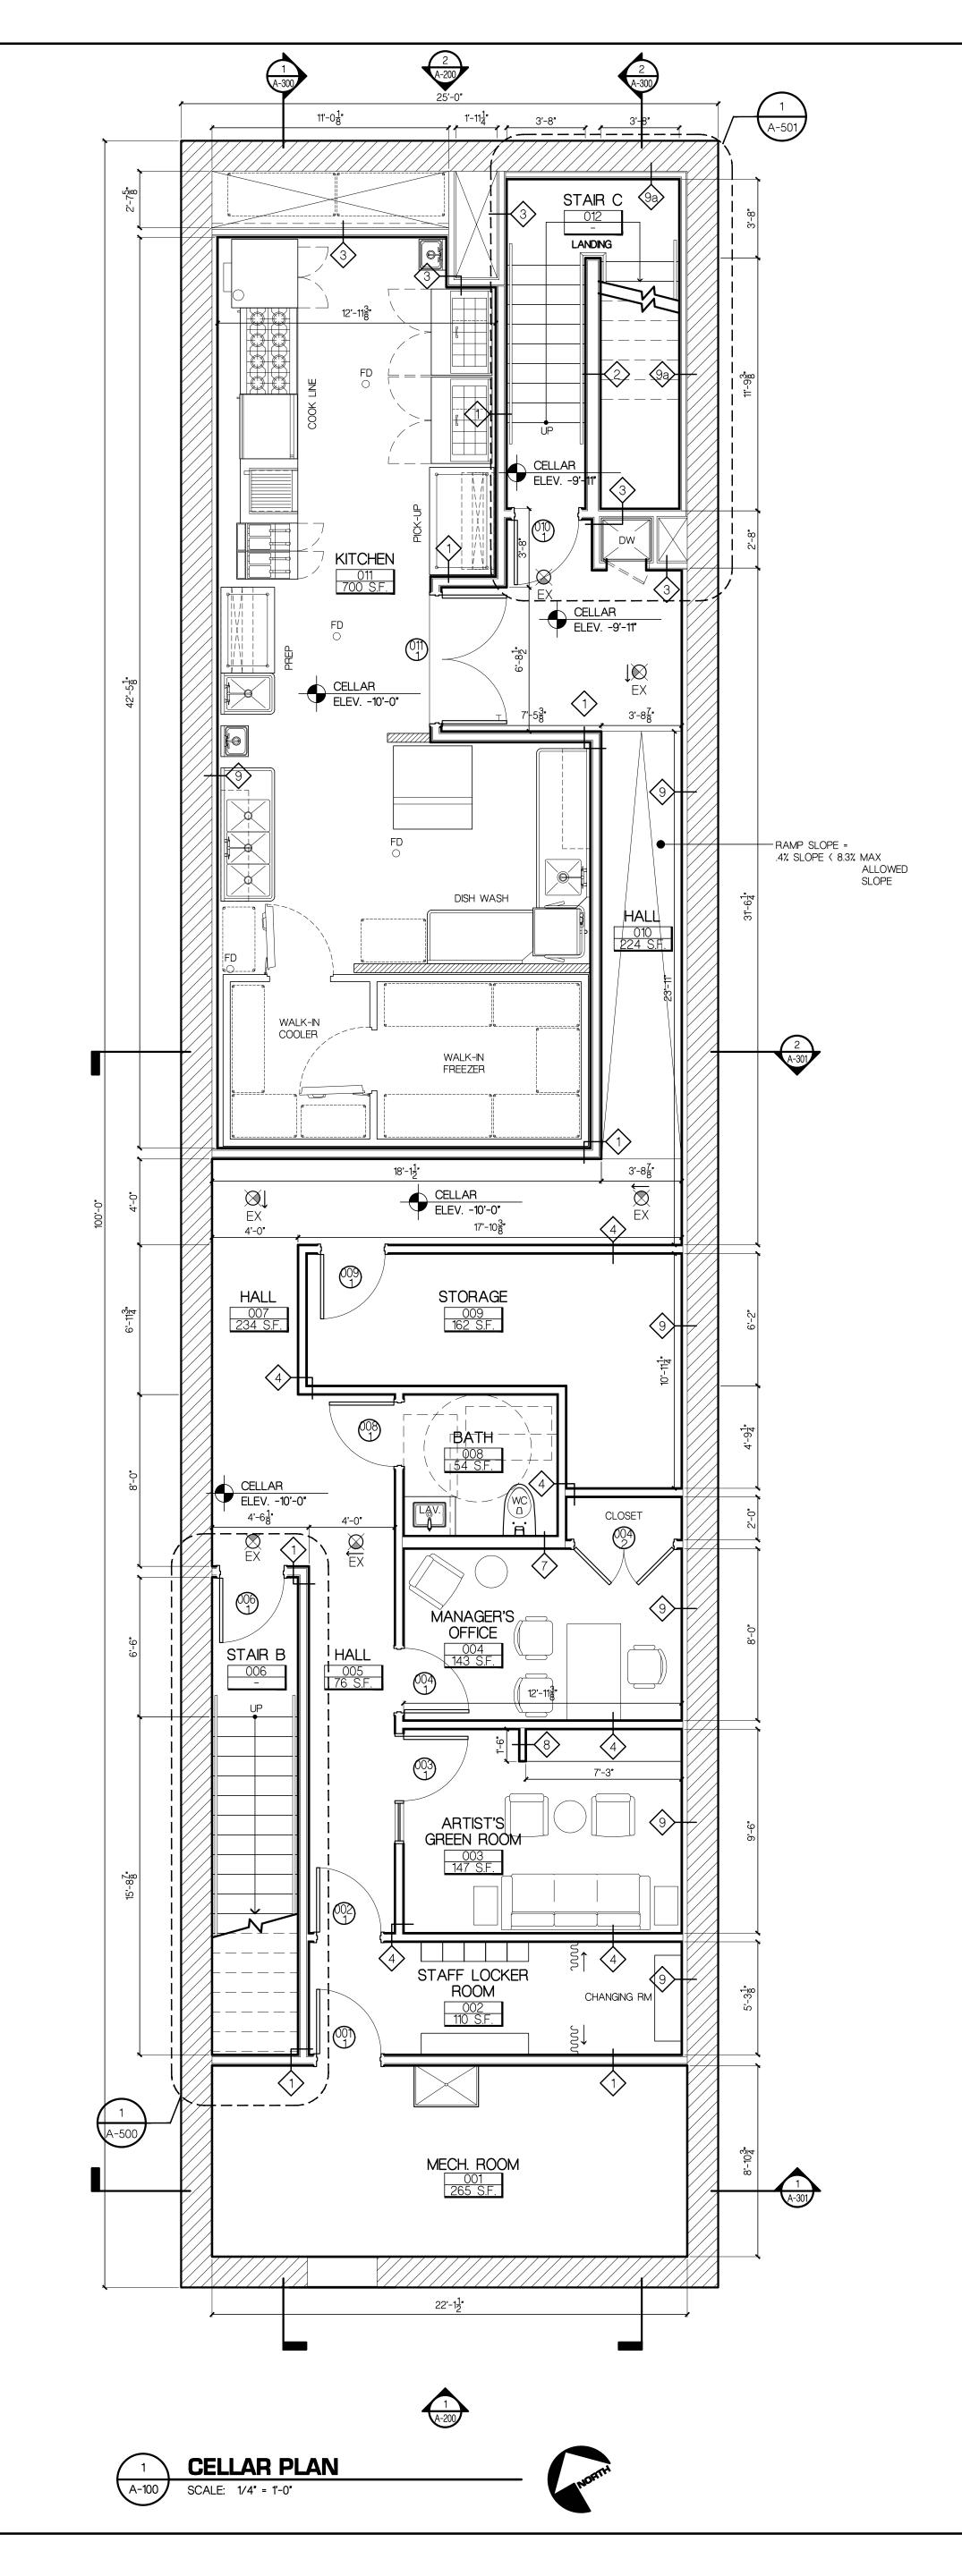

.

WWW.MOJOSTUMER.COM 14 Plaza Road (t) 516.625.3344 Greenvale, NY 11548 (f) 516.625.3418

.


This drawing is the property of Mojo Stumer Associates, P.C. & is not to be altered, reused or reproduced without written permission.

CONSULTANTS:

LANDMARKS PRESERVATION COMMISSION SET

DATE: DEC 06, 2022

DOB NOW JOB #:

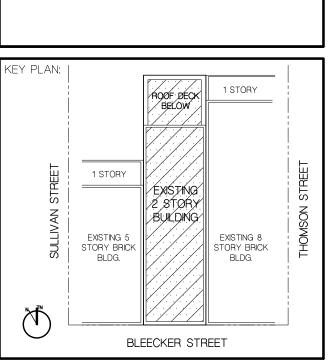


COMMERCIAL BUILDING ALTERATION 163 BLEECKER STREET

NEW YORK, NY 10021

PROJECT NUMBER: 2022.08

CELLAR PLAN

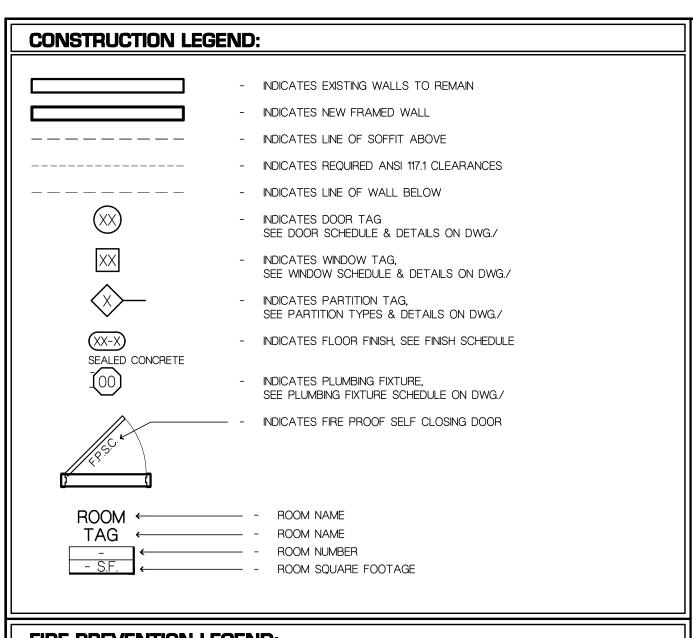

FIRE PREVENTION LEGEND:

- INDICATES COMBINATION SMOKE & CARBON MONOXIDE DETECTOR

- INDICATES CEILING MOUNTED EXIT SIGN

CONSTRUCTION NOTES:

- ALL DIMENSIONS TAKEN TO ROUGH FRAMING OR FACE OF MASONRY UNLESS SPECIFICALLY NOTED OTHERWISE. DIMENSIONS FROM EXISTING WALLS ARE TAKEN TO EXISTING FINISH..
- COORDINATE FINSH DIMENSIONS WITH ENLARGED CABINETRY PLANS AND REFLECTED CEILING PLAN DESIGNS.

REMOVAL OF ASBESTOS MUST BE PROVIDED TO THE OWNER PRIOR TO WORK.

PROVIDED TO THE OWNER AT THE COMPLETION OF WORK


- ALL BATHROOMS TO HAVE 5/8" MOLD RESISTANT GYPSUM WALL BOARD ON NEW WALLS & CEILINGS. ALL KITCHEN WALLS WITHIN 2 FEET OF SINK AND STOVE UP TO 4 FEET HIGH MUST USE % MOLD RESISTANT GYPSUM WALL BOARD.
- 4. ALL WALLS AND CEILINGS OF SPACES CONTAINING CONDENSERS, WATER TANKS, WATER PUMPS AND/OR PRESSURE REDUCTION VALVES MUST HAVE §" MOLD RESISTANT GYPSUM WALL BOARD.
- . ALL PLYWOOD USED TO BE FIRE-RESISTANT. . WHERE CHASES, SHAFTS, DEMSING WALLS AND STRUCTURAL ELEMENTS ARE OPENED DURING CONSTRUCTION, PROVIDE FIRESTOPPING AS
- REQUIRED BY CODE AT ALL EXISTING OR NEW OPENINGS. A UL RATED FIRESTOPPING SYSTEM IS TO BE PROVIDED AS MANUFACTURED BY STI, HILTI OR EQUAL (UL RATING ON SUBSTITUTIONS IS REQUIRED). FIRESTOPPING MUST BE COMPLETED ONCE DEMOLITION HAS BEEN

SMALL OPENINGS AND PIPE PENETRATIONS IN THE WALLS, FLOOR AND CEILING SLABS CAN BE FIRESTOPPED WITH HTLI PRODUCTS OR

8. THE PROJECT MUST BE FILED WITH THE NEW YORK CITY BUILDINGS DEPARTMENT. A PERMIT MUST BE OBTAINED AND COPY MUST BE PROVIDED TO THE OWNER PRIOR TO WORK AT THE COMPLETION OF WORK, A LETTER FROM THE NEW YORK CITY BUILDINGS DEPARTMENT INDICATING THAT THE WORK HAS BEEN SATISFACTORILY COMPLETED MUST BE PROVIDED TO THE OWNER.

9. A CERTIFICATE FROM A LICENSED ASBESTOS INVESTIGATOR INDICATING WHETHER THE PROJECT DOES OR DOES NOT INVOLVE THE

- D. ALL PLUMBING MUST BE PERFORMED BY A LICENSED PLUMBER AND FILED WITH THE NEW YORK CITY BULDINGS DEPARTMENT. THE WORK MUST BE APPROVED BY THE NEW YORK CITY BUILDINGS DEPARTMENT AT THE COMPLETION OF WORK
- I ALL ELECTRICAL WORK SHALL BE COMPLETED BY AN ELECTRICAN LICENSED BY THE CITY IF NEW YORK. THE ELECTRICAL WORK MUST BE FILED BY THE CONTRACTOR WITH THE BUREAU OF ELECTRICAL CONTROL AND A CERTIFICATE OF ELECTRICAL INSPECTION MUST BE
- 12. THE CONTRACTOR SHALL COMPLY WITH THE USE OF LEAD-SAFE PRACTICES FOR WORK IMPACTING 6 SQ. FT. OR MORE OF LEAD PAINT IN BUILDINGS ERECTED BEFORE 1978, AND ALL APPLICABLE STATE AND LOCAL REGULATIONS. PROPOSED WORK MUST COMPLY WITH THE FEDERAL EPA RULE ISSUED APRIL 22, 2008.

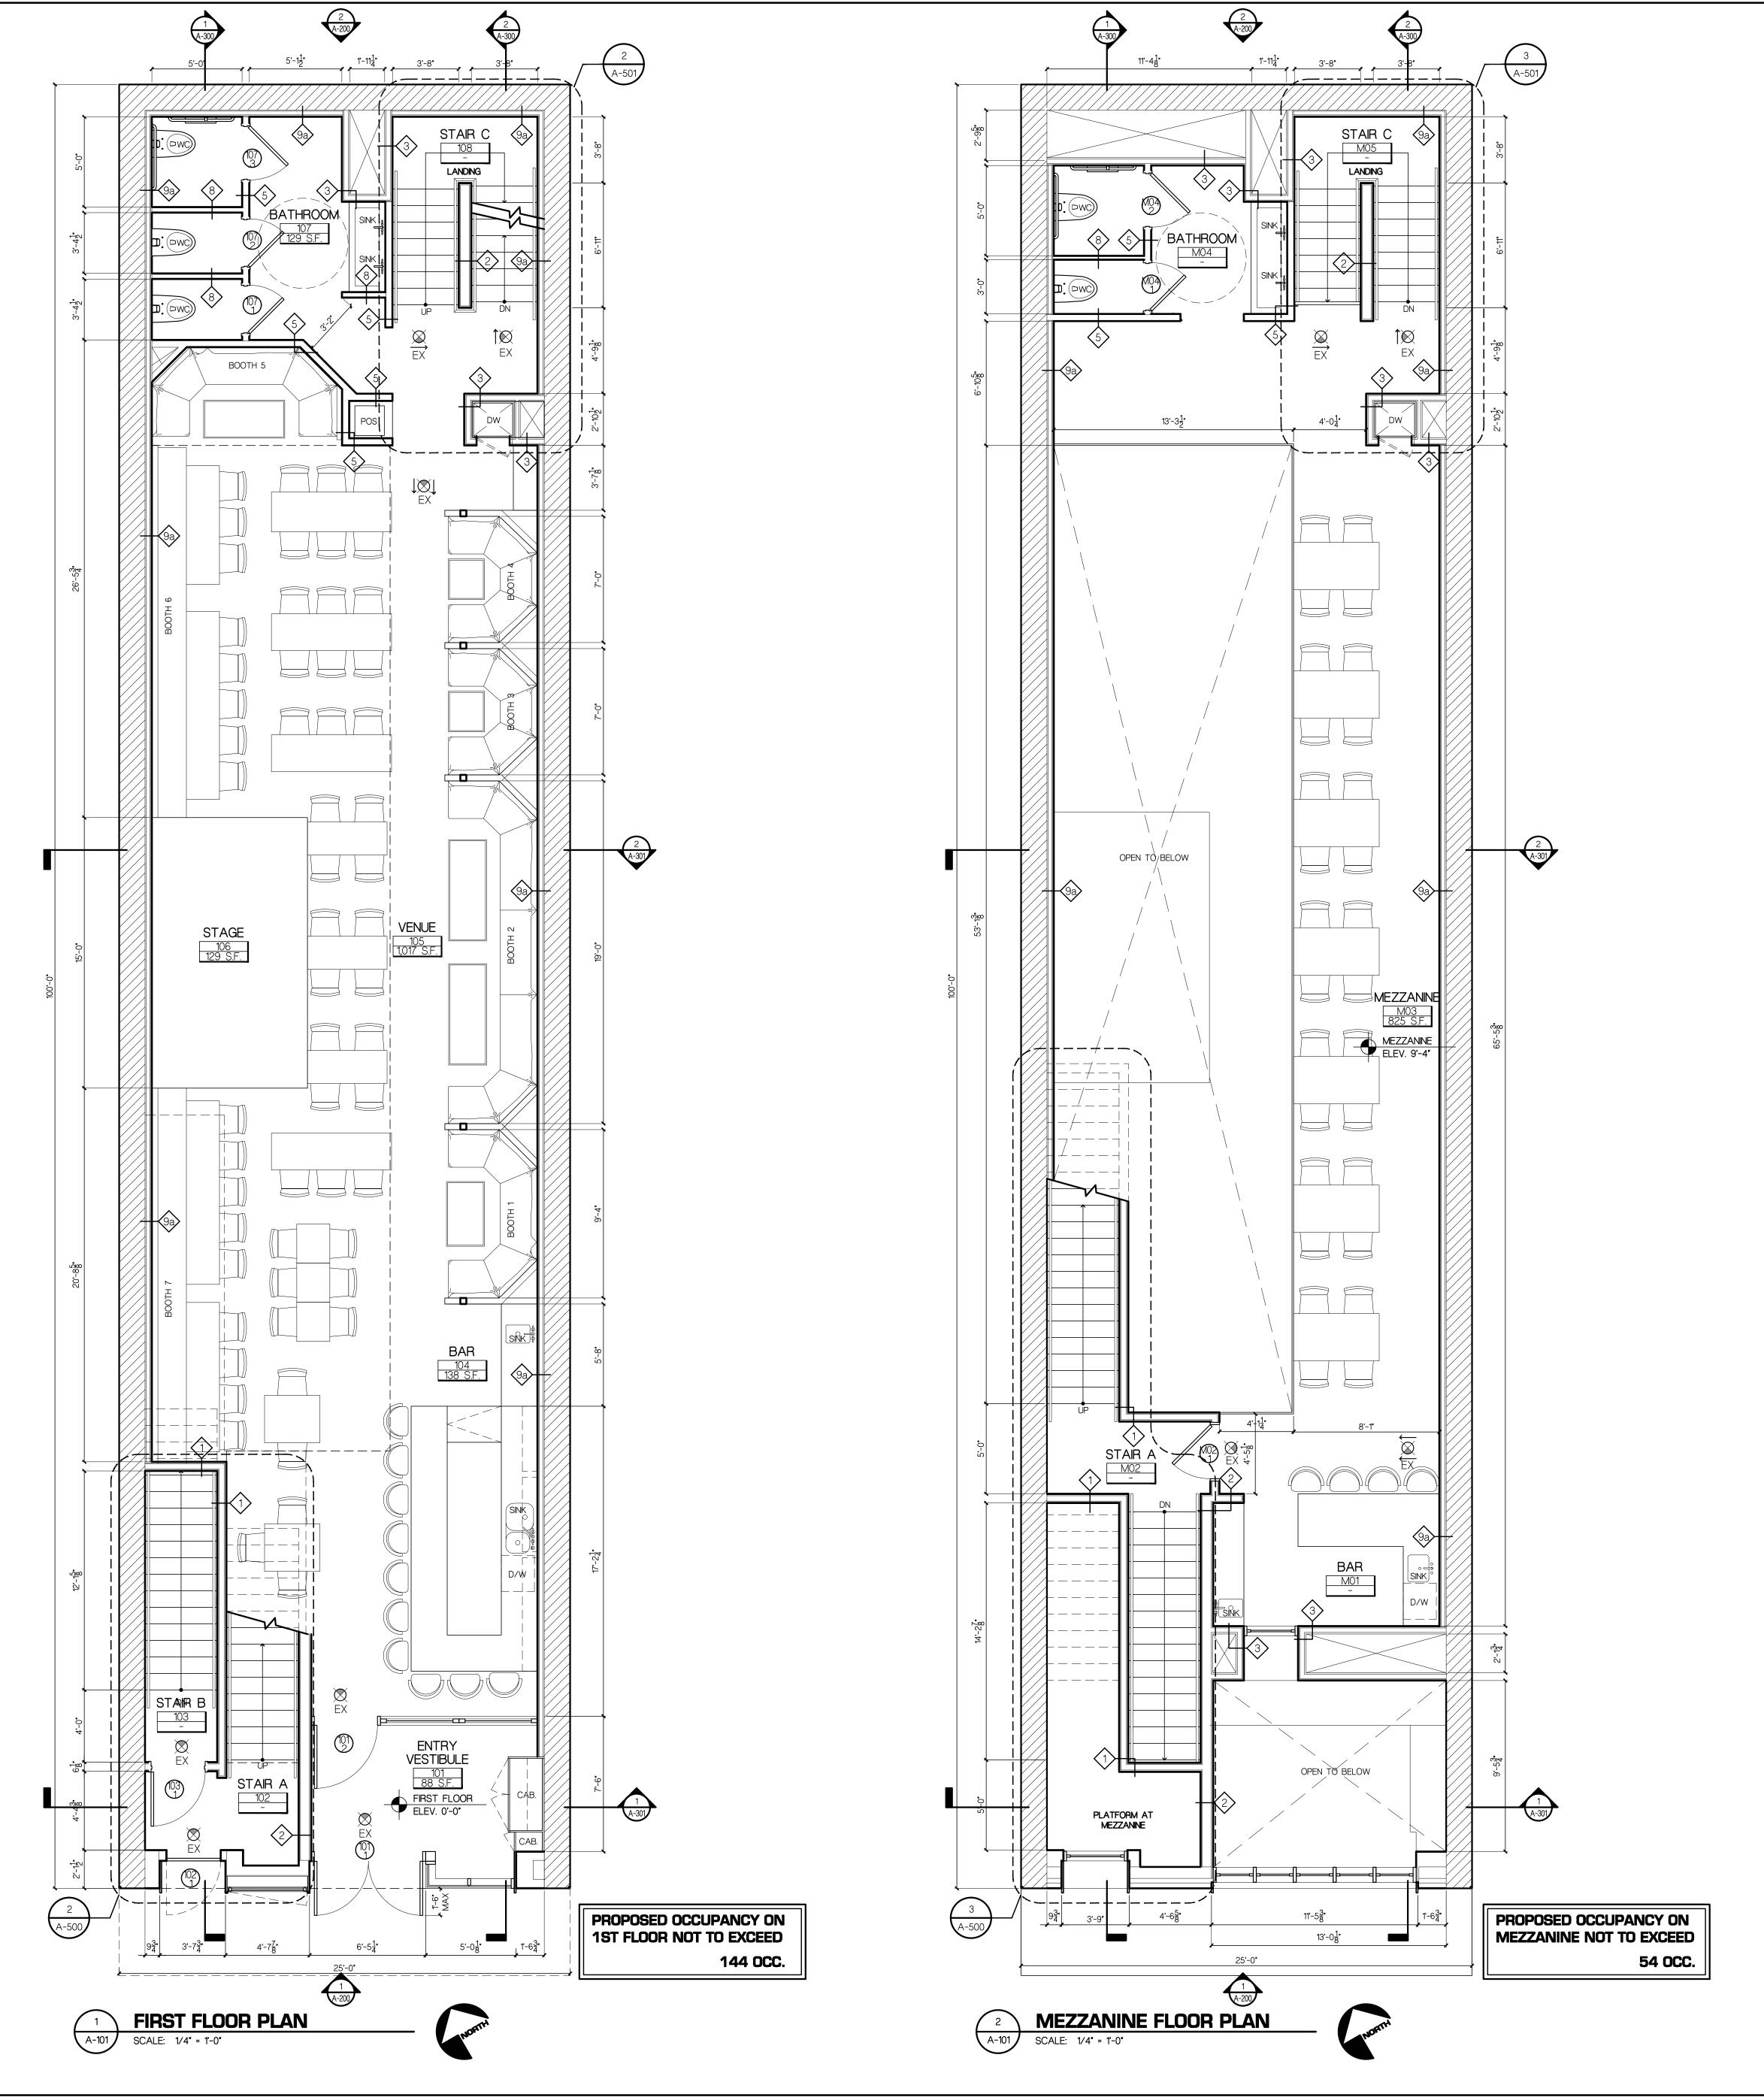

.

WWW.MOJOSTUMER.COM 14 Plaza Road Greenvale, NY 11548 (f) 516.625.3418

.


This drawing is the property of Mojo Stumer Associates, P.C. & is not to be altered, reused or reproduced without written permission.

CONSULTANTS:

LANDMARKS PRESERVATION COMMISSION SET

DATE: DEC 06, 2022

DOB NOW JOB #:

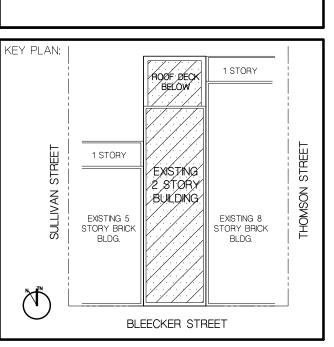


COMMERCIAL BUILDING ALTERATION 163 BLEECKER STREET

NEW YORK, NY 10021

PROJECT NUMBER: 2022.08

FIRST & MEZZANINE FLOOR PLANS

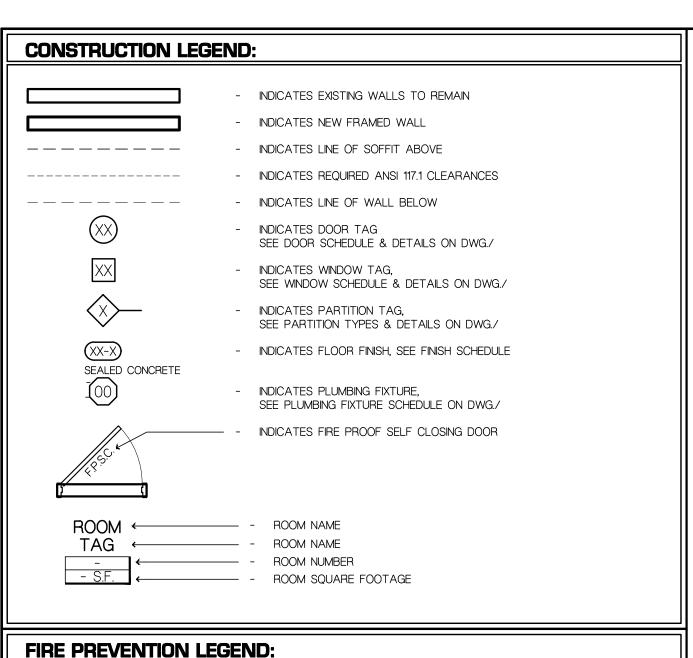

FIRE PREVENTION LEGEND:


- INDICATES COMBINATION SMOKE & CARBON MONOXIDE DETECTOR

_ - INDICATES CEILING MOUNTED EXIT SIGN

CONSTRUCTION NOTES:

PROVIDED TO THE OWNER AT THE COMPLETION OF WORK

- ALL DIMENSIONS TAKEN TO ROUGH FRAMING OR FACE OF MASONRY UNLESS SPECIFICALLY NOTED OTHERWISE. DIMENSIONS FROM EXISTING WALLS ARE TAKEN TO EXISTING FINISH..
- COORDINATE FINSH DIMENSIONS WITH ENLARGED CABINETRY PLANS AND REFLECTED CEILING PLAN DESIGNS.
- ALL BATHROOMS TO HAVE 5/8" MOLD RESISTANT GYPSUM WALL BOARD ON NEW WALLS & CEILINGS. ALL KITCHEN WALLS WITHIN 2 FEET OF SINK AND STOVE UP TO 4 FEET HIGH MUST USE % MOLD RESISTANT GYPSUM WALL BOARD.
- 4. ALL WALLS AND CEILINGS OF SPACES CONTAINING CONDENSERS, WATER TANKS, WATER PUMPS AND/OR PRESSURE REDUCTION VALVES MUST HAVE 🖁 MOLD RESISTANT GYPSUM WALL BOARD.
- . ALL PLYWOOD USED TO BE FIRE-RESISTANT. . WHERE CHASES, SHAFTS, DEMISING WALLS AND STRUCTURAL ELEMENTS ARE OPENED DURING CONSTRUCTION, PROVIDE FIRESTOPPING AS REQUIRED BY CODE AT ALL EXISTING OR NEW OPENINGS. A UL RATED FIRESTOPPING SYSTEM IS TO BE PROVIDED AS MANUFACTURED BY
- STI, HILTI OR EQUAL (UL RATING ON SUBSTITUTIONS IS REQUIRED). FIRESTOPPING MUST BE COMPLETED ONCE DEMOLITION HAS BEEN SMALL OPENINGS AND PIPE PENETRATIONS IN THE WALLS, FLOOR AND CEILING SLABS CAN BE FIRESTOPPED WITH HITLI PRODUCTS OR
- 8. THE PROJECT MUST BE FILED WITH THE NEW YORK CITY BUILDINGS DEPARTMENT. A PERMIT MUST BE OBTAINED AND COPY MUST BE PROVIDED TO THE OWNER PRIOR TO WORK AT THE COMPLETION OF WORK, A LETTER FROM THE NEW YORK CITY BUILDINGS DEPARTMENT INDICATING THAT THE WORK HAS BEEN SATISFACTORILY COMPLETED MUST BE PROVIDED TO THE OWNER. 9. A CERTIFICATE FROM A LICENSED ASBESTOS INVESTIGATOR INDICATING WHETHER THE PROJECT DOES OR DOES NOT INVOLVE THE REMOVAL OF ASBESTOS MUST BE PROVIDED TO THE OWNER PRIOR TO WORK.
- D. ALL PLUMBING MUST BE PERFORMED BY A LICENSED PLUMBER AND FILED WITH THE NEW YORK CITY BULDINGS DEPARTMENT. THE WORK MUST BE APPROVED BY THE NEW YORK CITY BUILDINGS DEPARTMENT AT THE COMPLETION OF WORK
- I. ALL ELECTRICAL WORK SHALL BE COMPLETED BY AN ELECTRICAN LICENSED BY THE CITY IF NEW YORK. THE ELECTRICAL WORK MUST BE FILED BY THE CONTRACTOR WITH THE BUREAU OF ELECTRICAL CONTROL AND A CERTIFICATE OF ELECTRICAL INSPECTION MUST BE
- 12. THE CONTRACTOR SHALL COMPLY WITH THE USE OF LEAD-SAFE PRACTICES FOR WORK IMPACTING 6 SQ. FT. OR MORE OF LEAD PAINT IN BUILDINGS ERECTED BEFORE 1978, AND ALL APPLICABLE STATE AND LOCAL REGULATIONS. PROPOSED WORK MUST COMPLY WITH THE FEDERAL EPA RULE ISSUED APRIL 22, 2008.

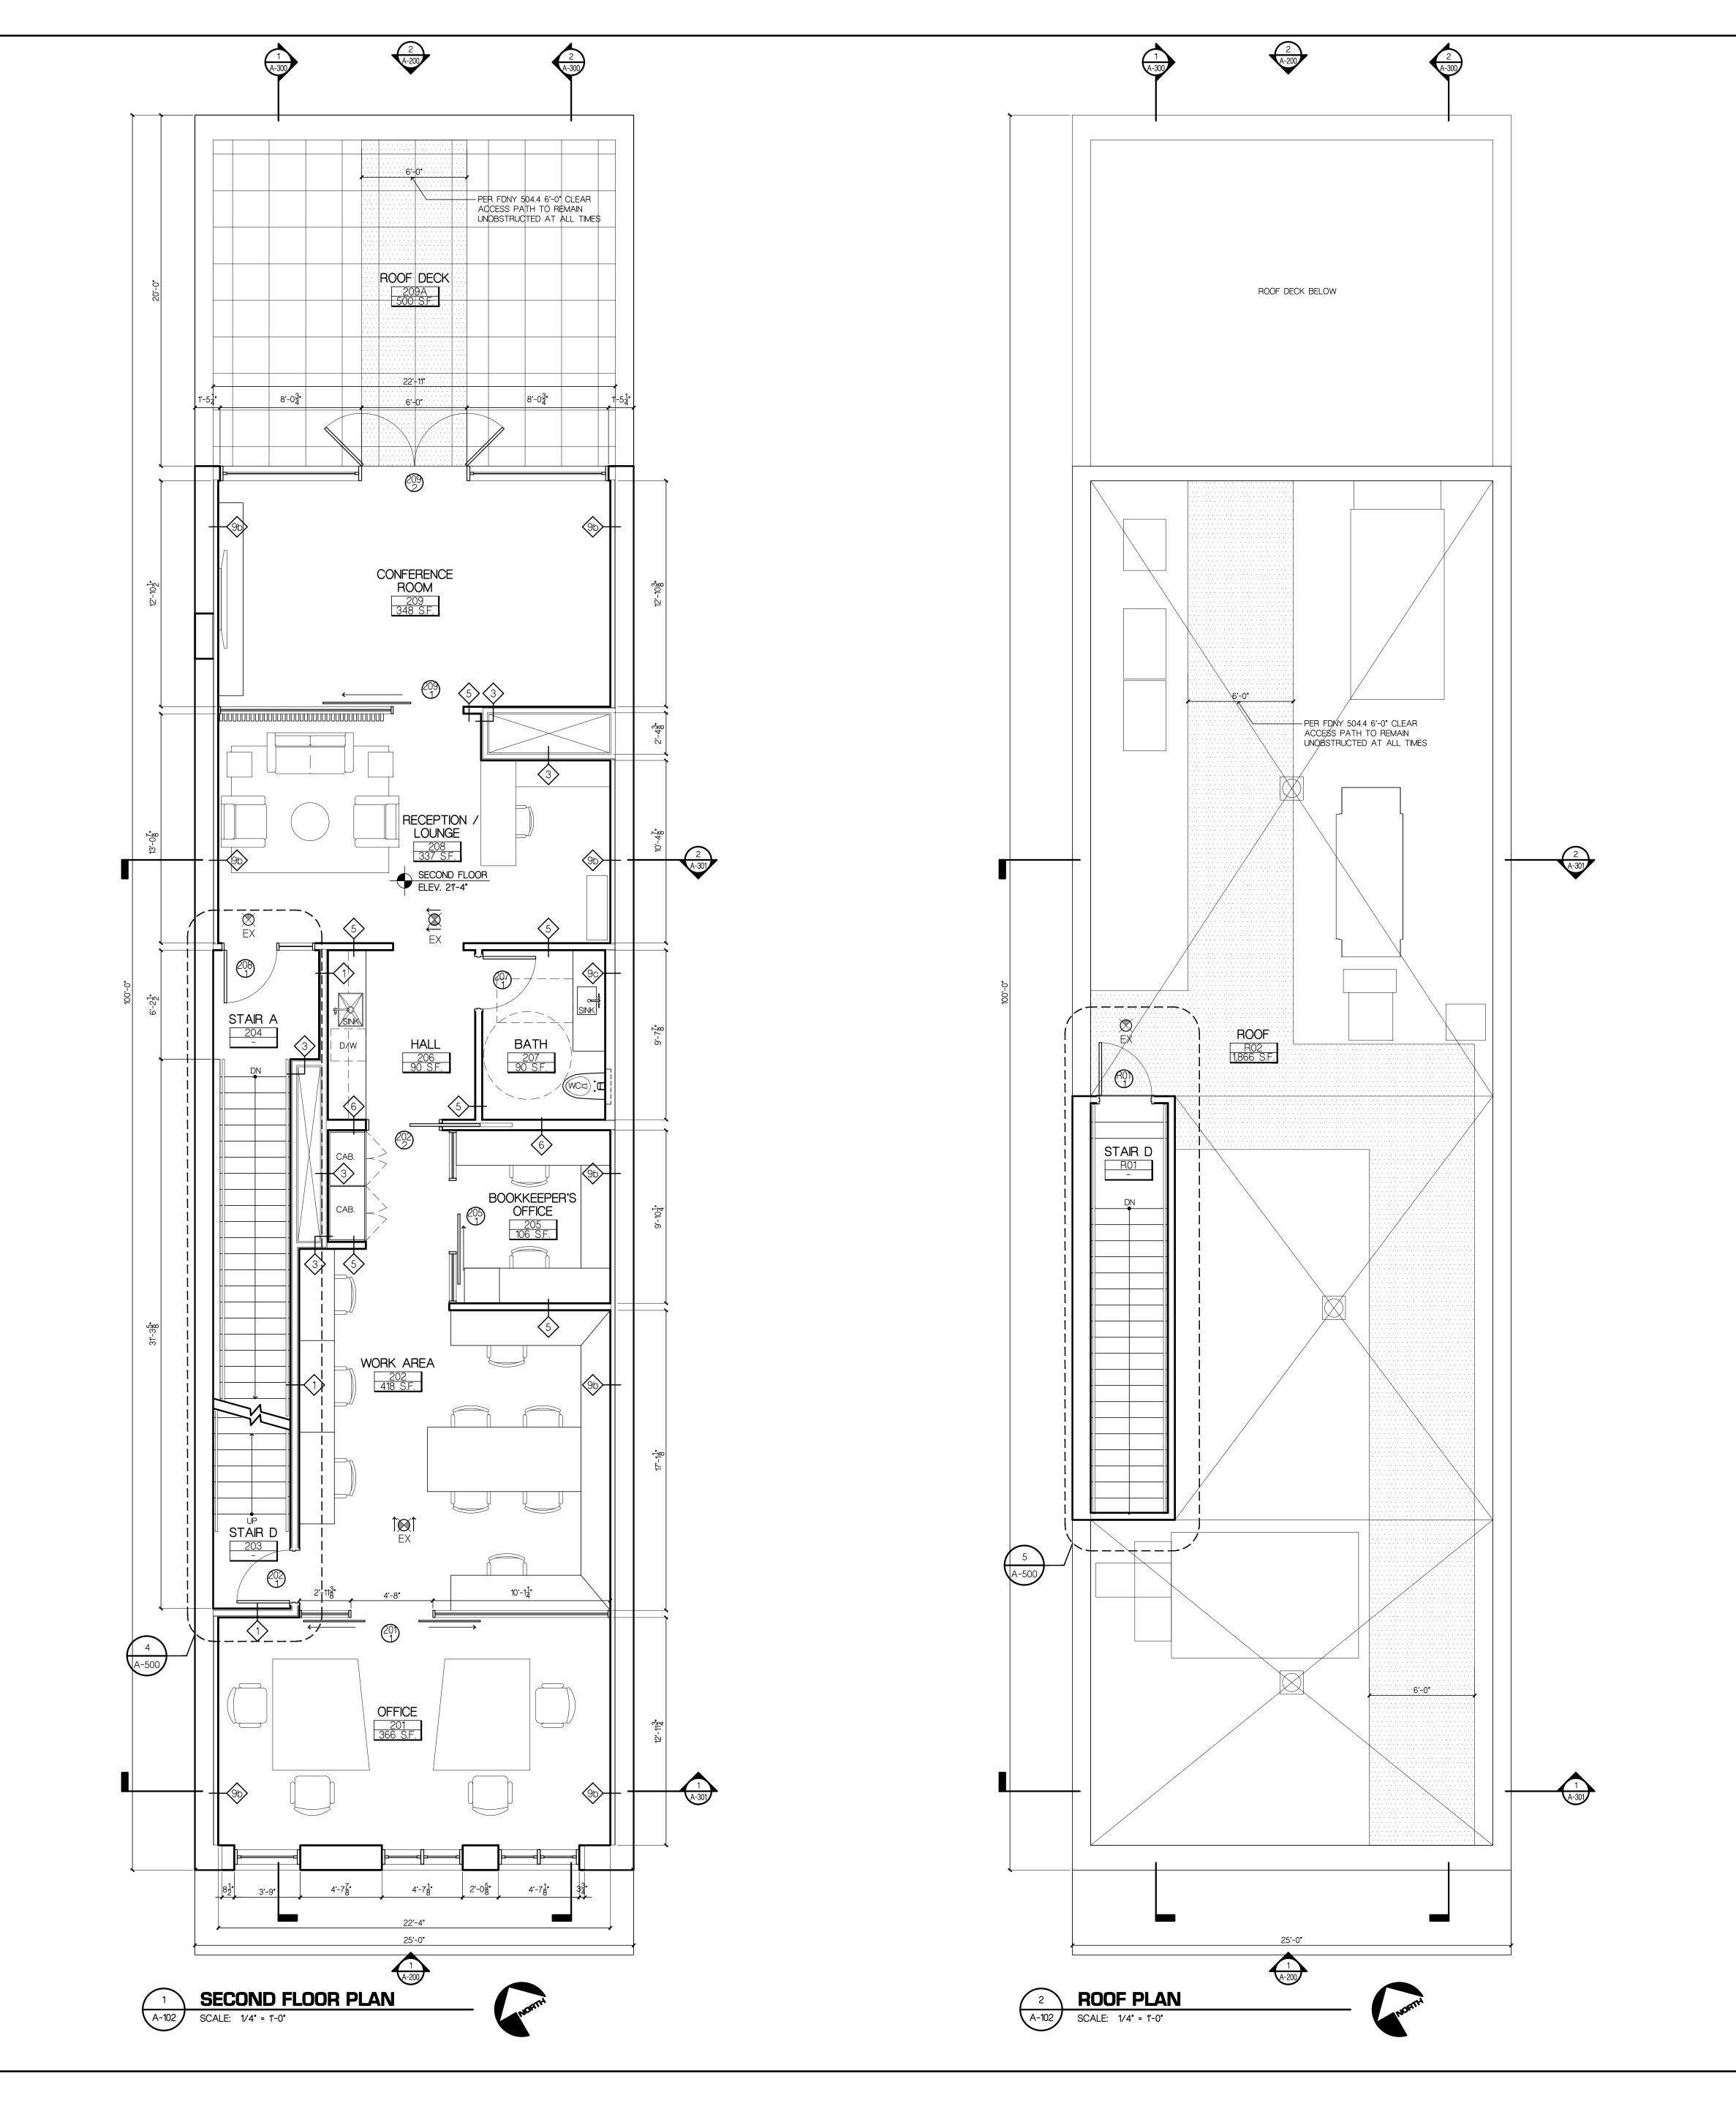

.

WWW.MOJOSTUMER.COM 14 Plaza Road (t) 516.625.3344 Greenvale, NY 11548 (f) 516.625.3418


This drawing is the property of Mojo Stumer Associates, P.C. & is not to be altered, reused or reproduced without written permission.

CONSULTANTS:

.

LANDMARKS PRESERVATION COMMISSION SET

DATE: DEC 06, 2022

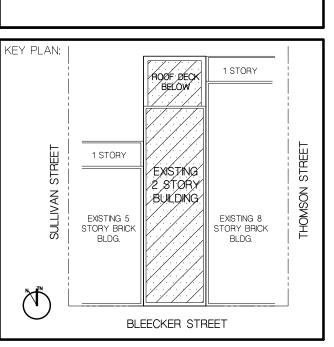



COMMERCIAL BUILDING ALTERATION 163 BLEECKER STREET


NEW YORK, NY 10021

PROJECT NUMBER: 2022.08

SECOND & ROOF FLOOR PLANS

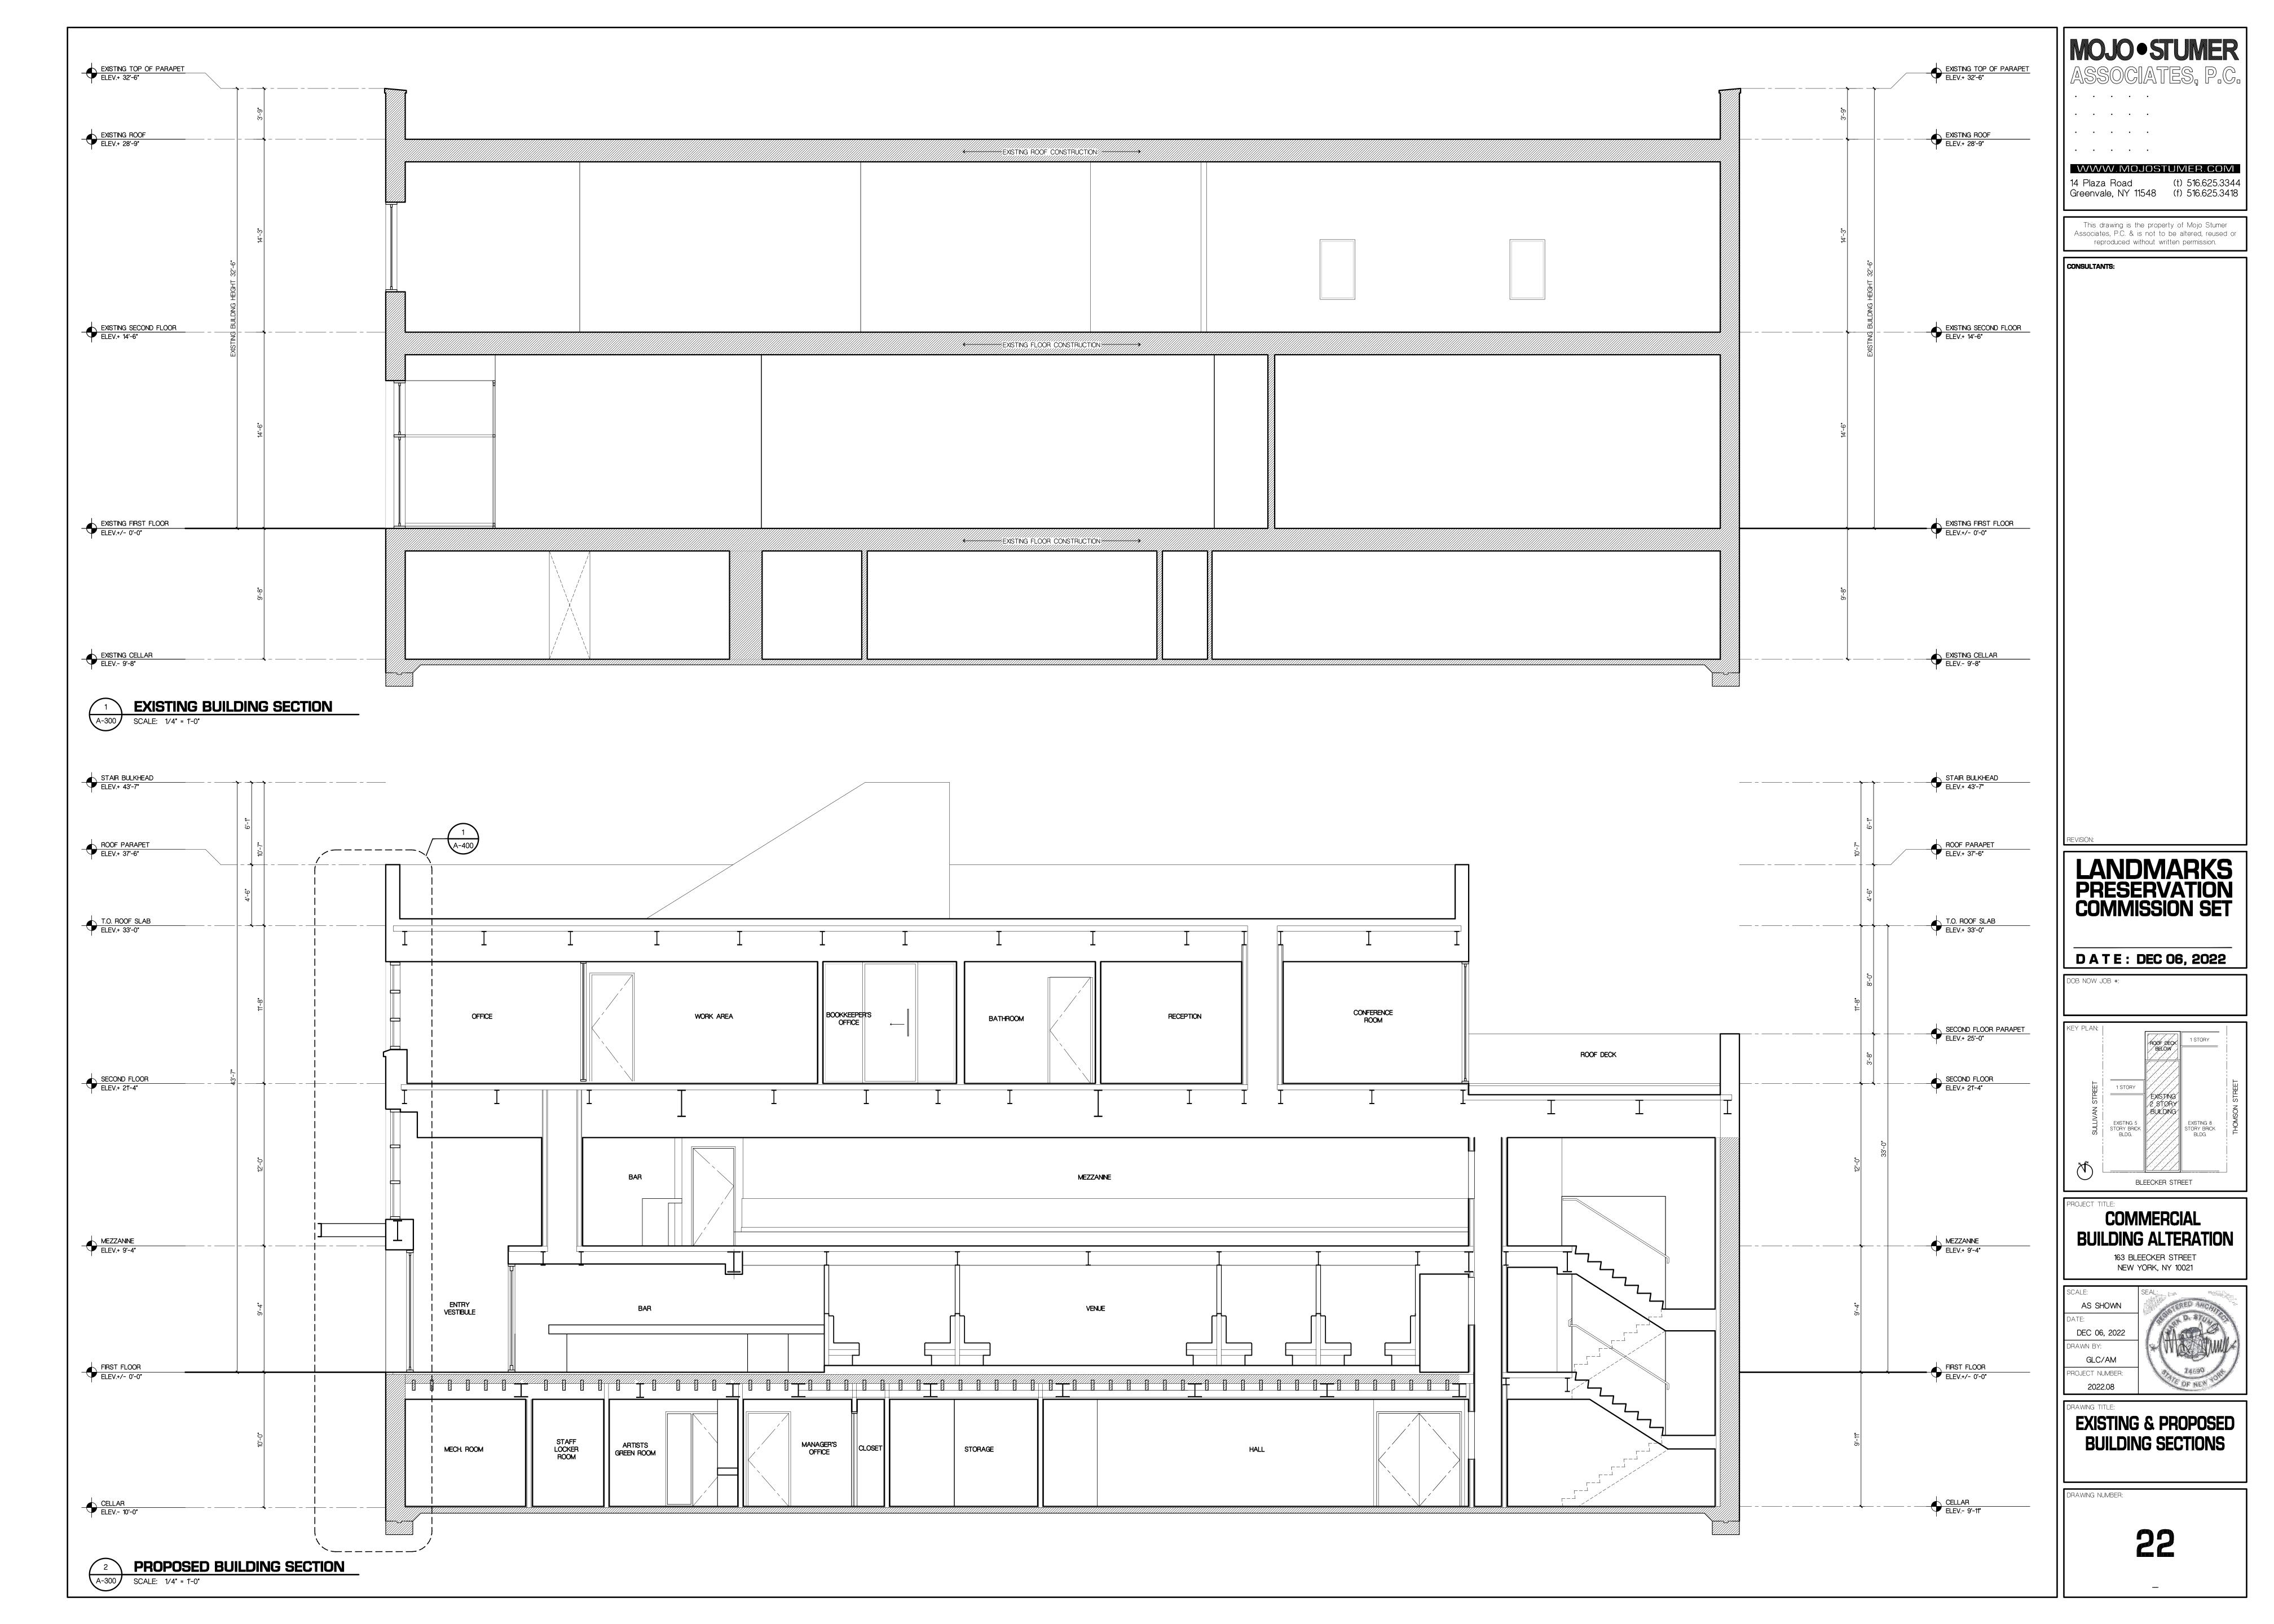

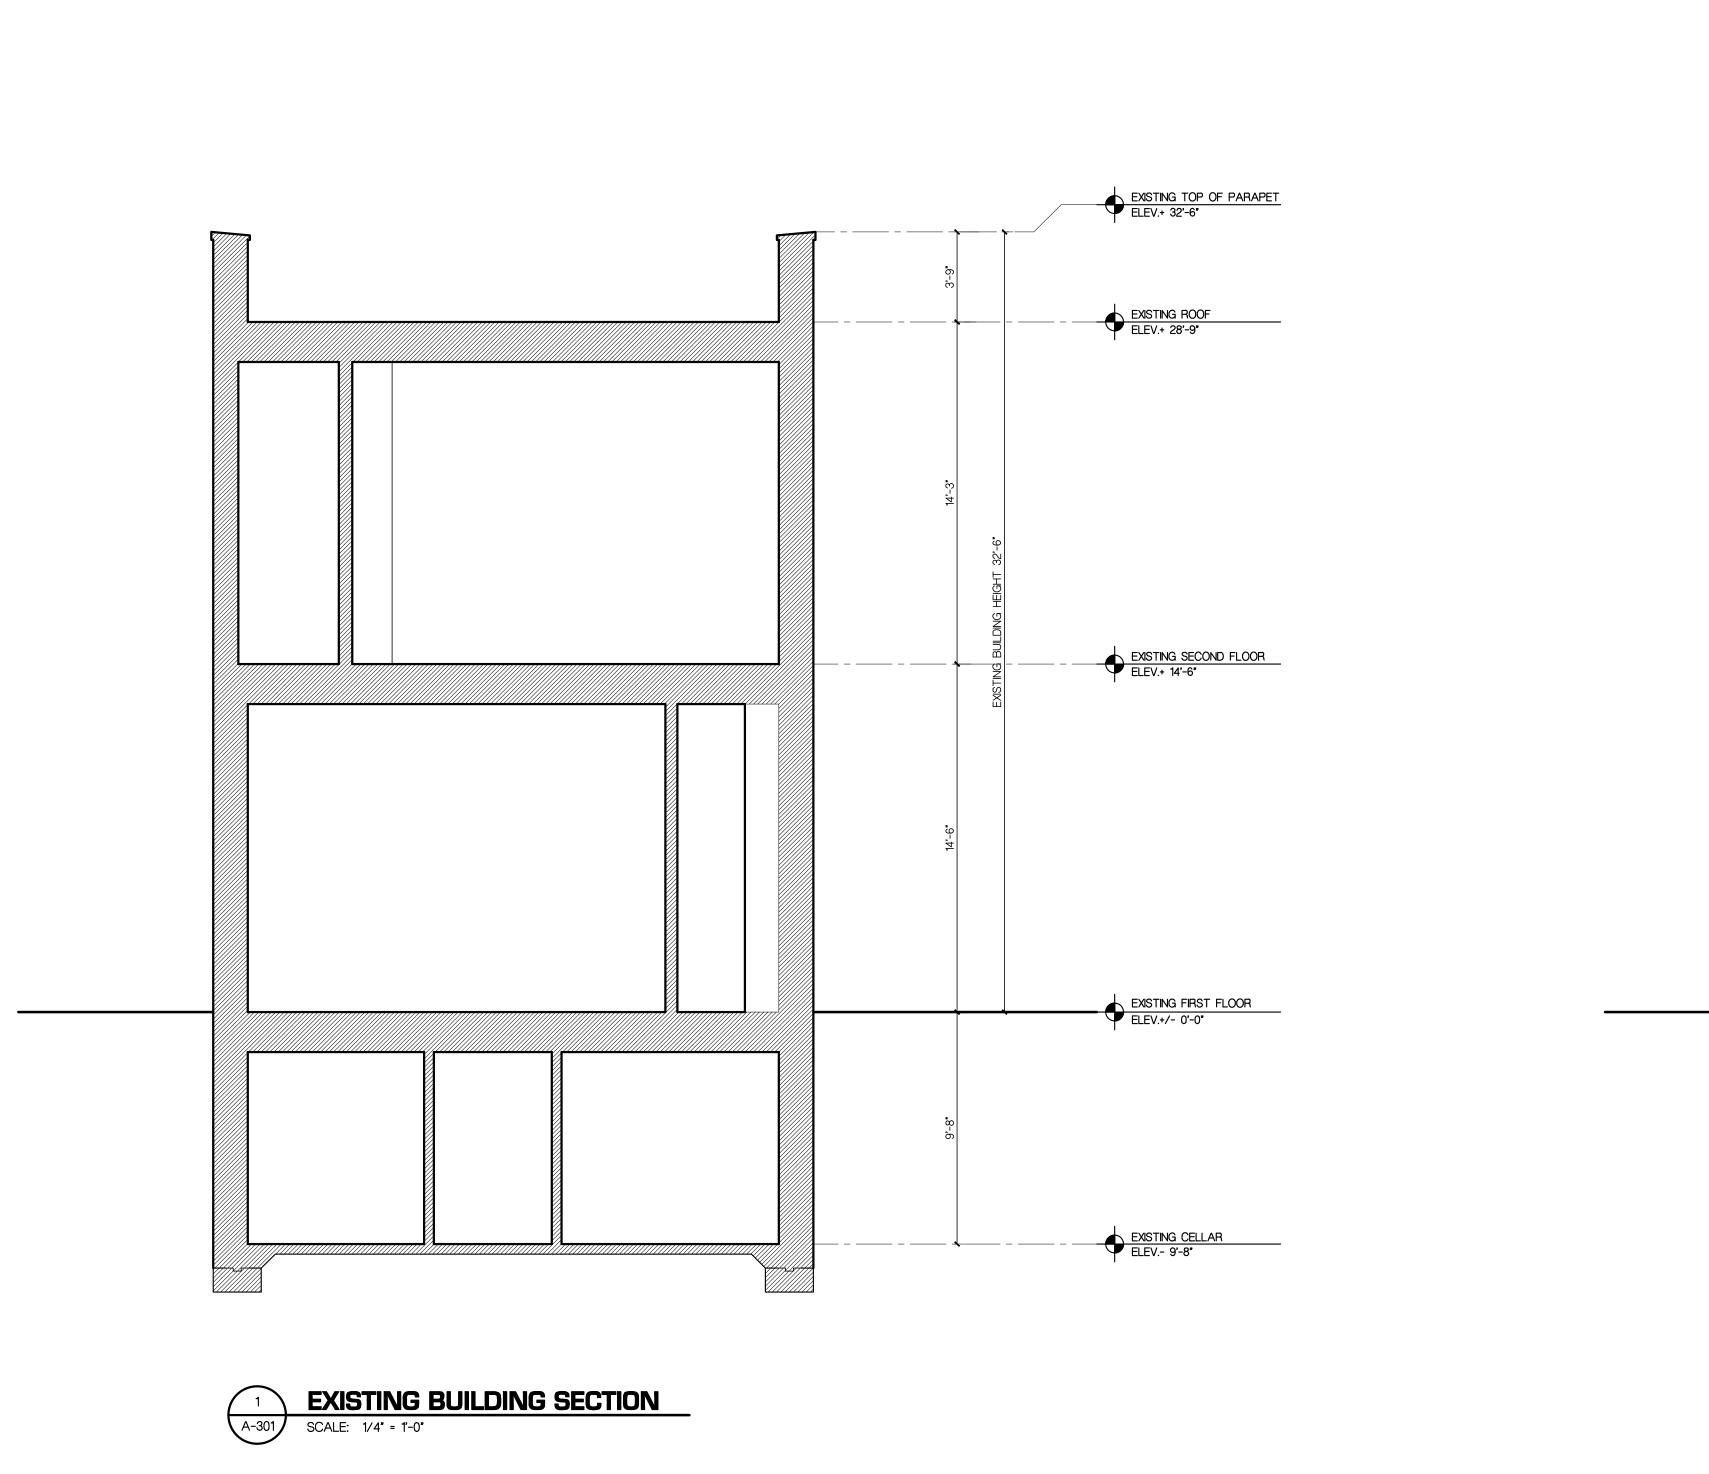

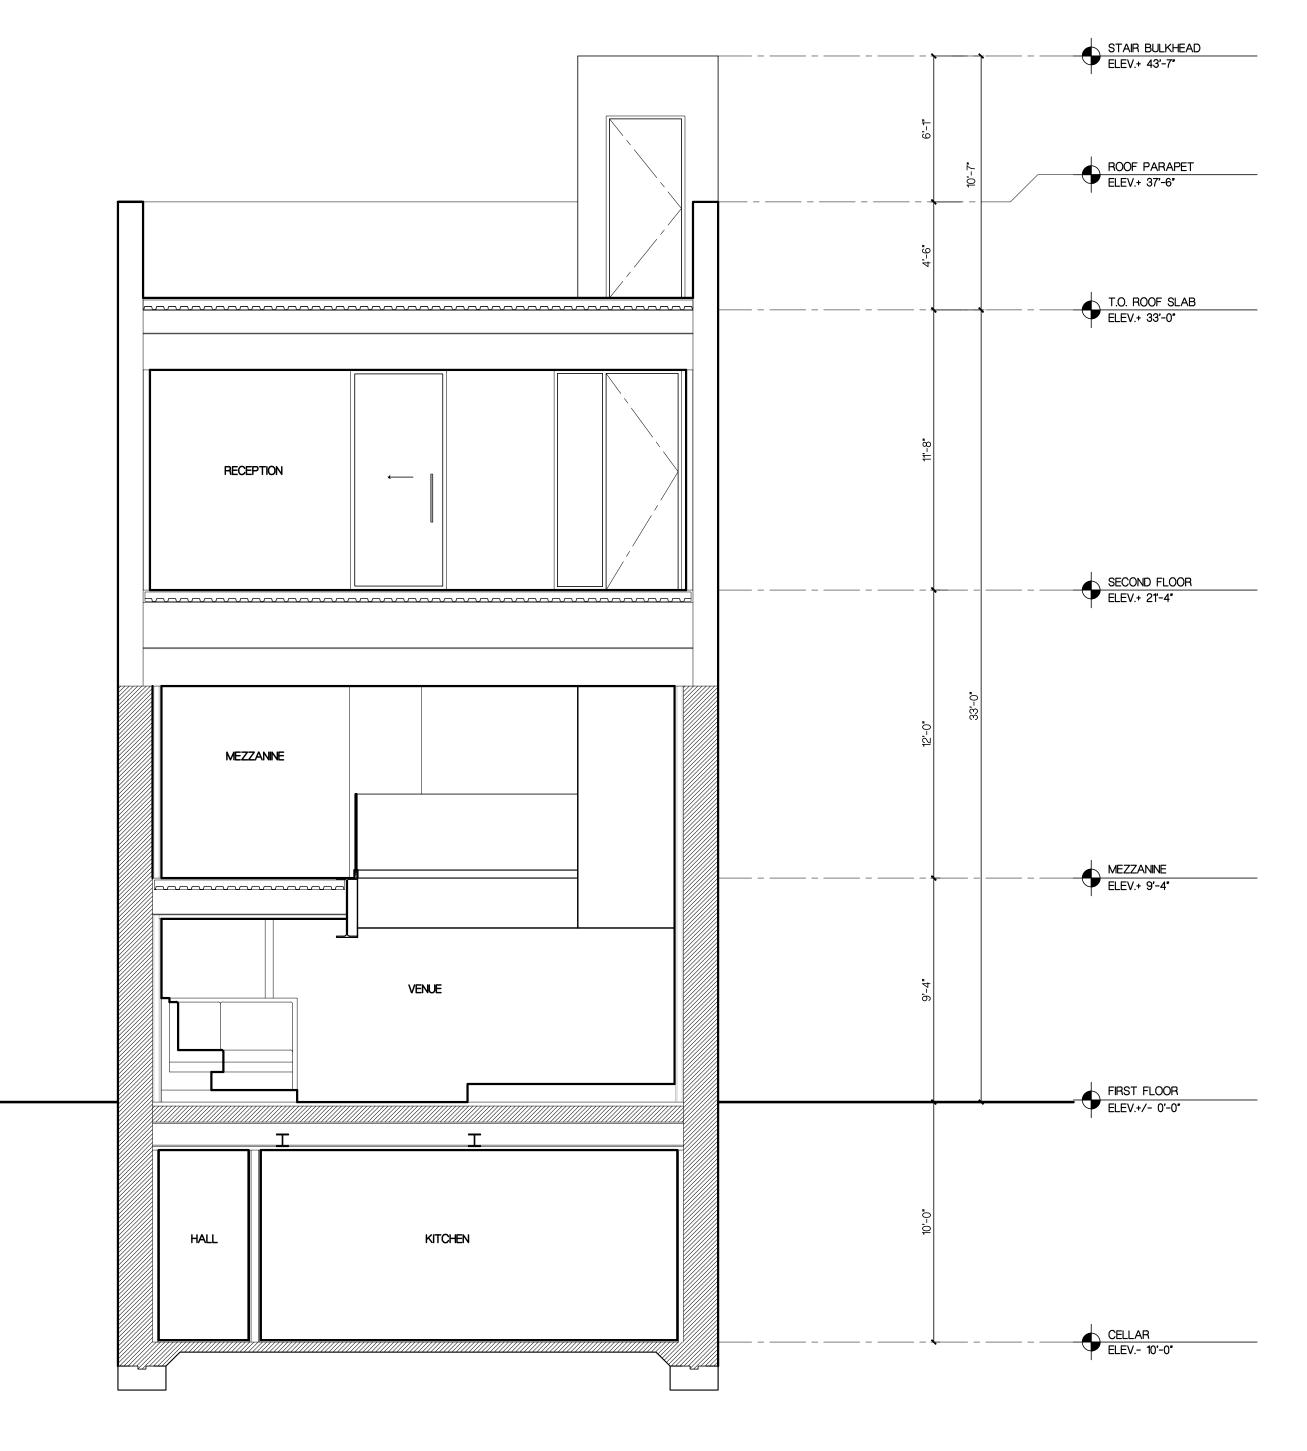

PROPOSED BUILDING SECTION

SCALE: 1/4' = 1'-0'

This drawing is the property of Mojo Stumer Associates, P.C. & is not to be altered, reused or reproduced without written permission.

WWW.MOJOSTUMER.COM


14 Plaza Road (t) 516.625.3344 Greenvale, NY 11548 (f) 516.625.3418

ONSULTANTS:

LANDMARKS PRESERVATION COMMISSION SET

DATE: DEC 06, 2022

DOB NOW JOB #:

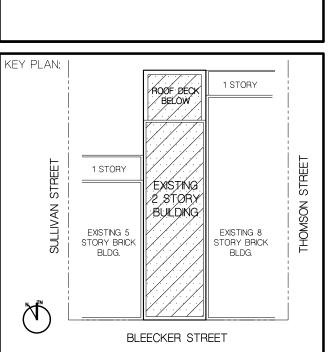

COMMERCIAL
BUILDING ALTERATION

163 BLEECKER STREET

163 BLEECKER STREET NEW YORK, NY 10021

SCALE:

AS SHOWN

DATE:

DEC 06, 2022

DRAWN BY:


GLC/AM

PROJECT NUMBER:

2022.08

EXISTING & PROPOSED BUILDING SECTIONS

DRAWING NUMBER

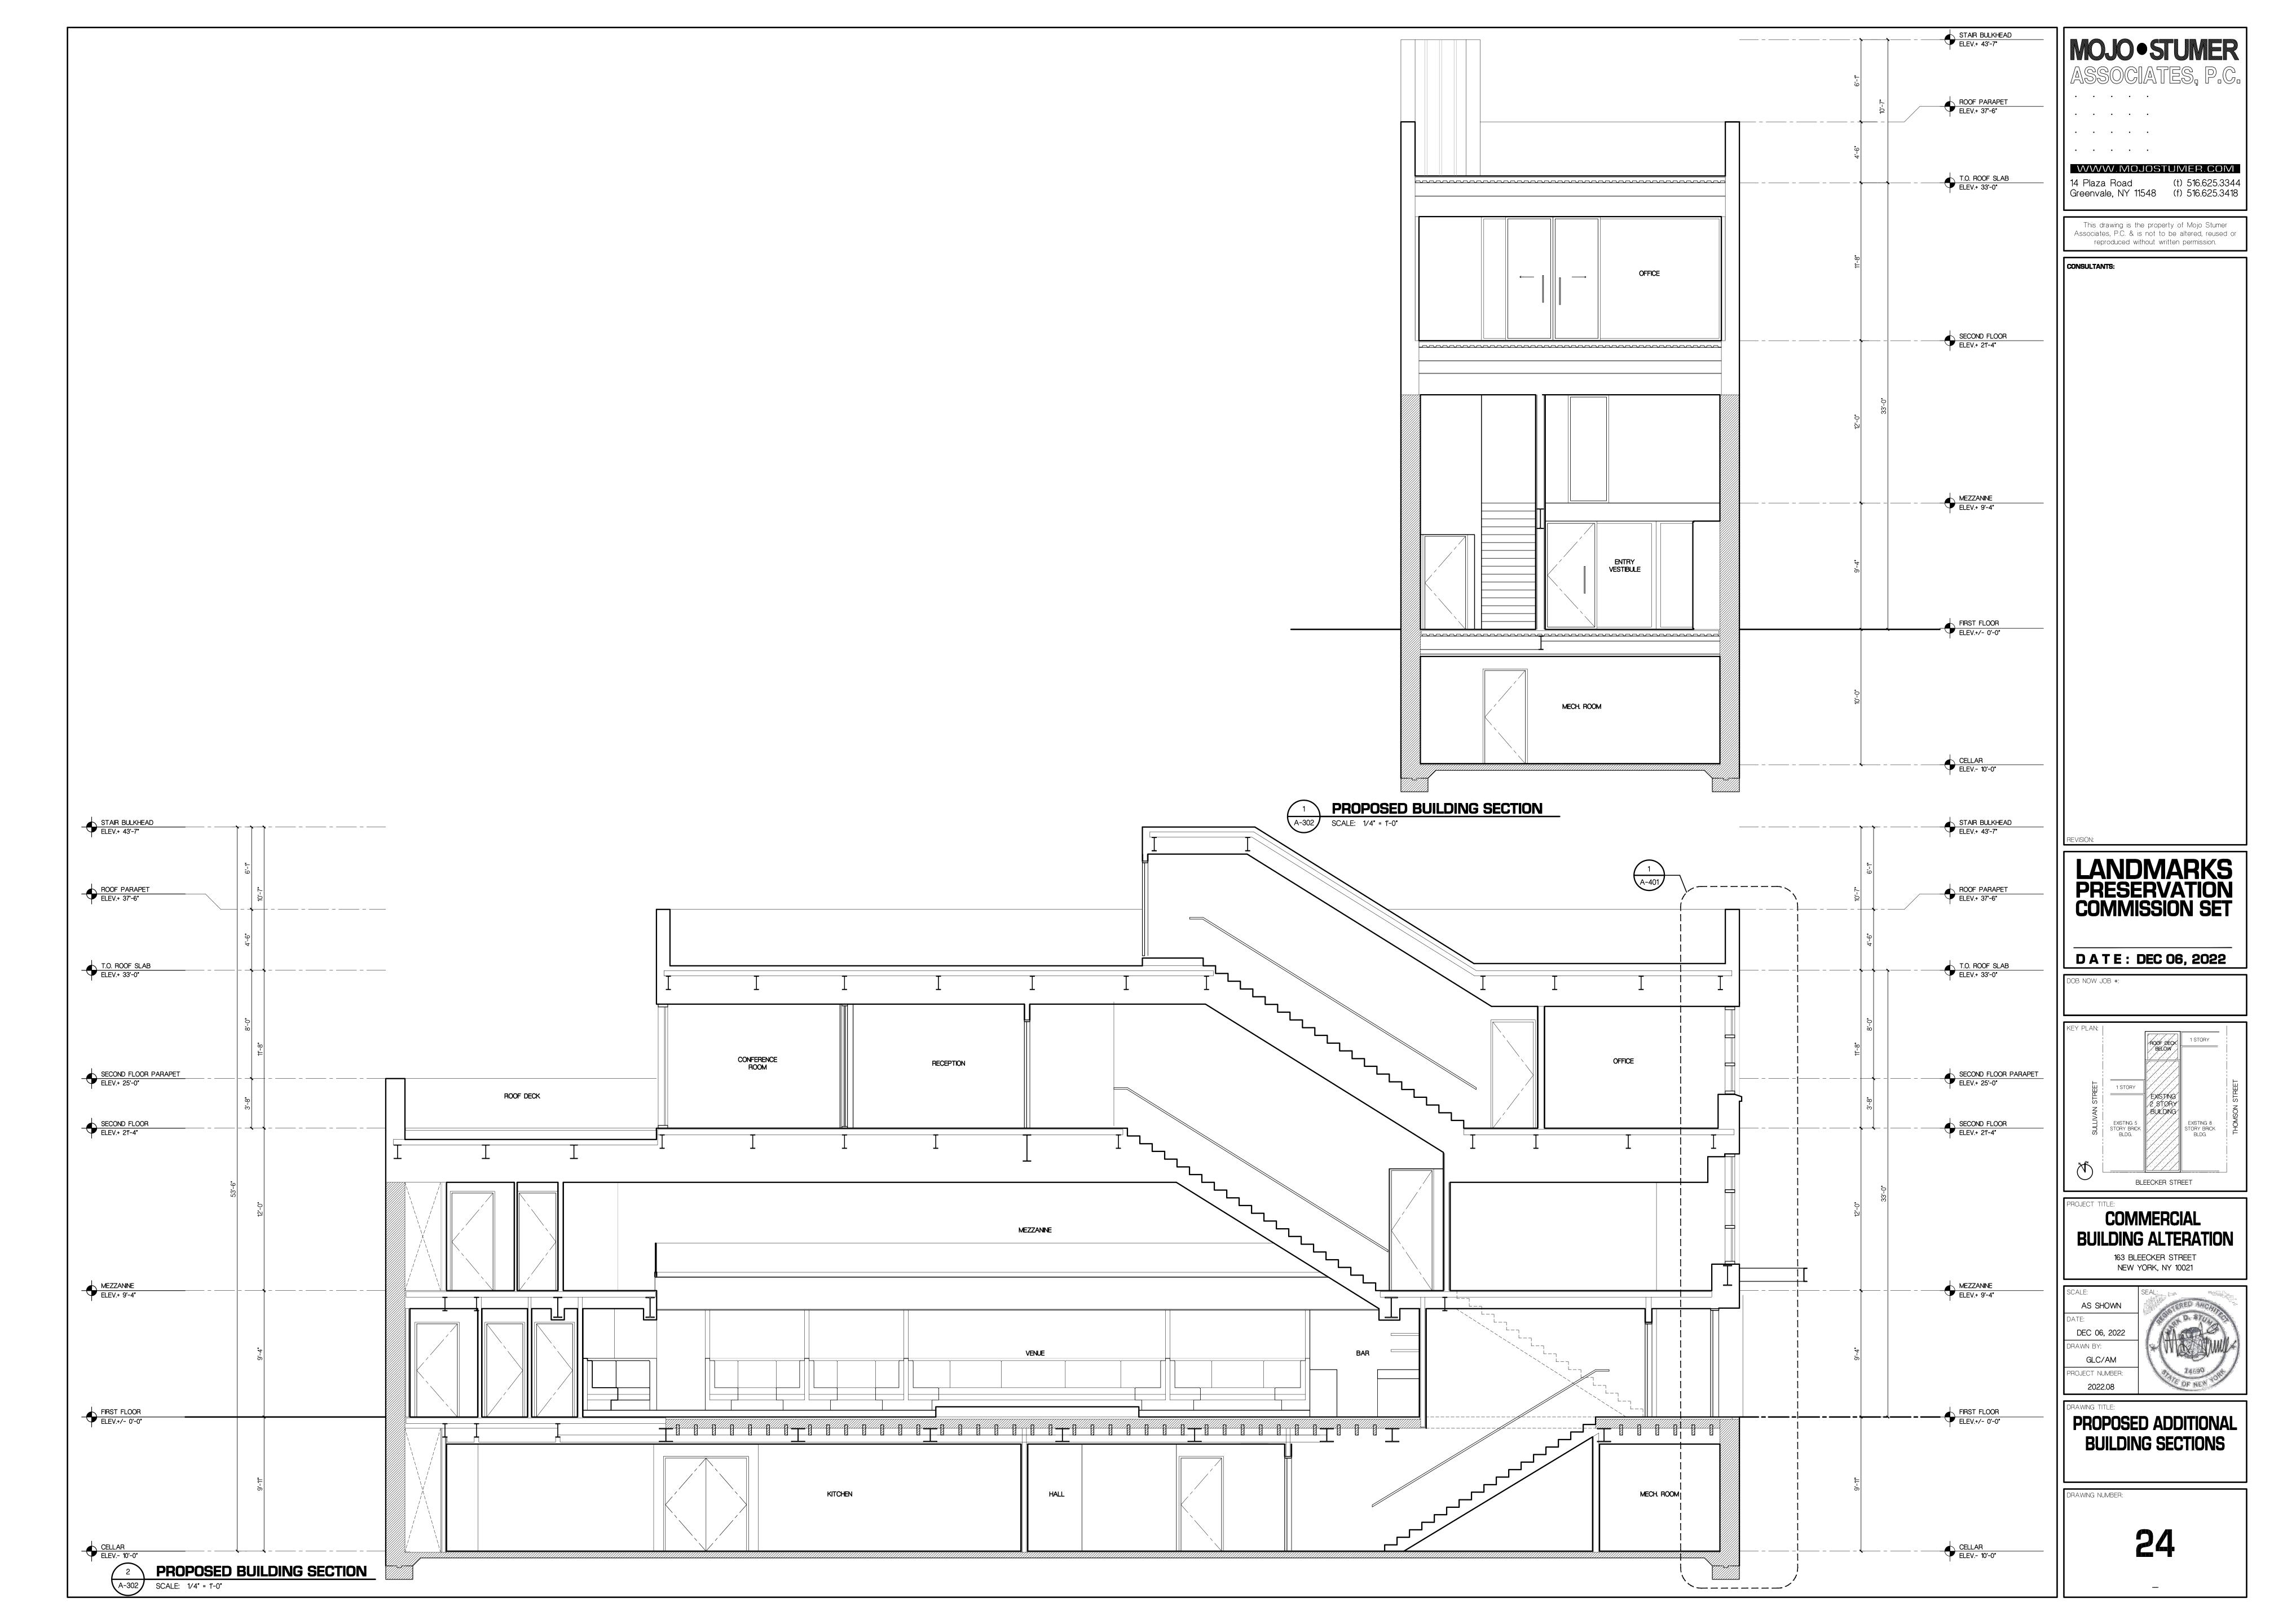



The current proposal is:

Preservation Department – Item 1, LPC-23-00996

163 Bleecker Street – South Village Historic District Borough of Manhattan

Note: this is a Public Meeting item. No public testimony will be received today as the hearing on this item is closed